

## **NEW SAYERS FOOD STORE**

SUBJECT Addendum No. 4 PROJECT 2102 DATE September 27, 2021 PAGES 3

#### ADDENDUM No. 4

#### 1. General Information:

Tender closing is extended per REVISION to DIVISION 00 - INSTRUCTION TO BIDDERS, 05.2 Bid Closing Time:

a. Before 2:00 pm local time, as determined by the clock located in the location for receiving bids on **Thursday, September 30**;

Additional Addendum covering questions regarding the following will be issued by end-of-day, Tuesday, Sept. 28:

- A020 Assemblies;
- A320 Typ. Section Details;
- A500 Interior Elevations;
- A900 Millwork;

## 2. Architectural Drawings

Refer to Clouded Revisions for the following sheets:

- A100 Ground Level Floor Plan
- A101 Level 2 Floor Plan
- A102 Roof Plan
- A150 Ground Level Reflected Ceiling Plan
- A151 Level 2 Reflected Ceiling Plan
- A200 Building Elevations
- A300 Building Sections
- A310 Wall Sections
- A311 Wall Sections
- A312 Wall Sections Sheet Added
- A510 Interior Wall Sections Sheet Added

## 3. Mechanical Drawings

Refer to Mechanical Addendum M-2

#### 3. Questions

The following Addendum No. 4 is issued to answer questions related to the following questions by bidders:

**4.1** What is going on the ceiling in the vestibule and bakery areas?

**Answer:** Refer to revised Reflected Ceiling Plans (A150,A151), Wall Sections (A312), Interior Wall Sections (A510).

- 4.2 The drawings refer to A301 and A500 but they are not included. Are these going to be added?

  Answer: Tags for A301 have been updated to A300 as there is only one page of Building Sections. A500 will be added in a subsequent addendum.
- 4.3 Can we have an extension on the close date of this project to give our trades time to price once we receive the outstanding RFI's?

Answer: Yes, refer to General Information for revised closing date.

- 4.4 I am a little confused. I spoke with the refrigeration contractor spec'd in addendum 3 and he mentioned that he already sent the quote to yourself and the ownership. Are we to carry the supply and install or not?

  Answer: Per Addendum 3, "Contractor to supply and install refrigeration system to service all display & walkin coolers/freezers." This has been clarified with Oxford Energy Solutions Inc.
- 4.5 We have been doing grocery stores for 35+ years and have never worked with the 3 contractors. I am not saying they aren't capable. But we would not feel comfortable working with a refrigeration contractor we have never worked with before, on a hard-tender project. Are you sure you don't want to let the following contractors bid?
  - Crossroads Refrigeration
  - Mapleridge Mechanical
  - Neeland Refrigeration
  - Erin Refrigeration
  - Scottys Refrigeration

These refrigeration contractors specialize in Grocery stores.

**Answer:** Given the specific installation requirements of the system, please use Acceptable Installers listed on A450 (Addendum #3).

#### 4.6 Interior Finishing Questions:


- 1. Drawing A100, partition PC3 @ Gridline 7a. This looks to be the wrong partition, as PC3 is a 3 5/8" wall, yet it is wider than the connected 6" wall.
- 2. Drawing A100, partition PC1. Construction for this wall assembly is missing.
- 3. Drawings A310 & A311, parapets PA1 & PA2. Construction for these parapets is missing.
- 4. Drawing A101, Gridline 5. This is shown as wall type W2A, but is also shown in wall section 1/A311 as wall type W2B. Which is it?
- 5. Drawing A101, Gridline 5a. This is shown as wall type W4A, but is also shown in wall section 2/A311 as wall type W1A. Construction for W1A is missing. What is this wall supposed to be? Drawing 3/A300, Gridline A. Wall section circled, indicating a blown-up detail, but no detail given. Is there a missing detail, or was this not supposed to be circled in the first place?
- 6. Drawing A150, ceiling CC1 &CC2. No details given for this ceiling type, other than "cement cladding board and batten texture". No information on panel sizes, material, manufacturer, colour, installation, etc., and not mentioned in specs. We also need to know if there is backup framing required for installation (T-Bar, furring channels, etc.) so that we can price accordingly.
- 7. Same issue as above, on same drawing, with ceiling WDS1. No details given for this ceiling type, and not mentioned in specs
- 8. Drawing A150, "ceiling" TL01. According to 2/A800 (Interior Finishes Legend), this is floor tile.
- 9. Drawing A150, ceiling FRB. No details given for this acronym at all.
- 10. Is the Hardie panels on the board and batten installation all one colour.? DWP 1, 2,3
- 11. Please provide Spacing of the battens and size of the Battens?

- 12. Is there interior Hardie panels A500 not in tender set?
- 13. Is metal MT3 painted structural steel or metal panel? If panel what is the material as the size is to large for metal flashings and will oilcan?
- 14. Will you be providing more details and blown up wall sections for parapet construction and wall constructions, canopy construction?
- 15. Roxul insulation deliveries are running approx. 6 months, is there another insulation that can be used in the exterior wall assemblies?

#### Answer:

- Refer to revised Arch. Drawings;
- Additional information on interior assemblies, typ. exterior details, AND interior elevations to be issued in subsequent addendum (Tuesday, Sept. 28).
- Roxul Insulation Equivalent alternative insulations can be submitted for Architect Review during Construction:
- 4.7 I just received a price for an alternate entrance mat to what was in the specification from KN Crowder. Can you please let me know if this would be accepted? I have attached the cut sheet (See FM-14 cut sheet):

  Answer: No, please use specified 'Grate Mat XT.

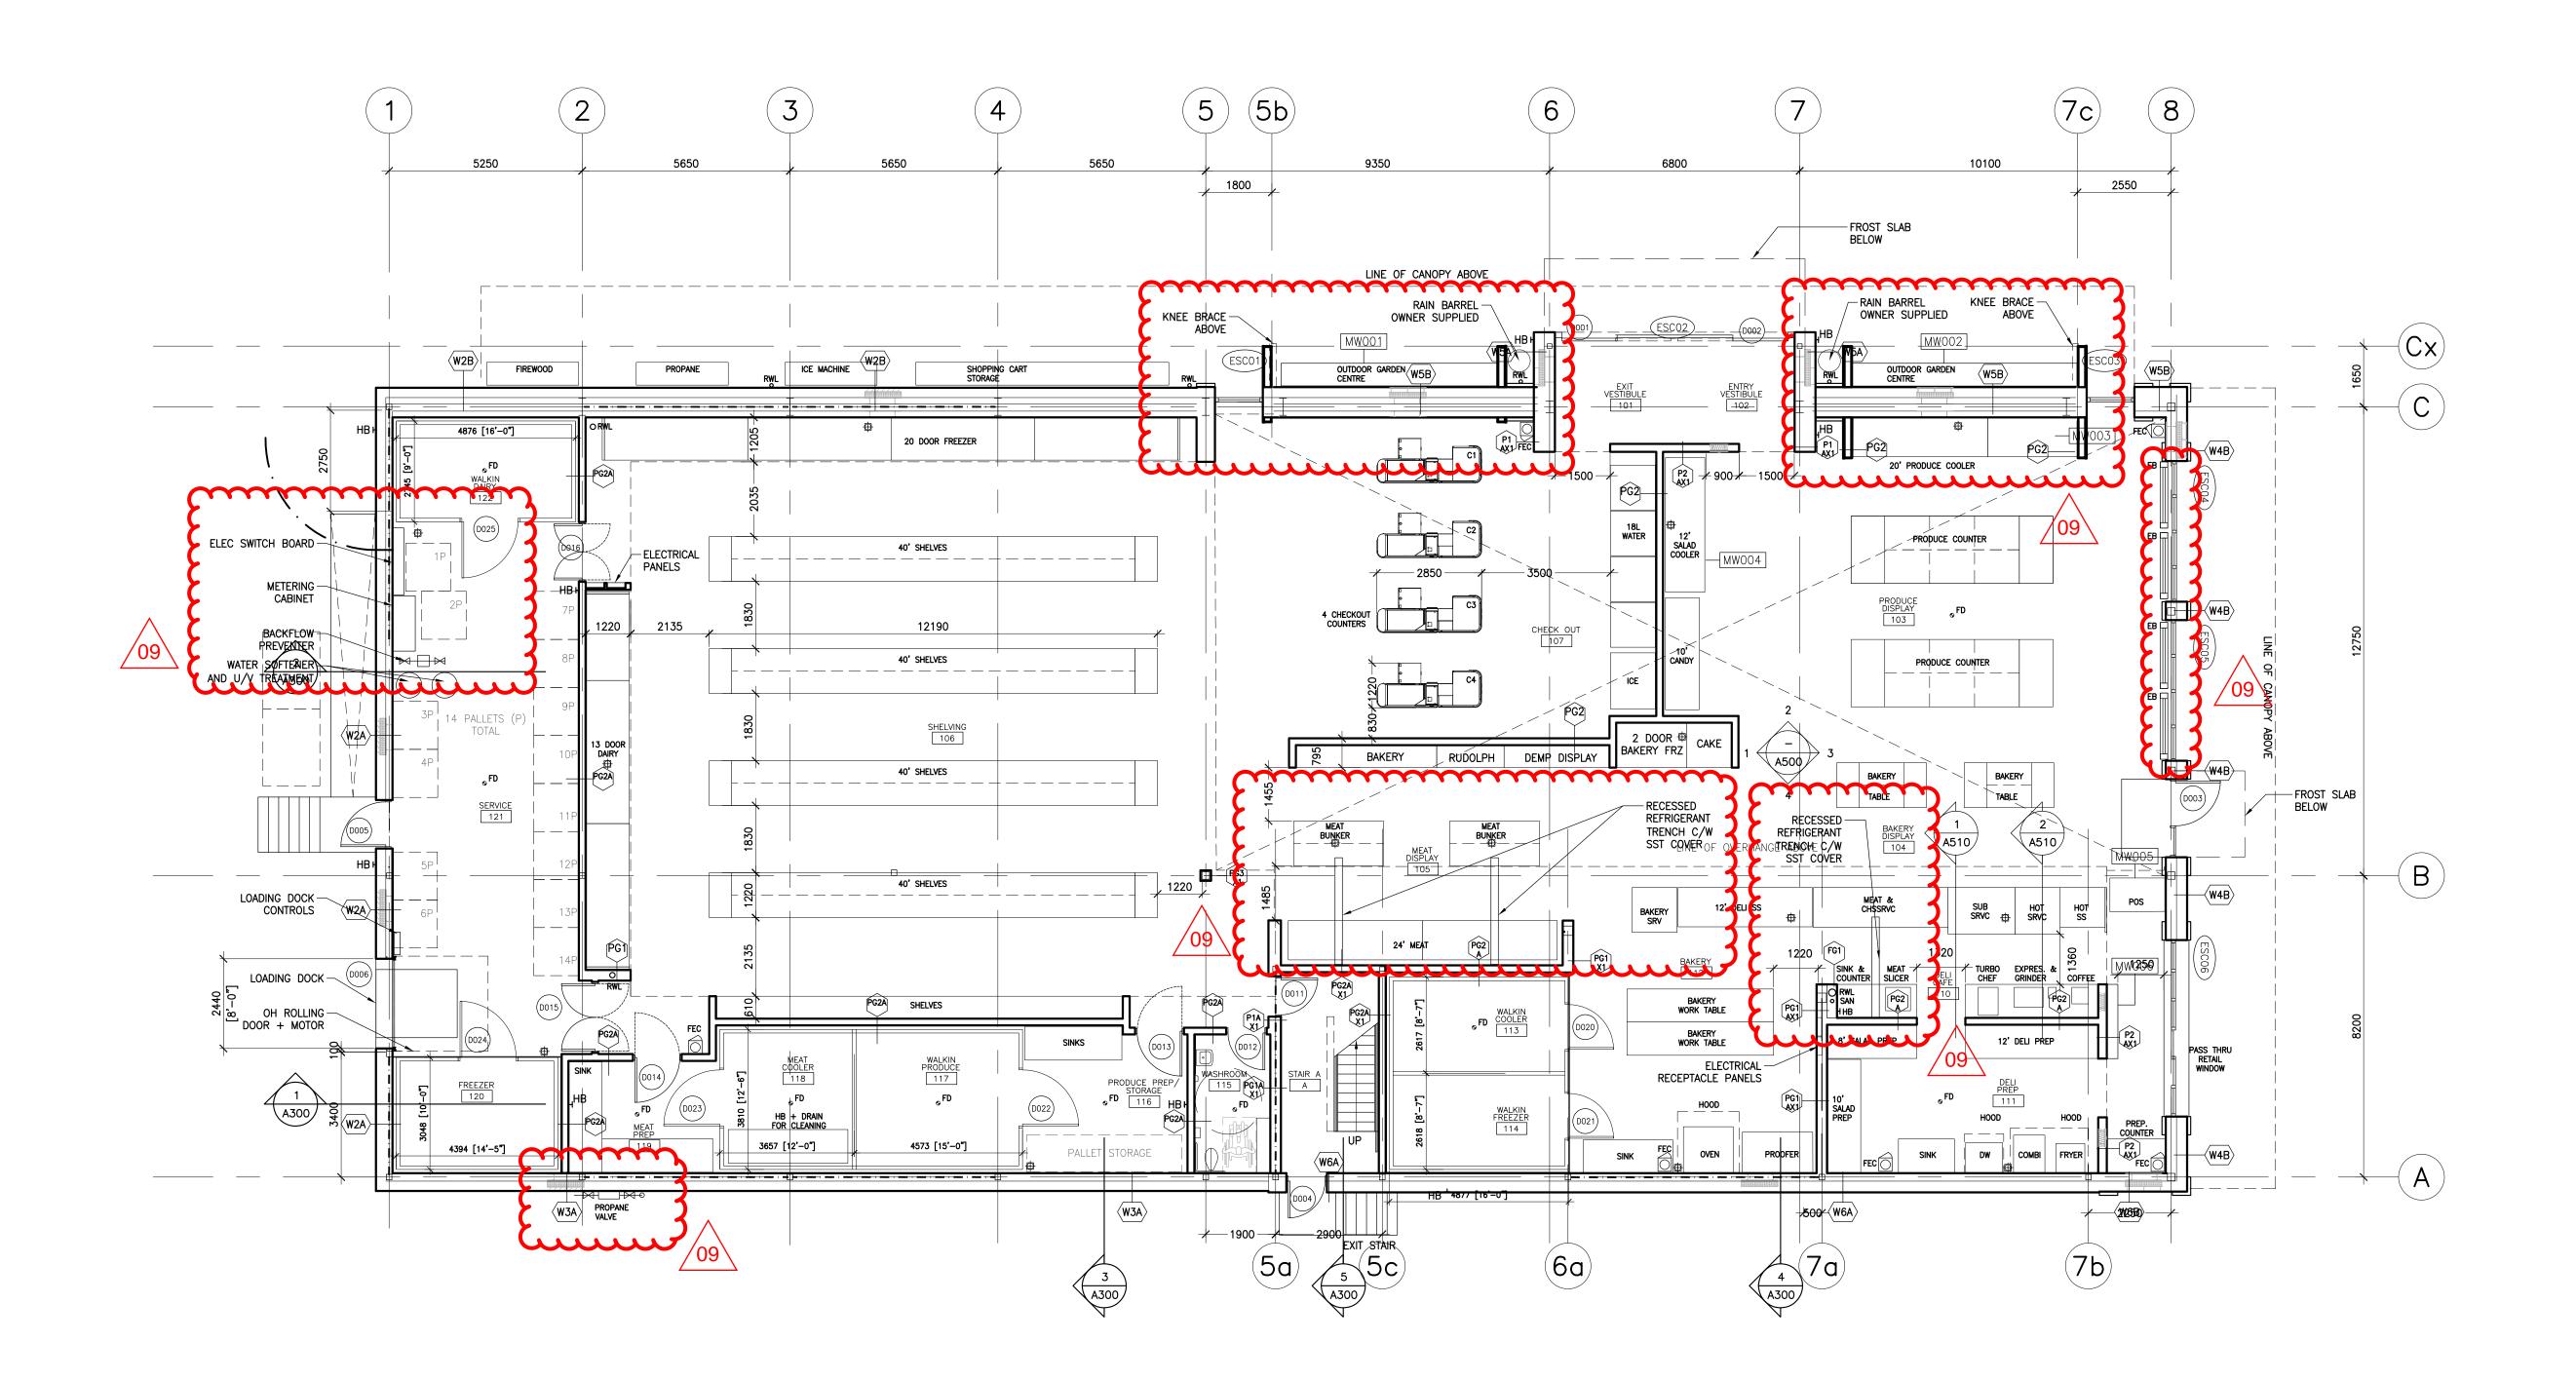

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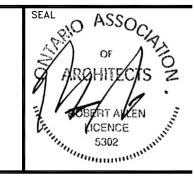
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PROJECT TITLE

NEW SAYERS FOOD STORE BURLEIGH STREET, APSLEY


DRAWING TITLE

GROUND LEVEL FLOOR PLAN

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PROJECT NUMBER 2102



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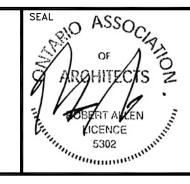
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LEVEL 2 FLOOR PLAN

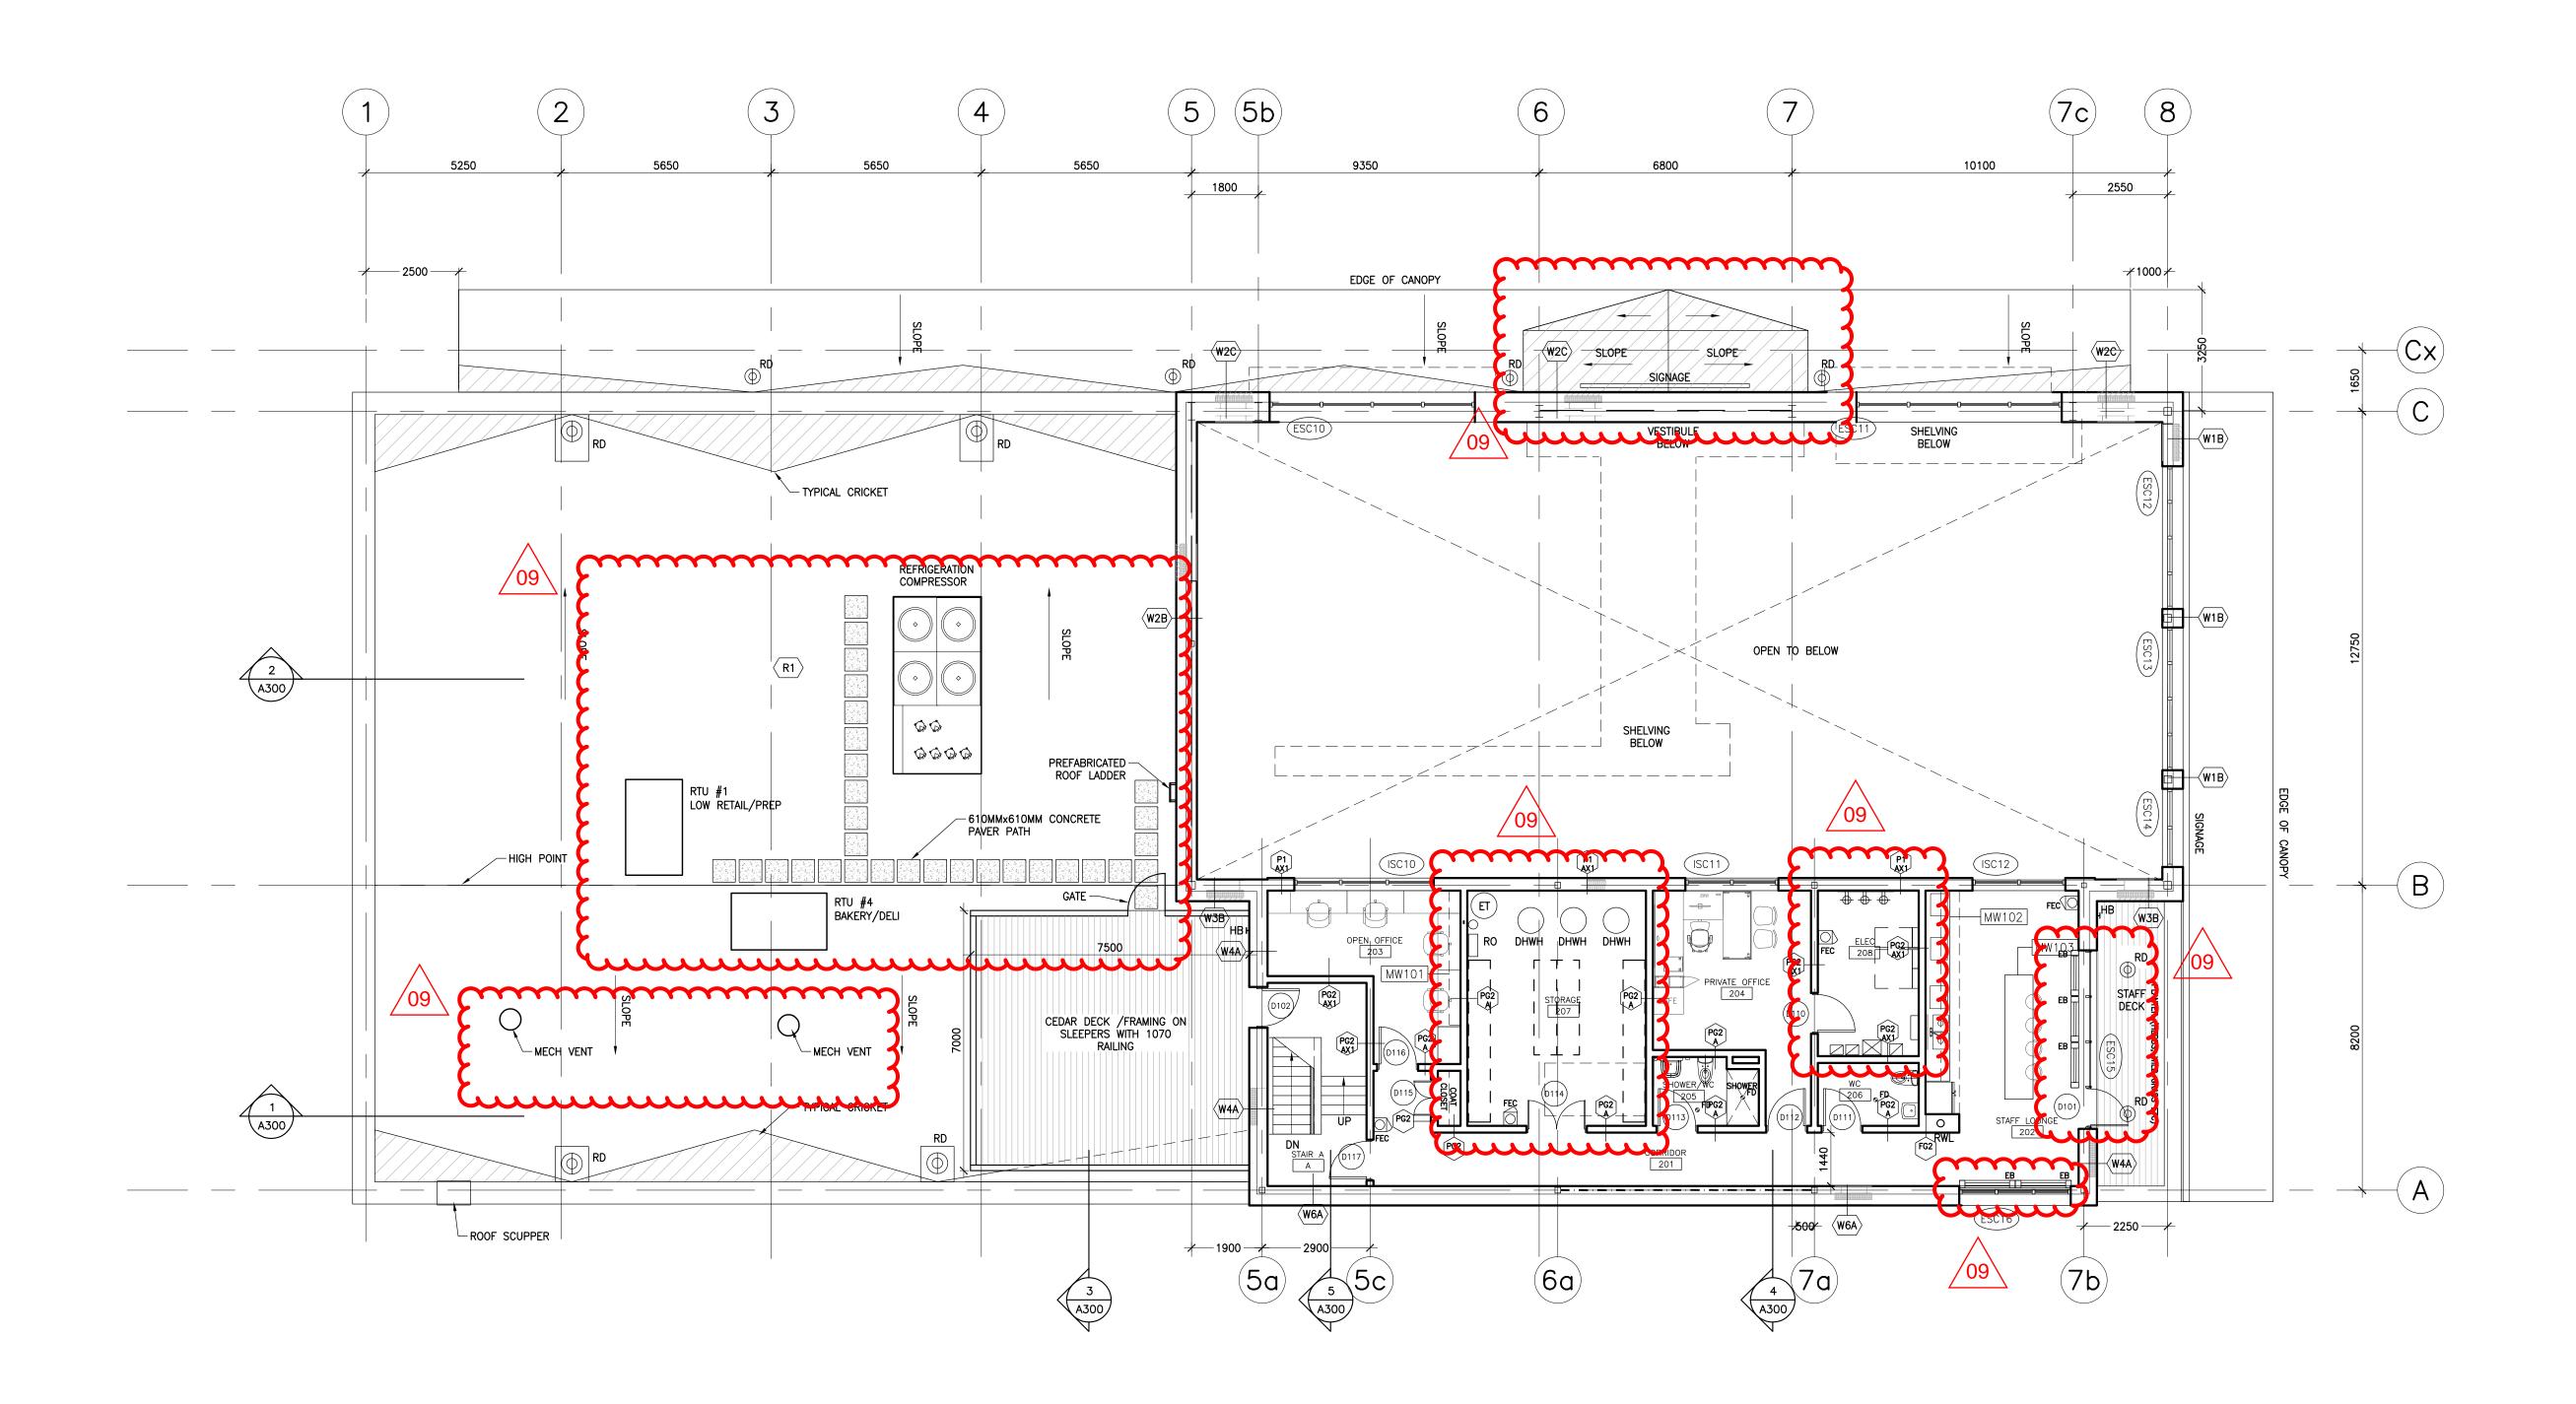
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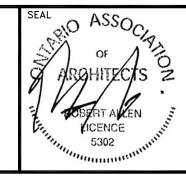
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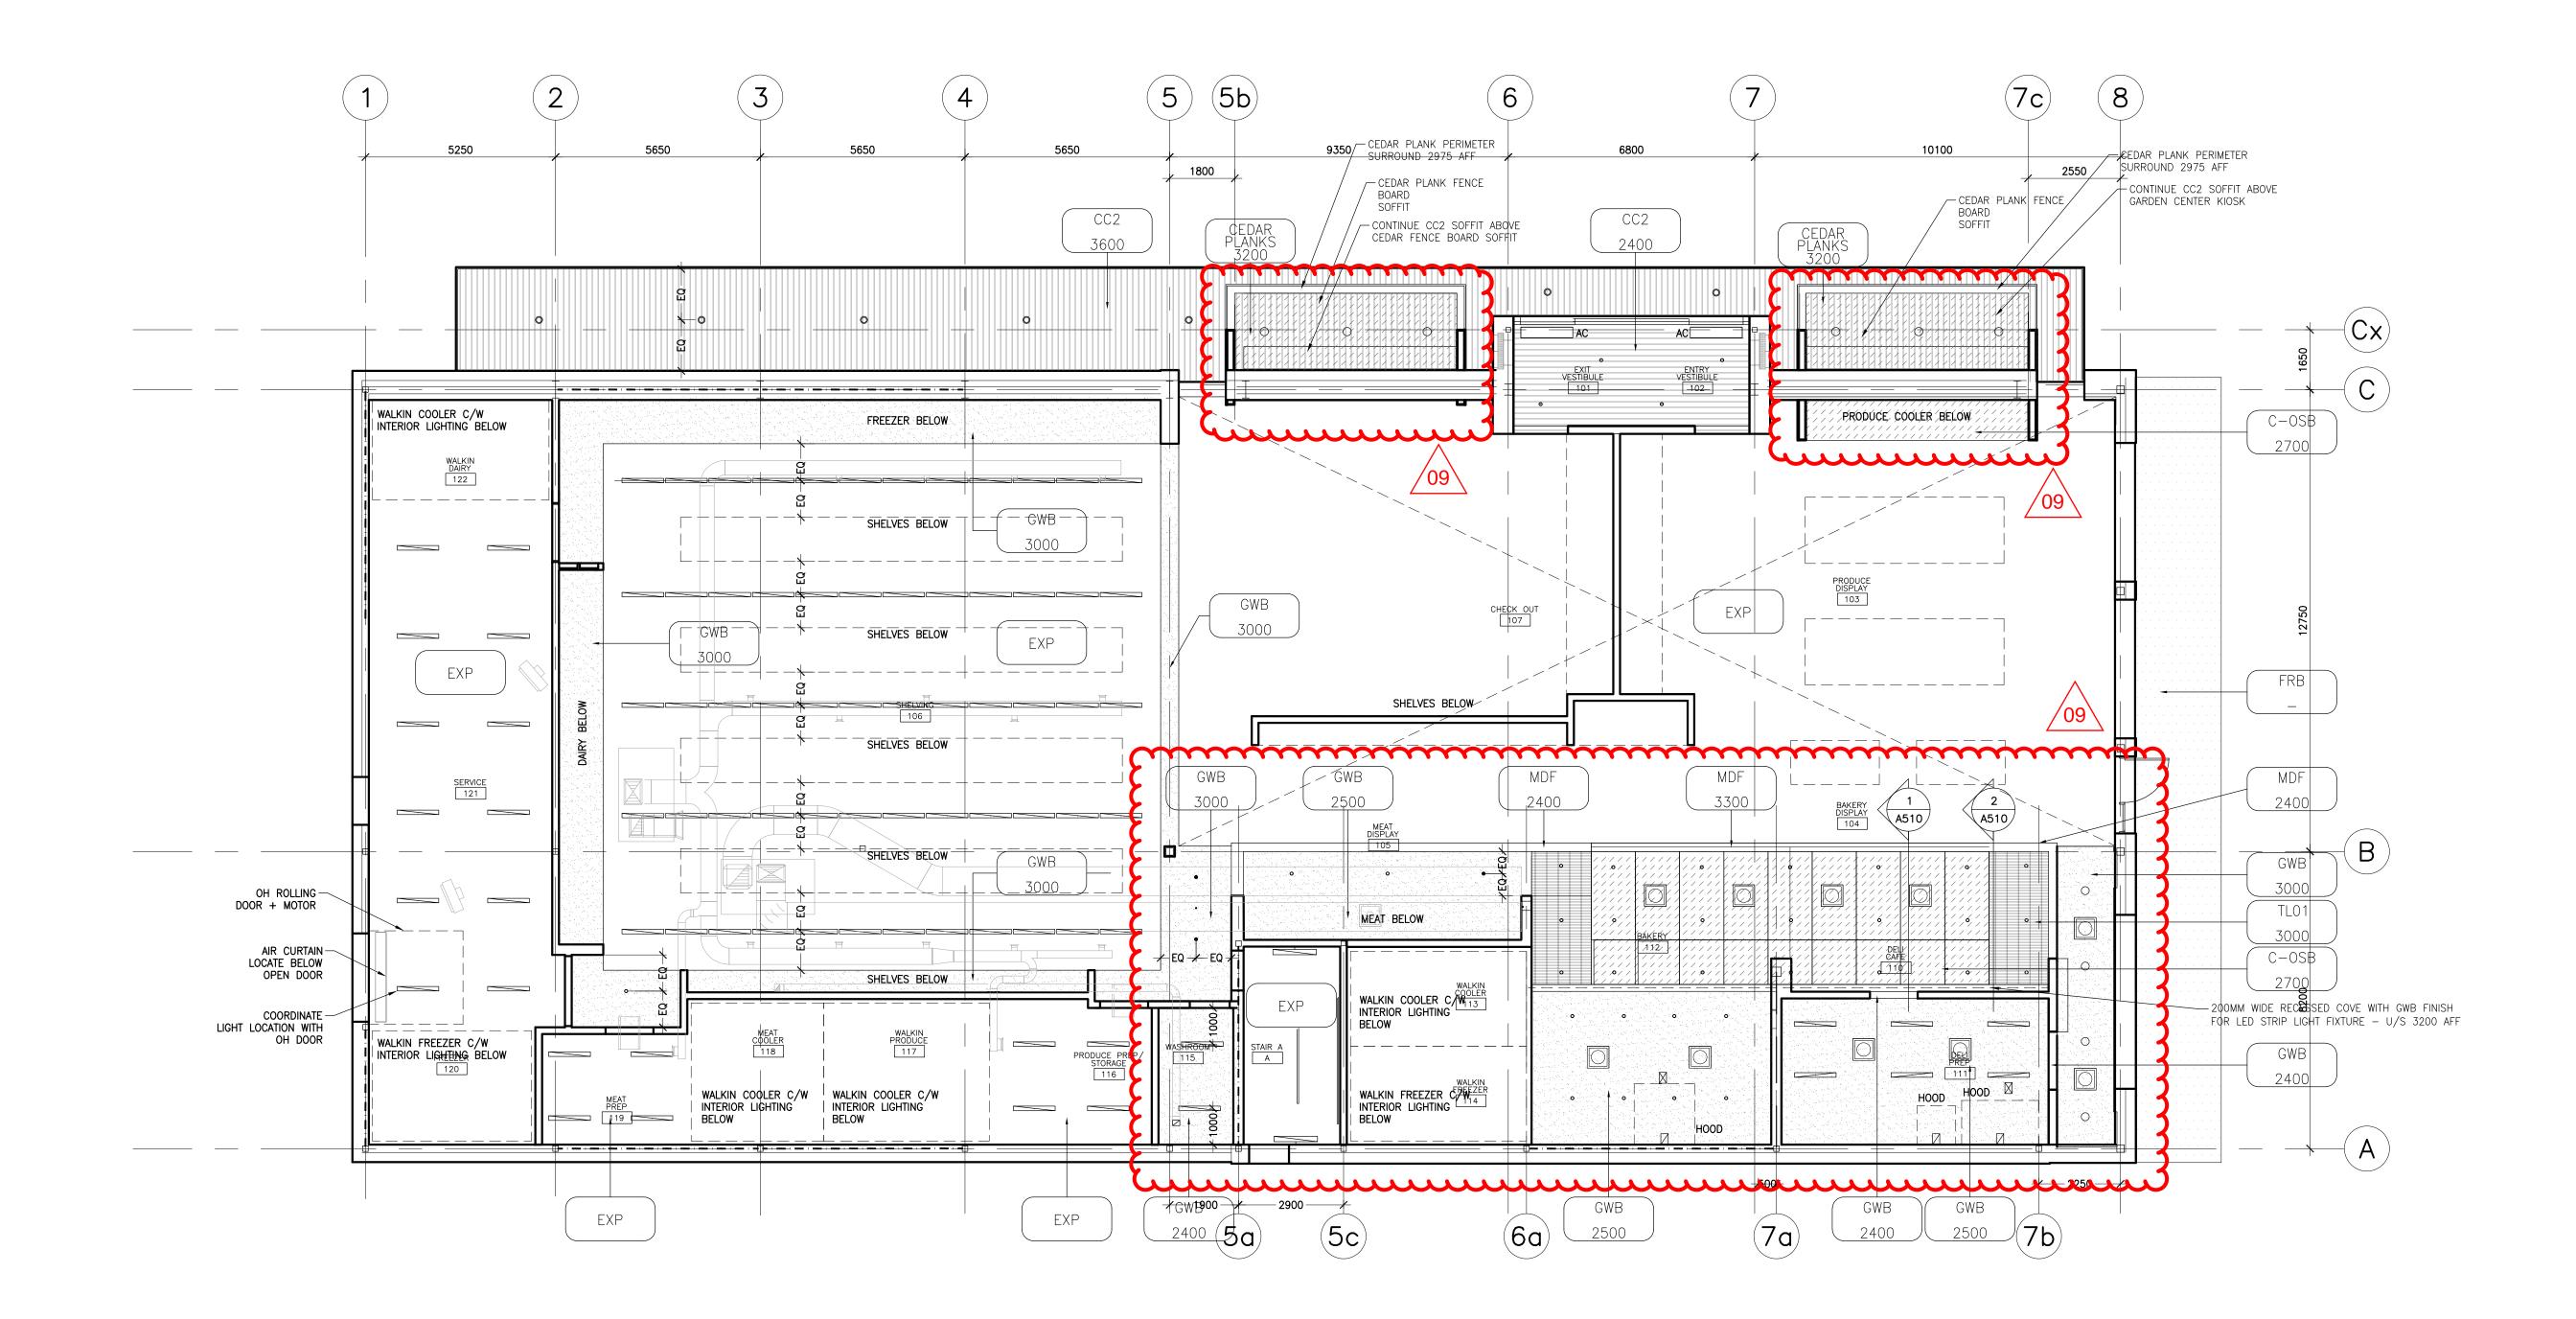
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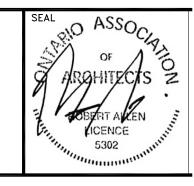
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GROUND LEVEL
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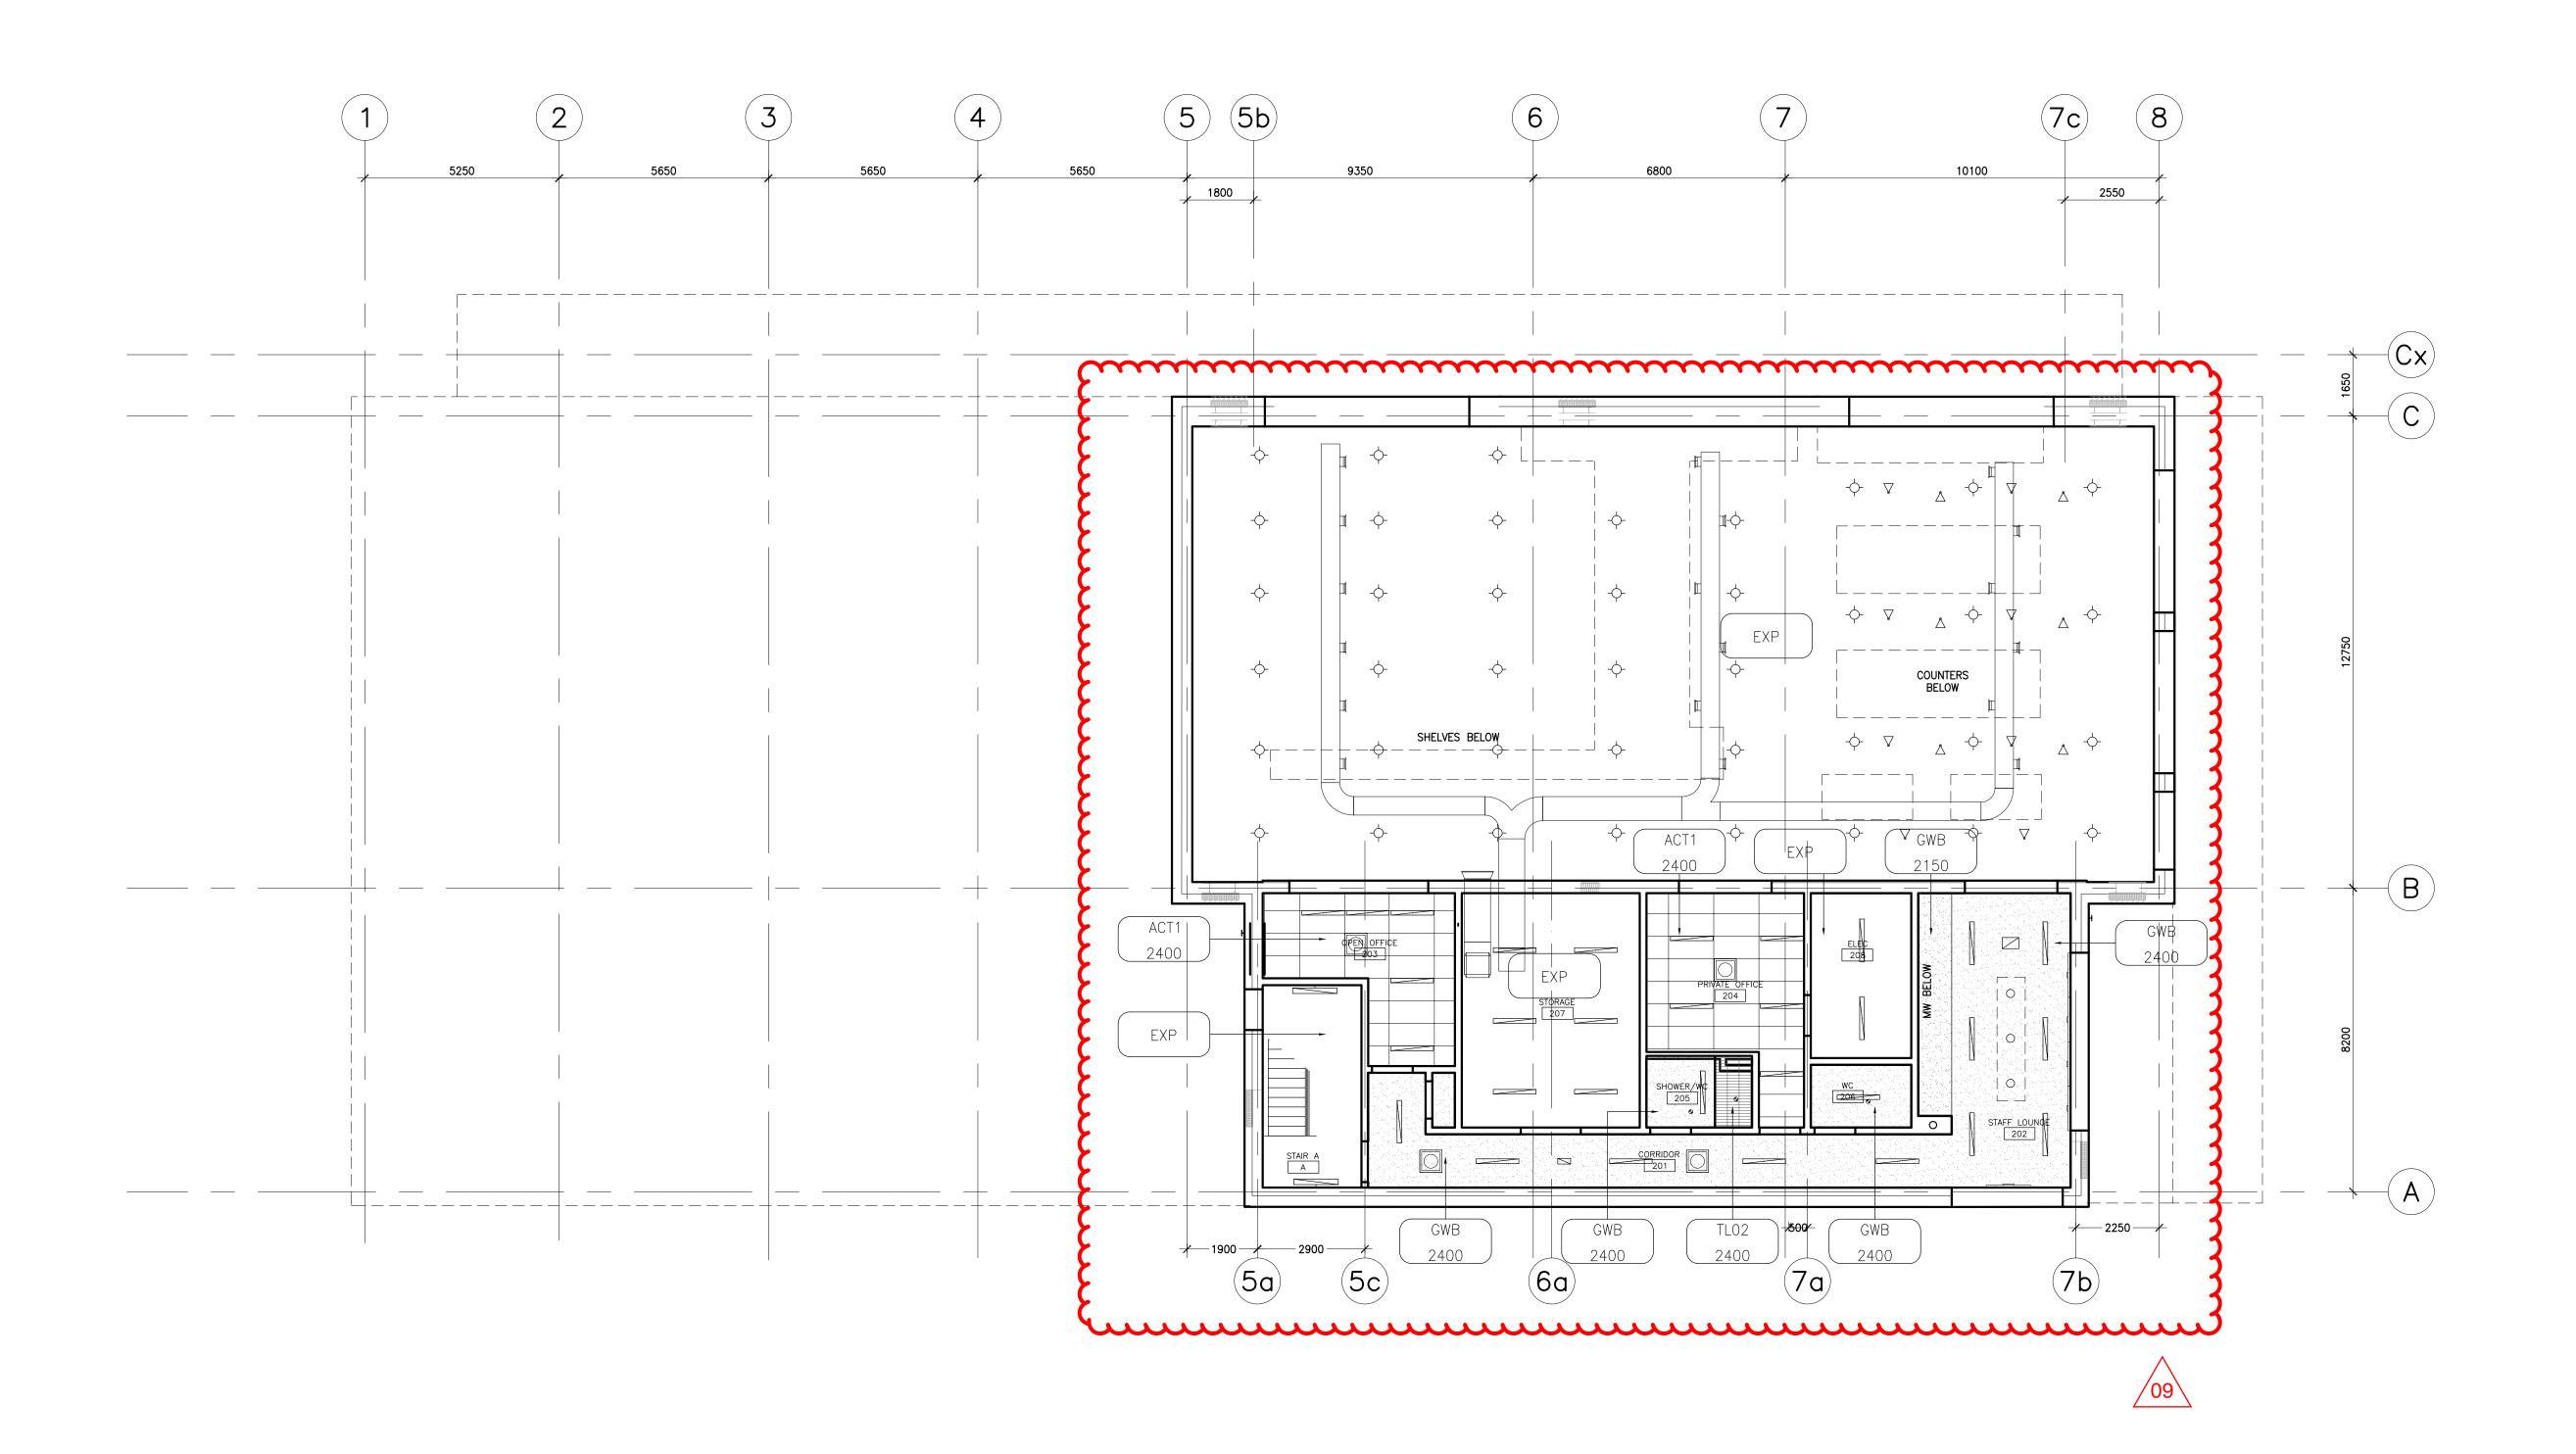
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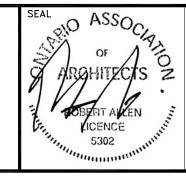
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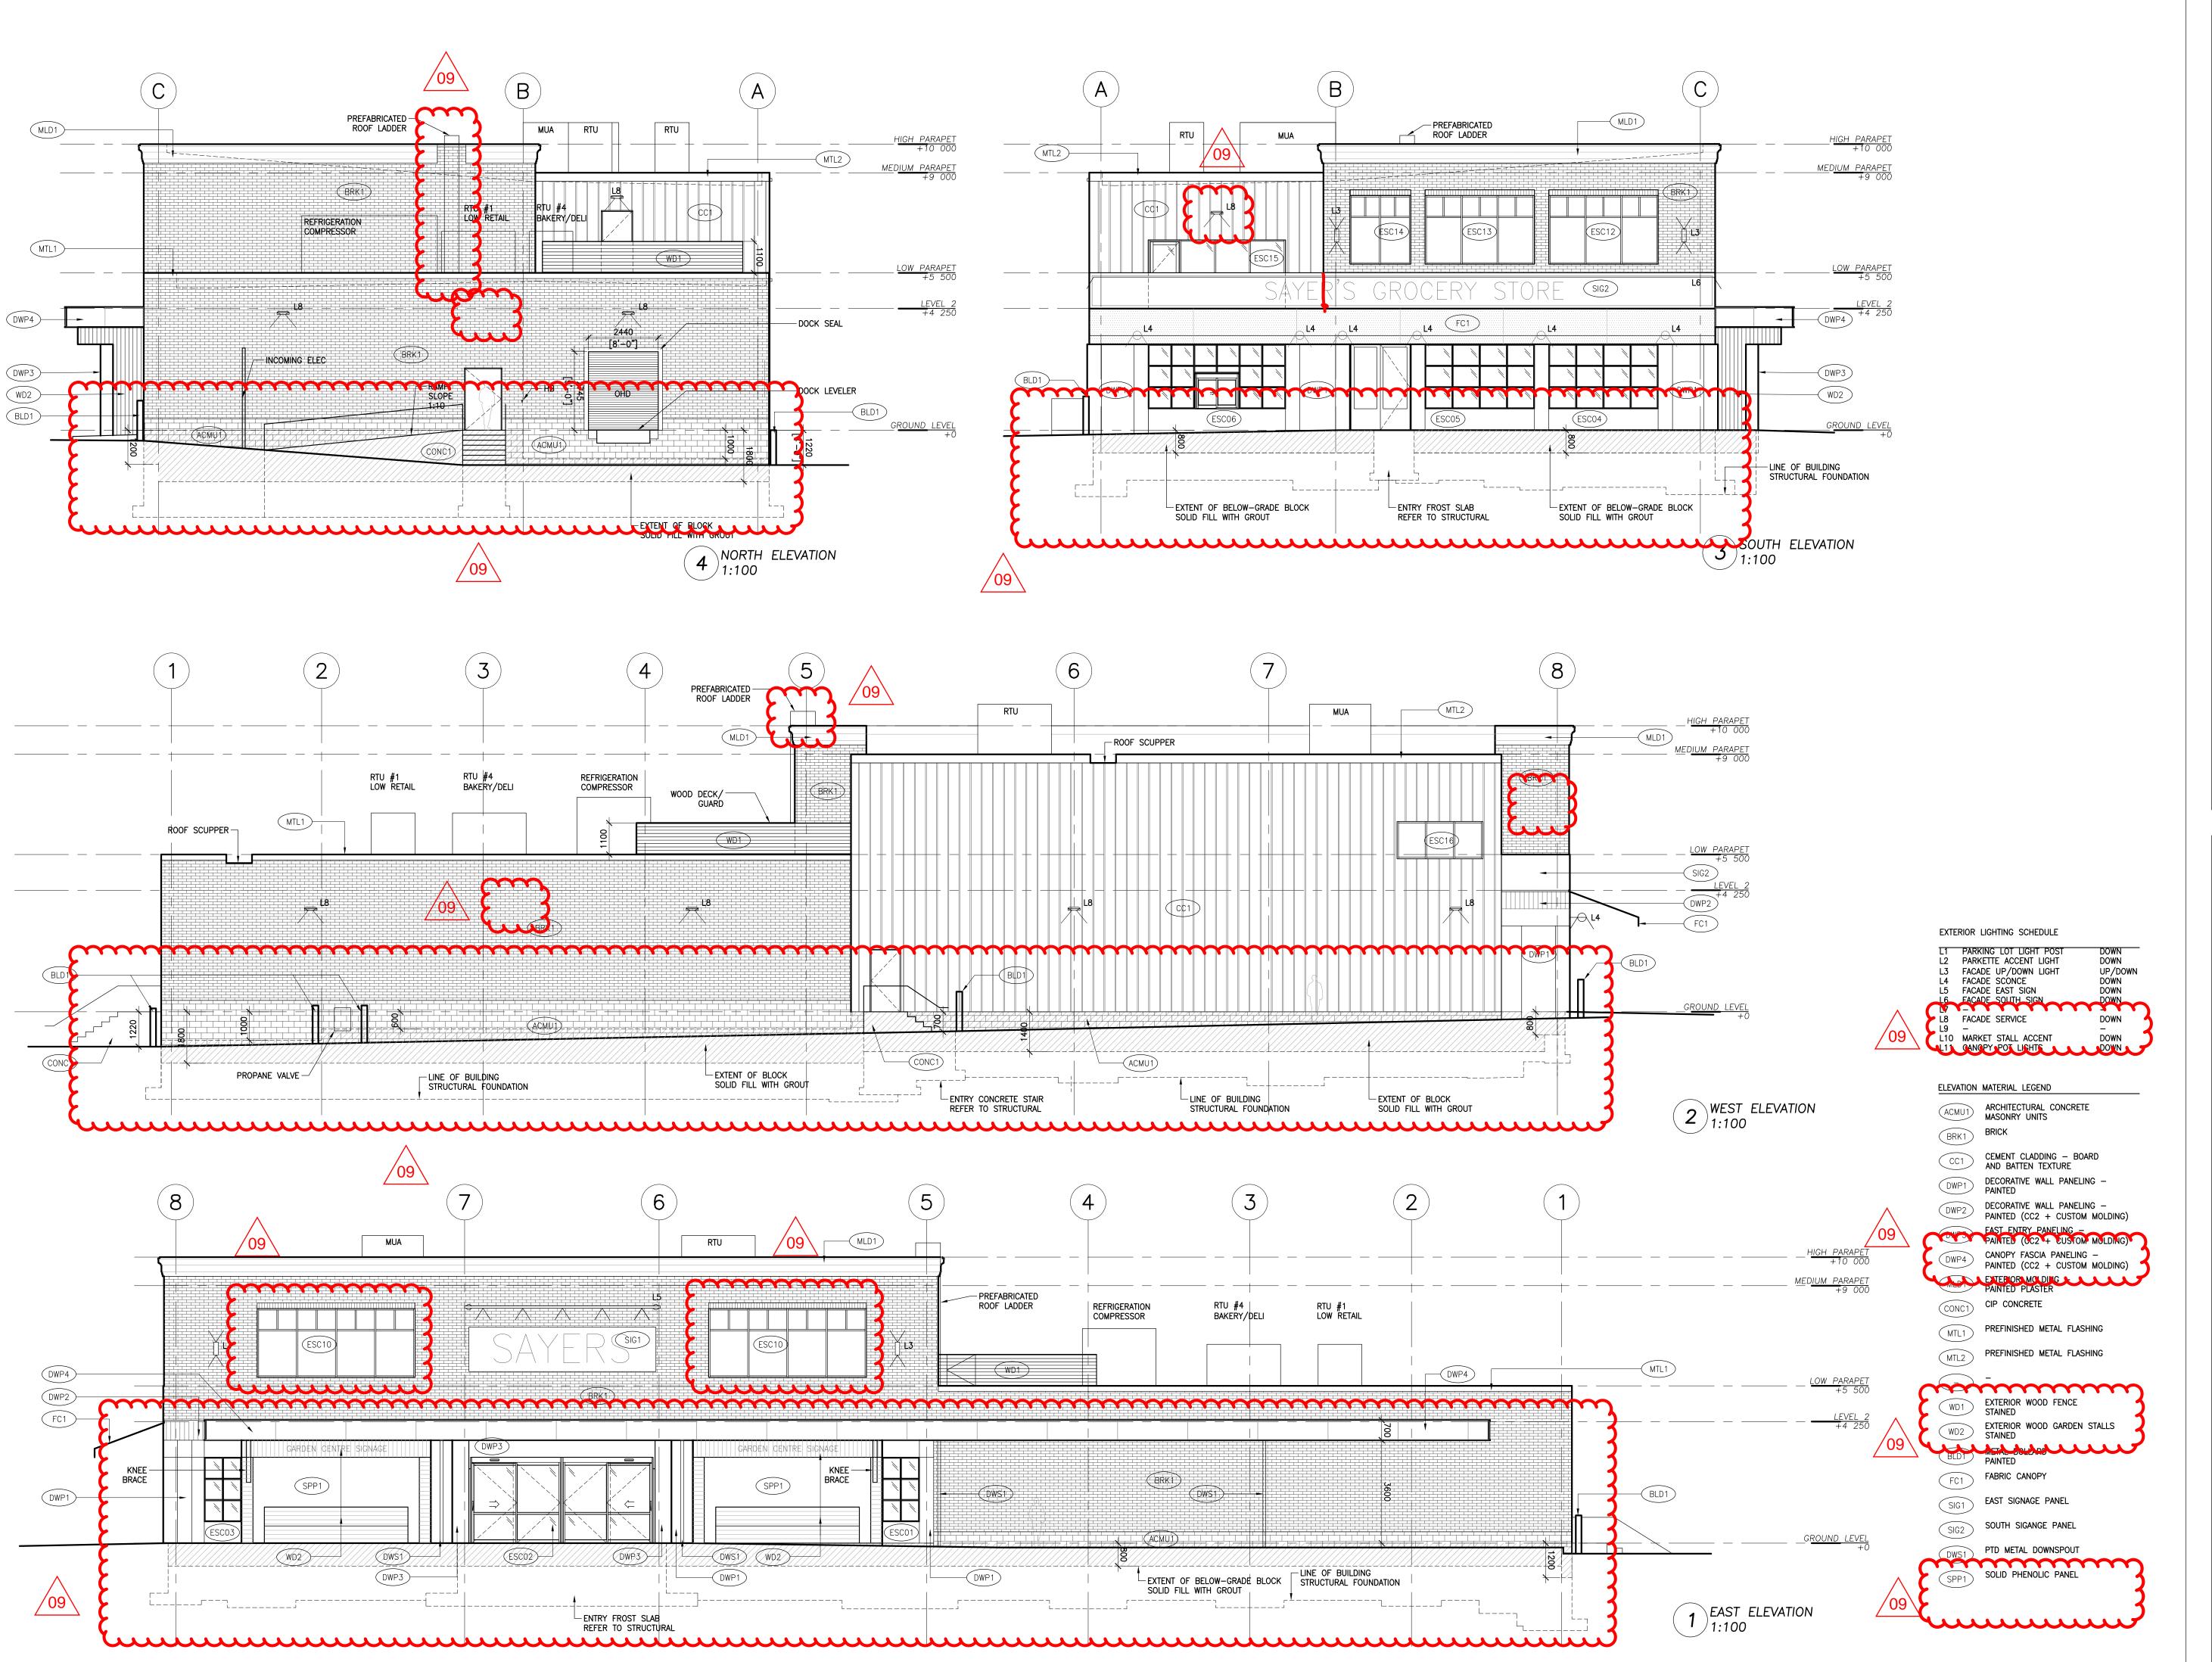
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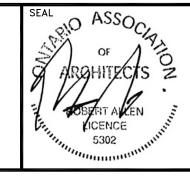
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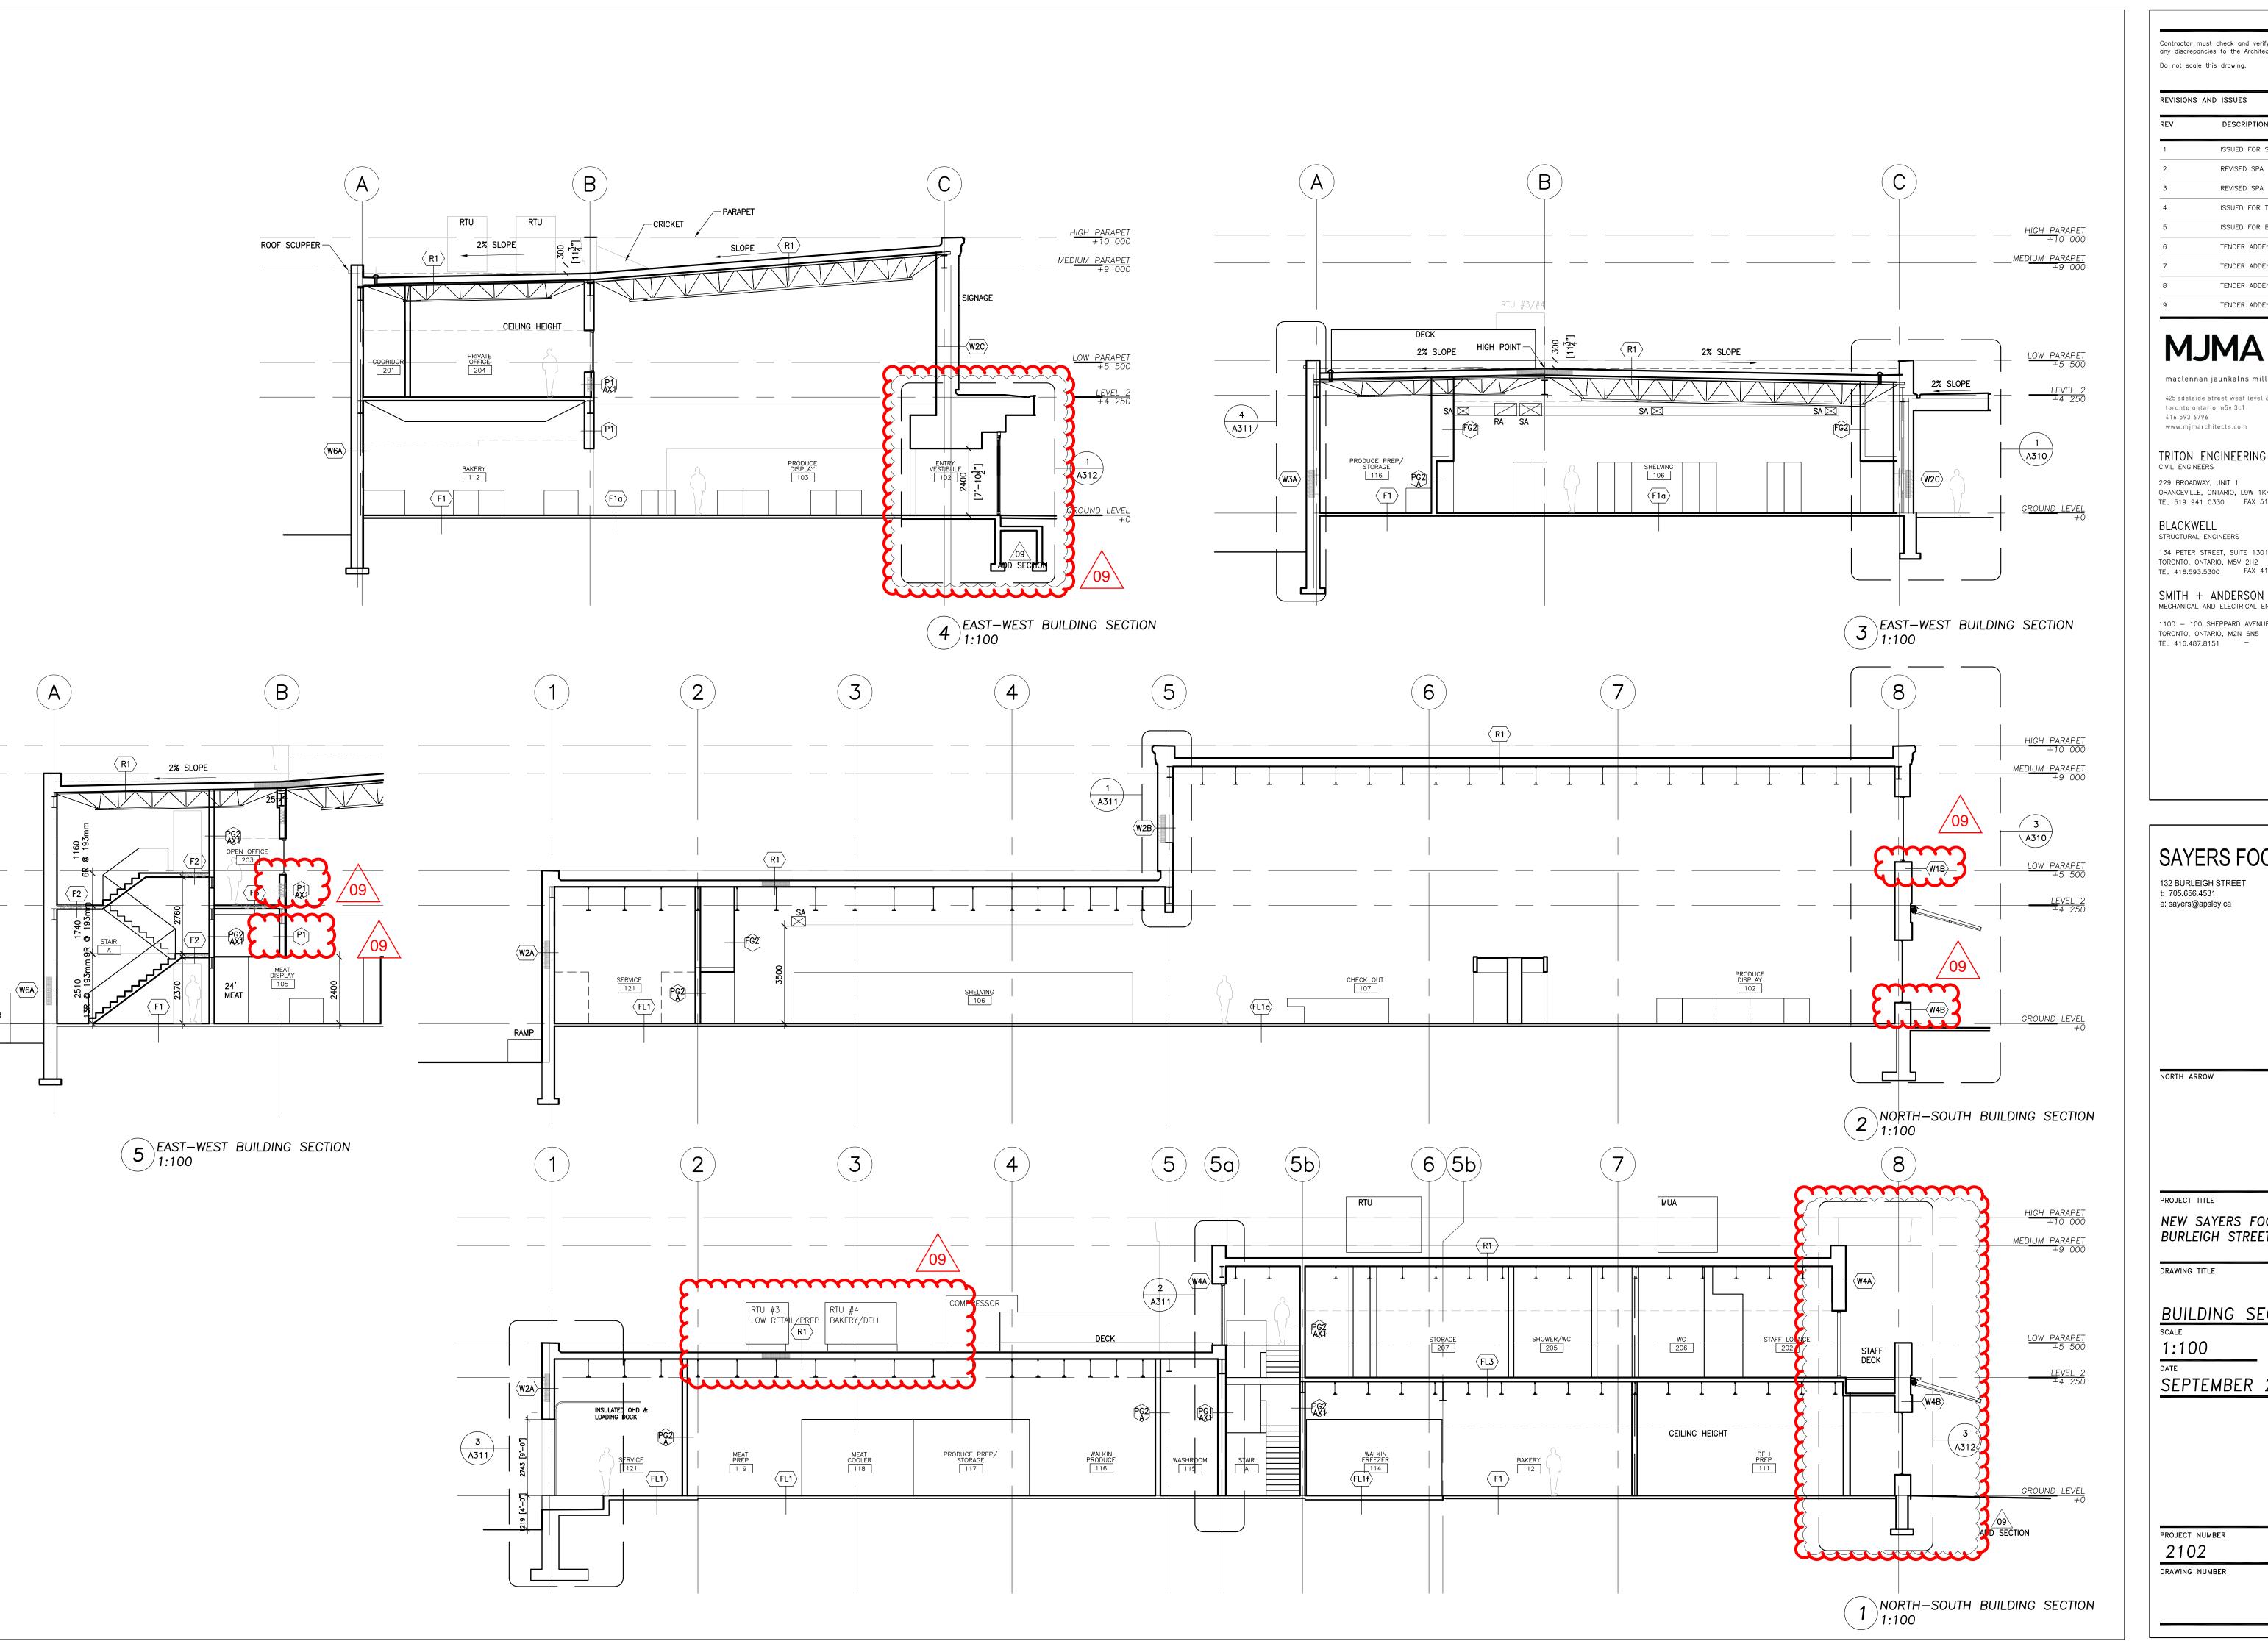
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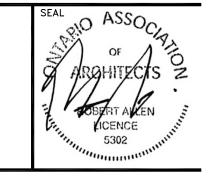
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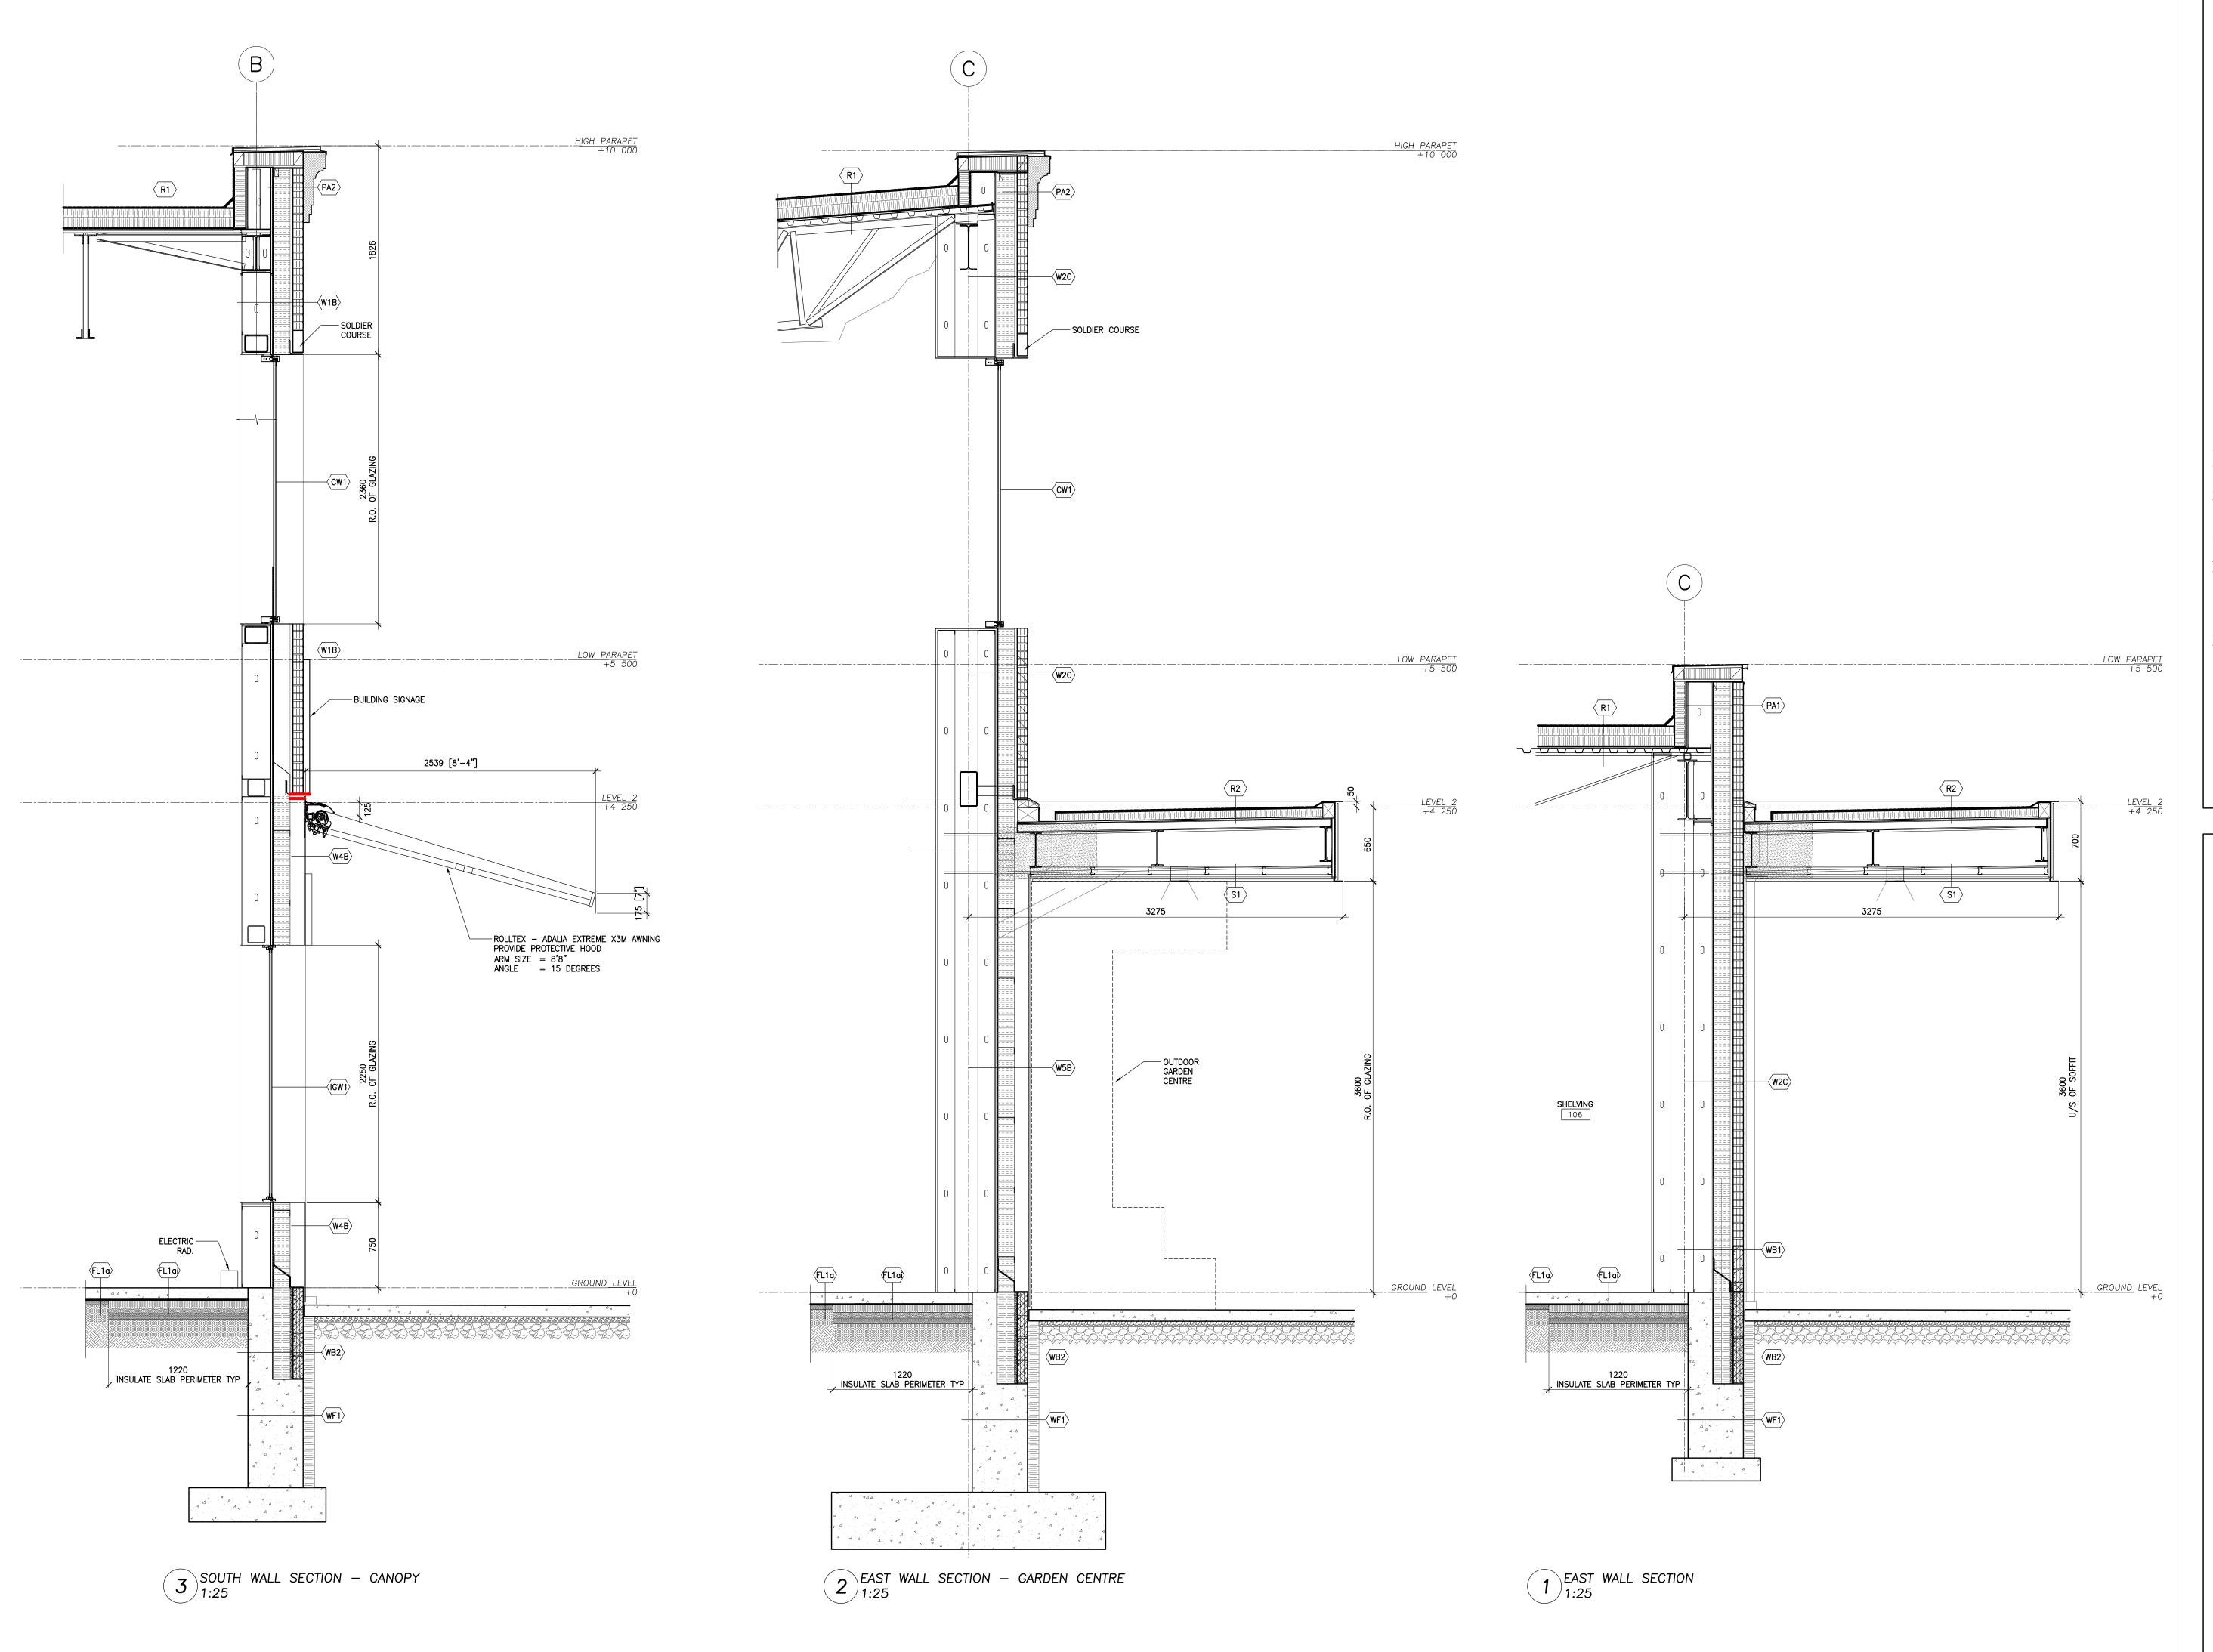
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WALL SECTIONS

EAST & SOUTH FACADES


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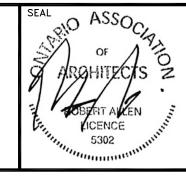
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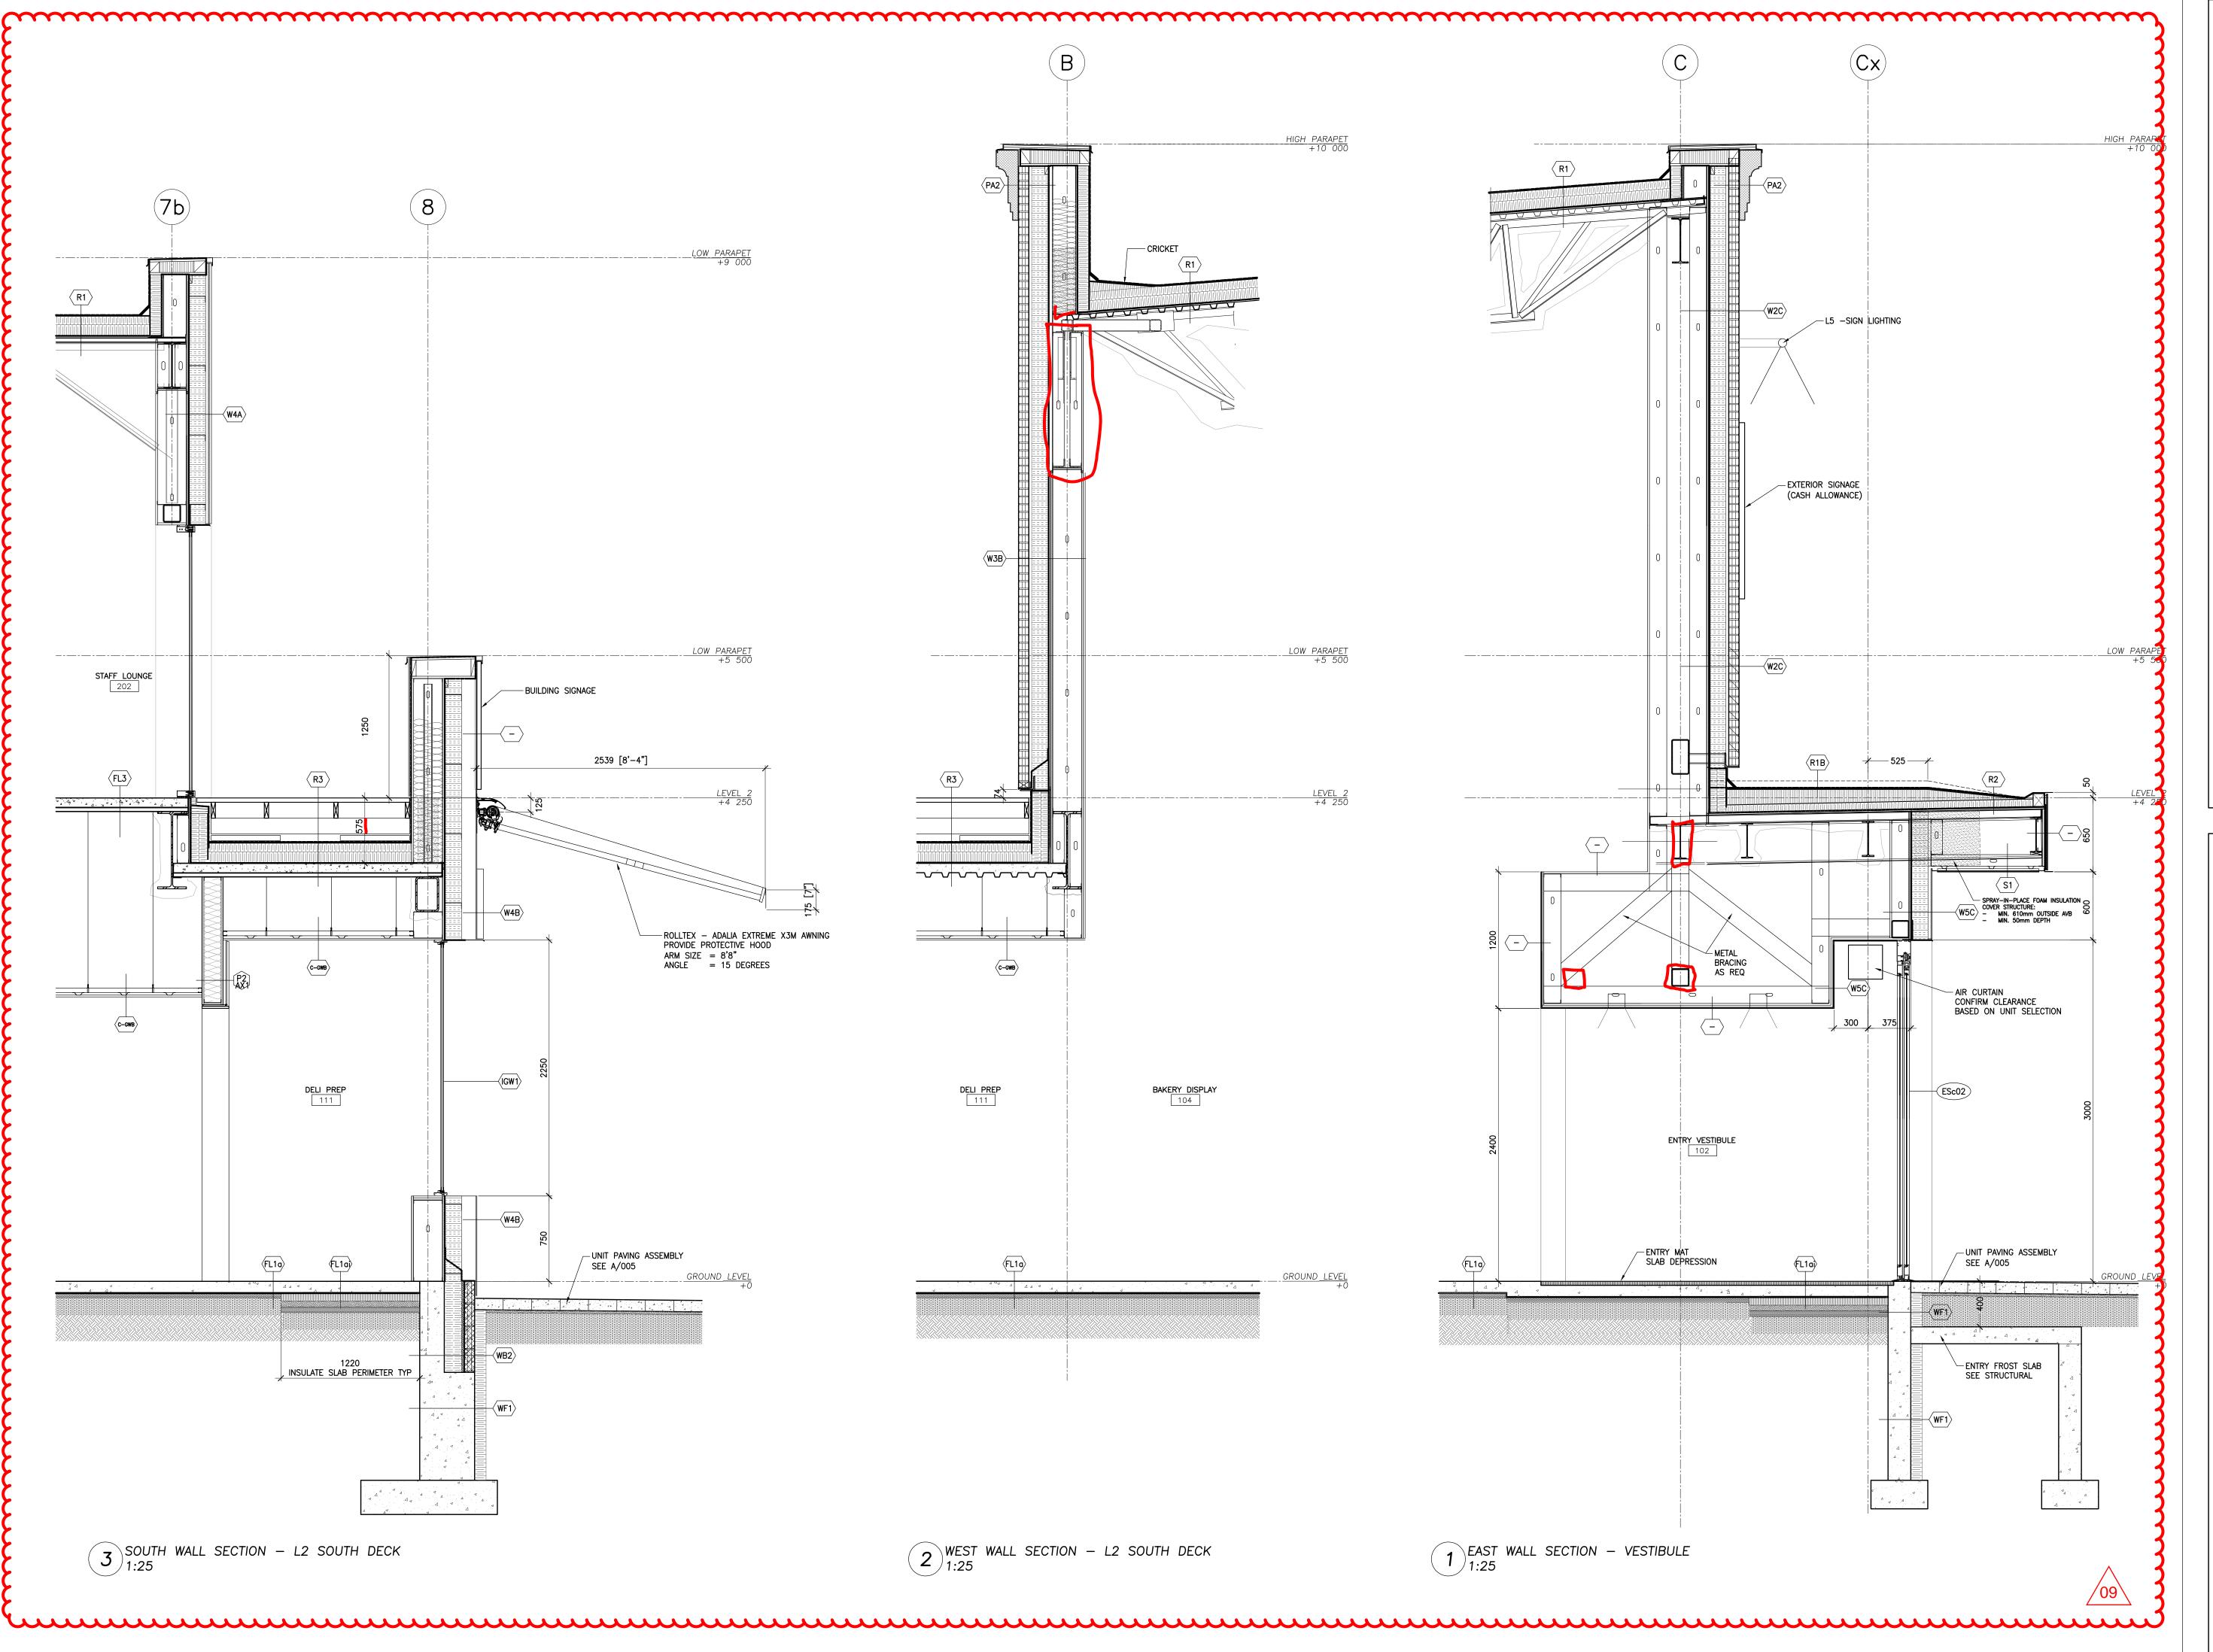
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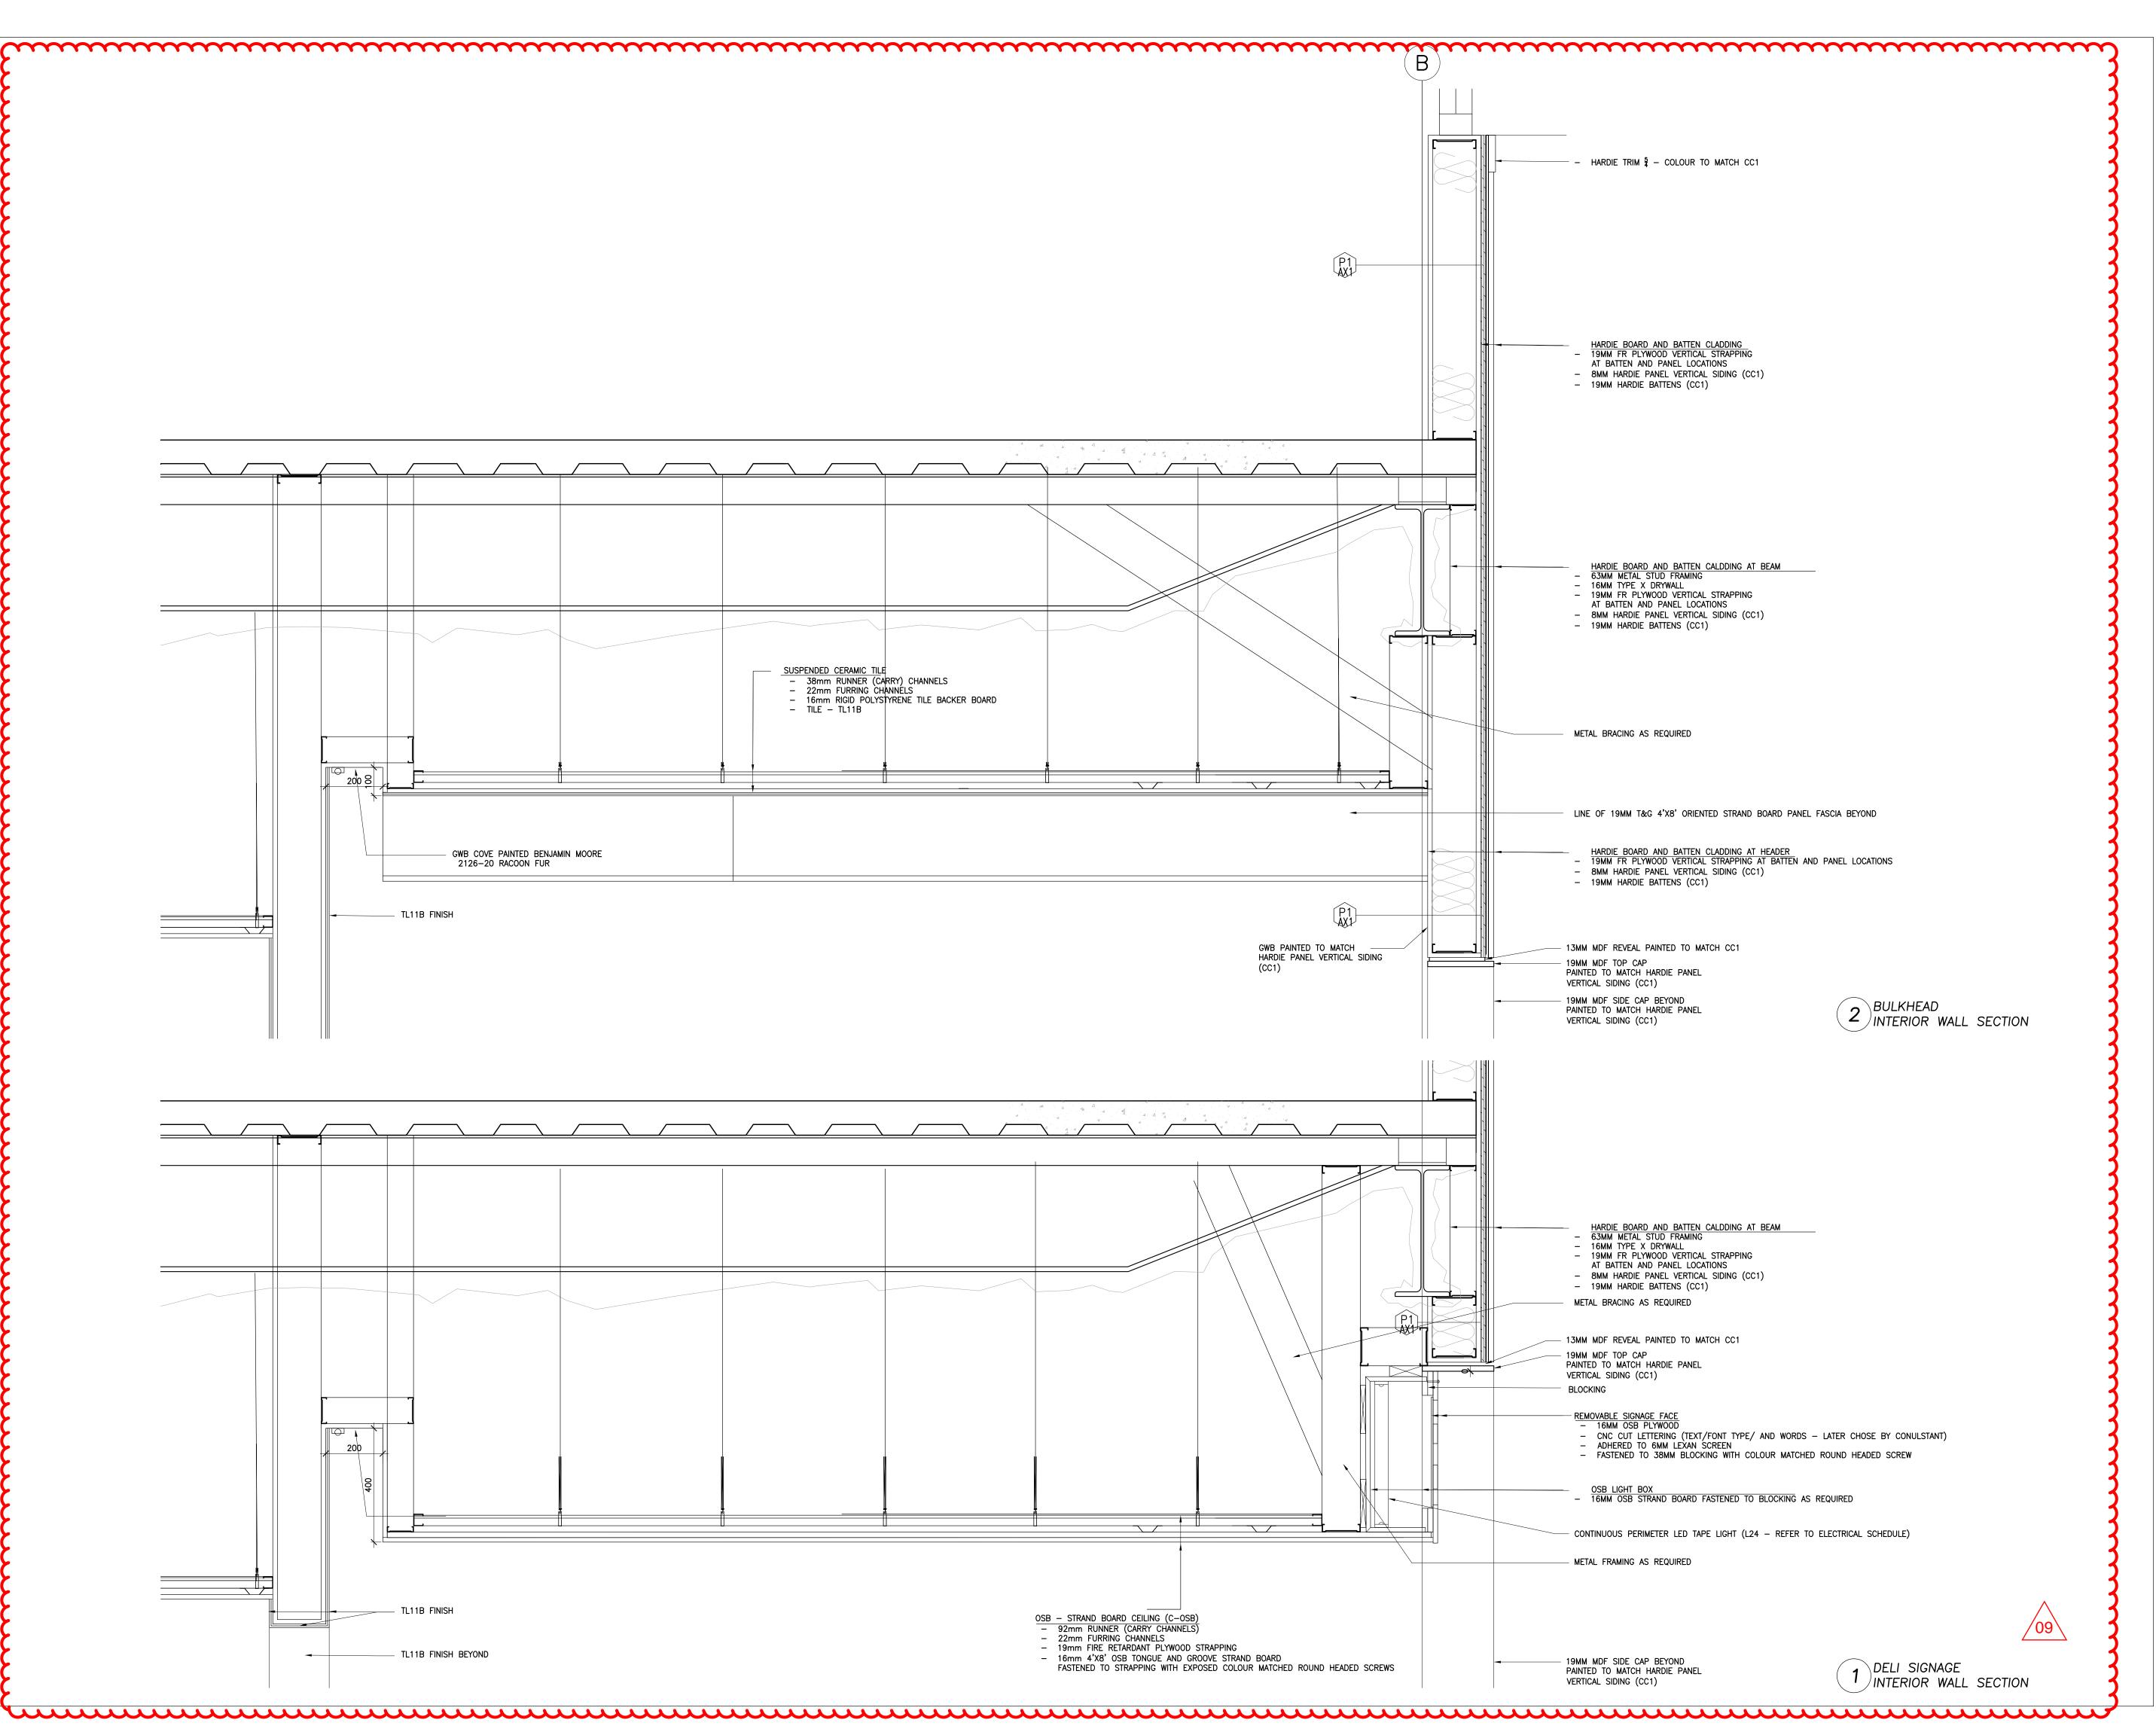
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1	ISSUED FOR SPA	210618	AE
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3	REVISED SPA	210809	AE
4	ISSUED FOR TENDER	210824	AE
5	ISSUED FOR BUILDING PERMIT	210909	AE
6	TENDER ADDENDUM #1	210914	AE
7	TENDER ADDENDUM #2	210917	AB
8	TENDER ADDENDUM #3	210923	AB

TENDER ADDENDUM #4 210927

# MJMA

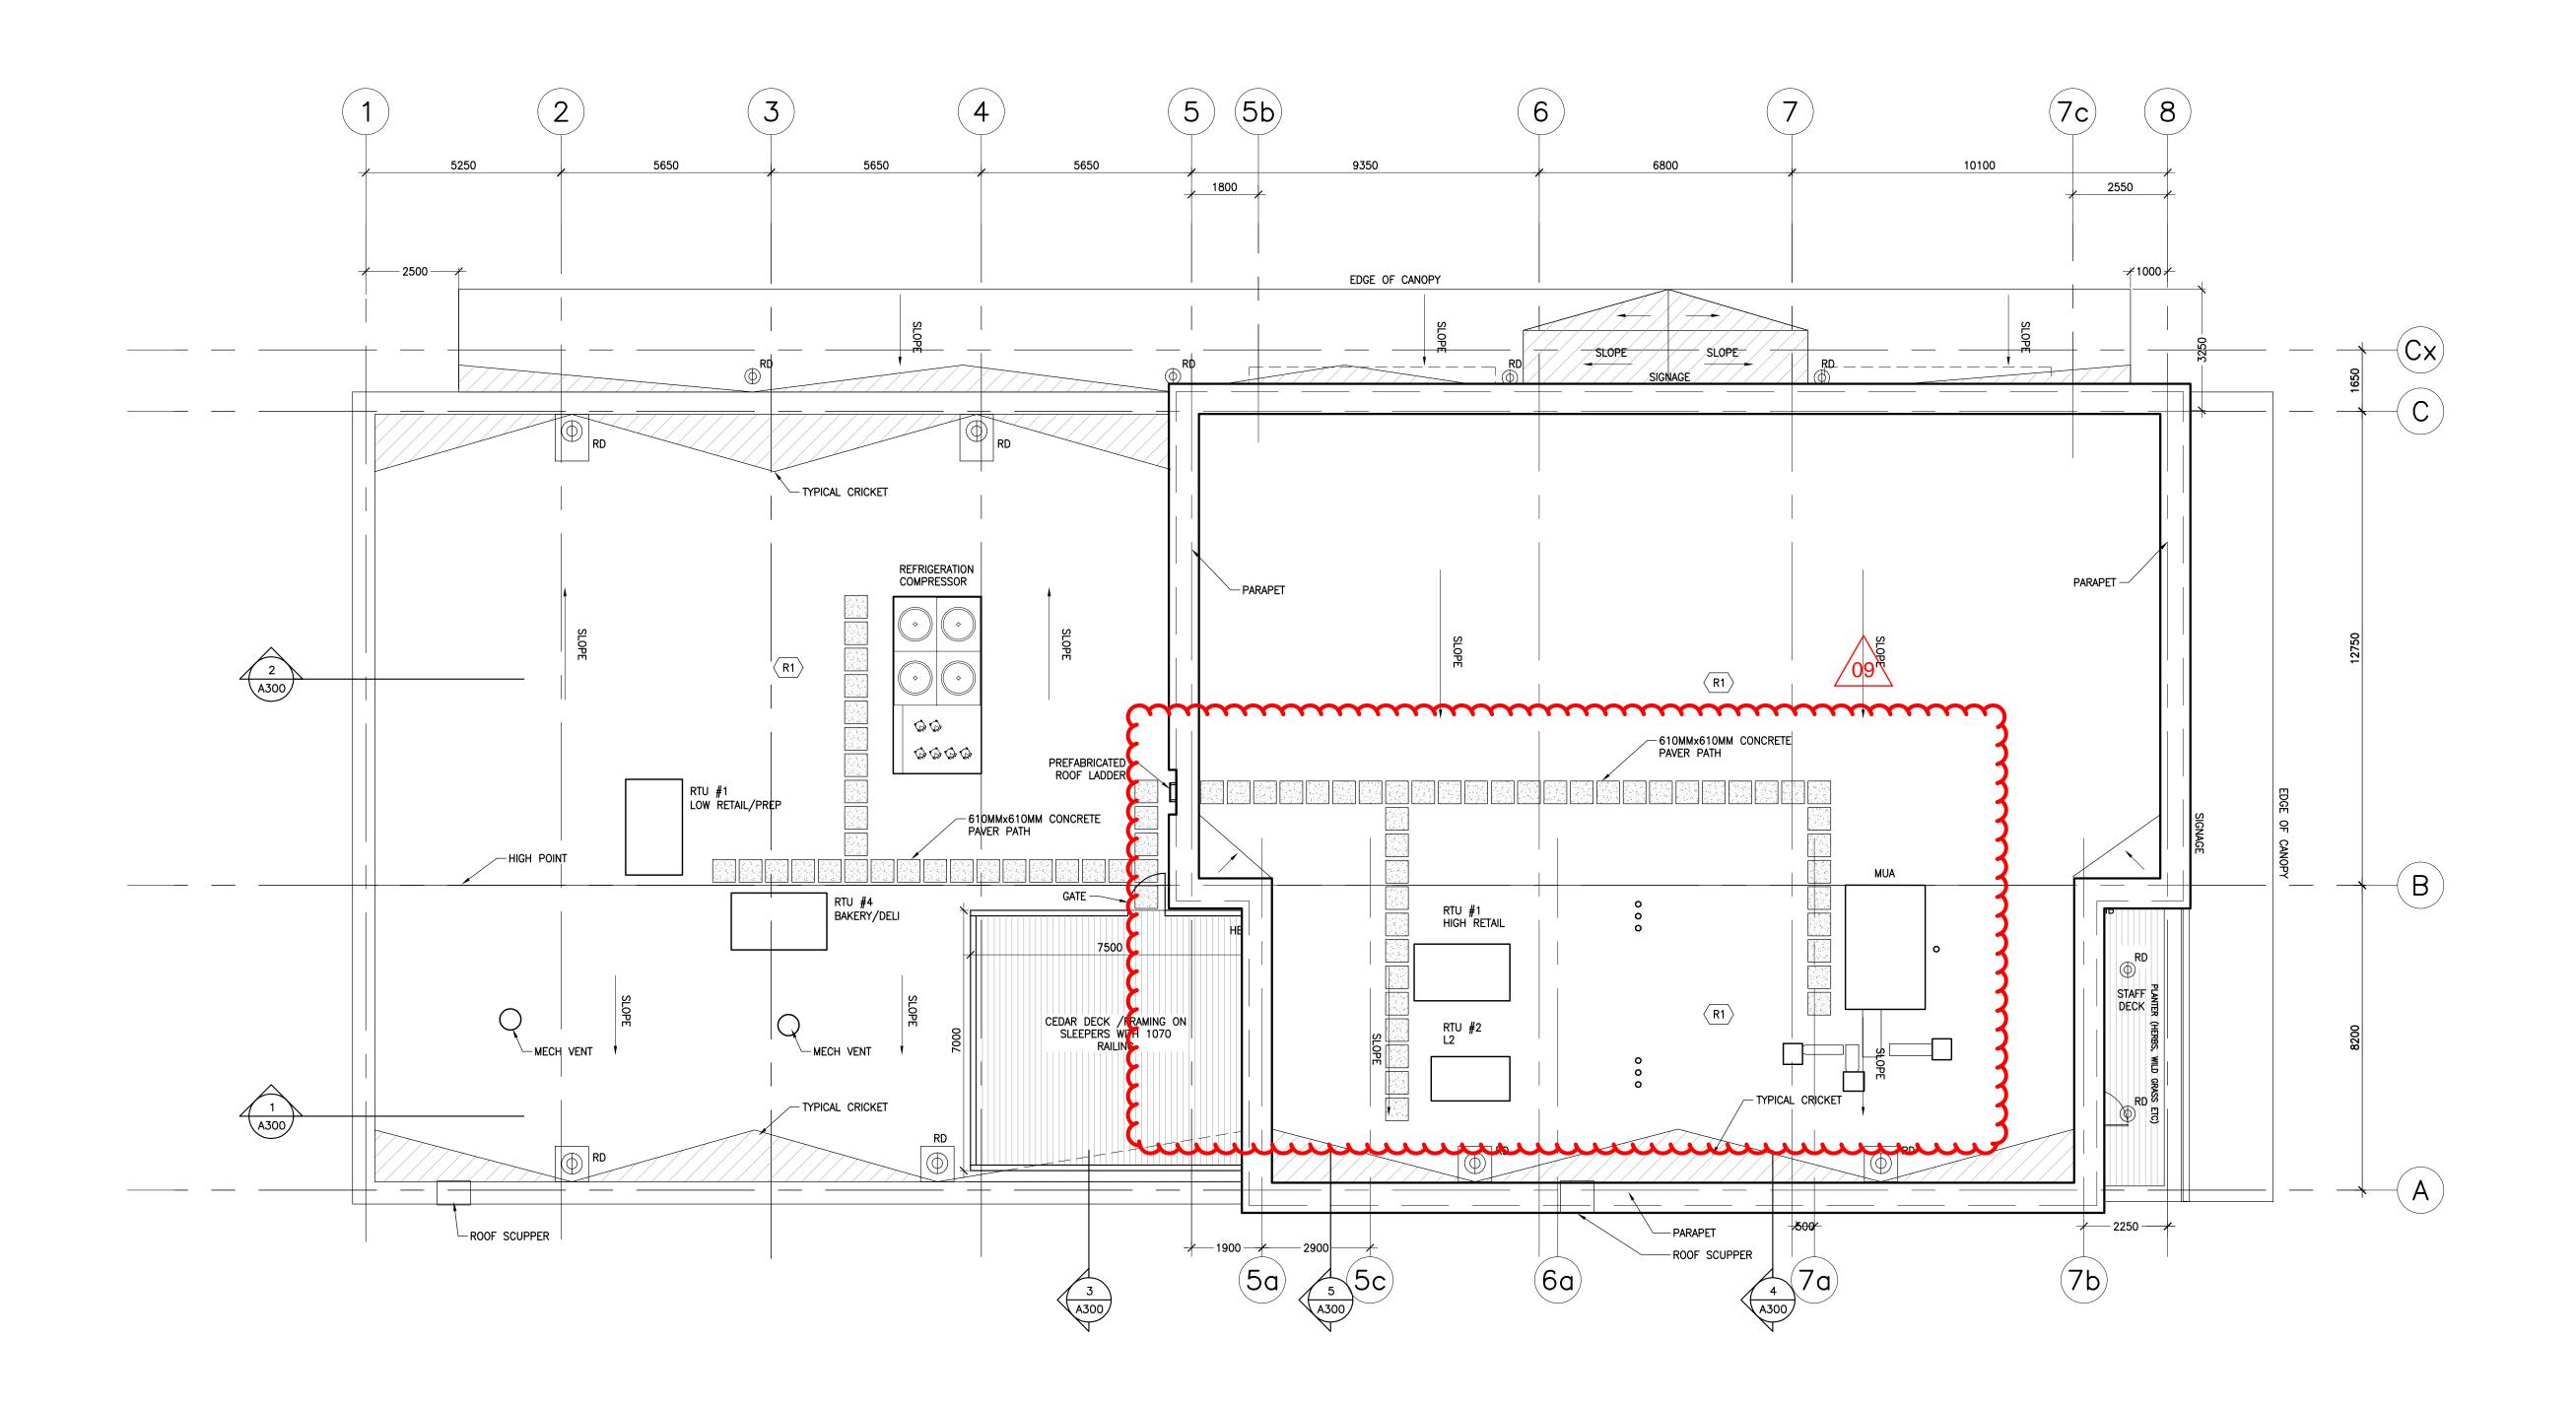maclennan jaunkalns miller architects

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TRITON ENGINEERING SERVICES LTD CIVIL ENGINEERS
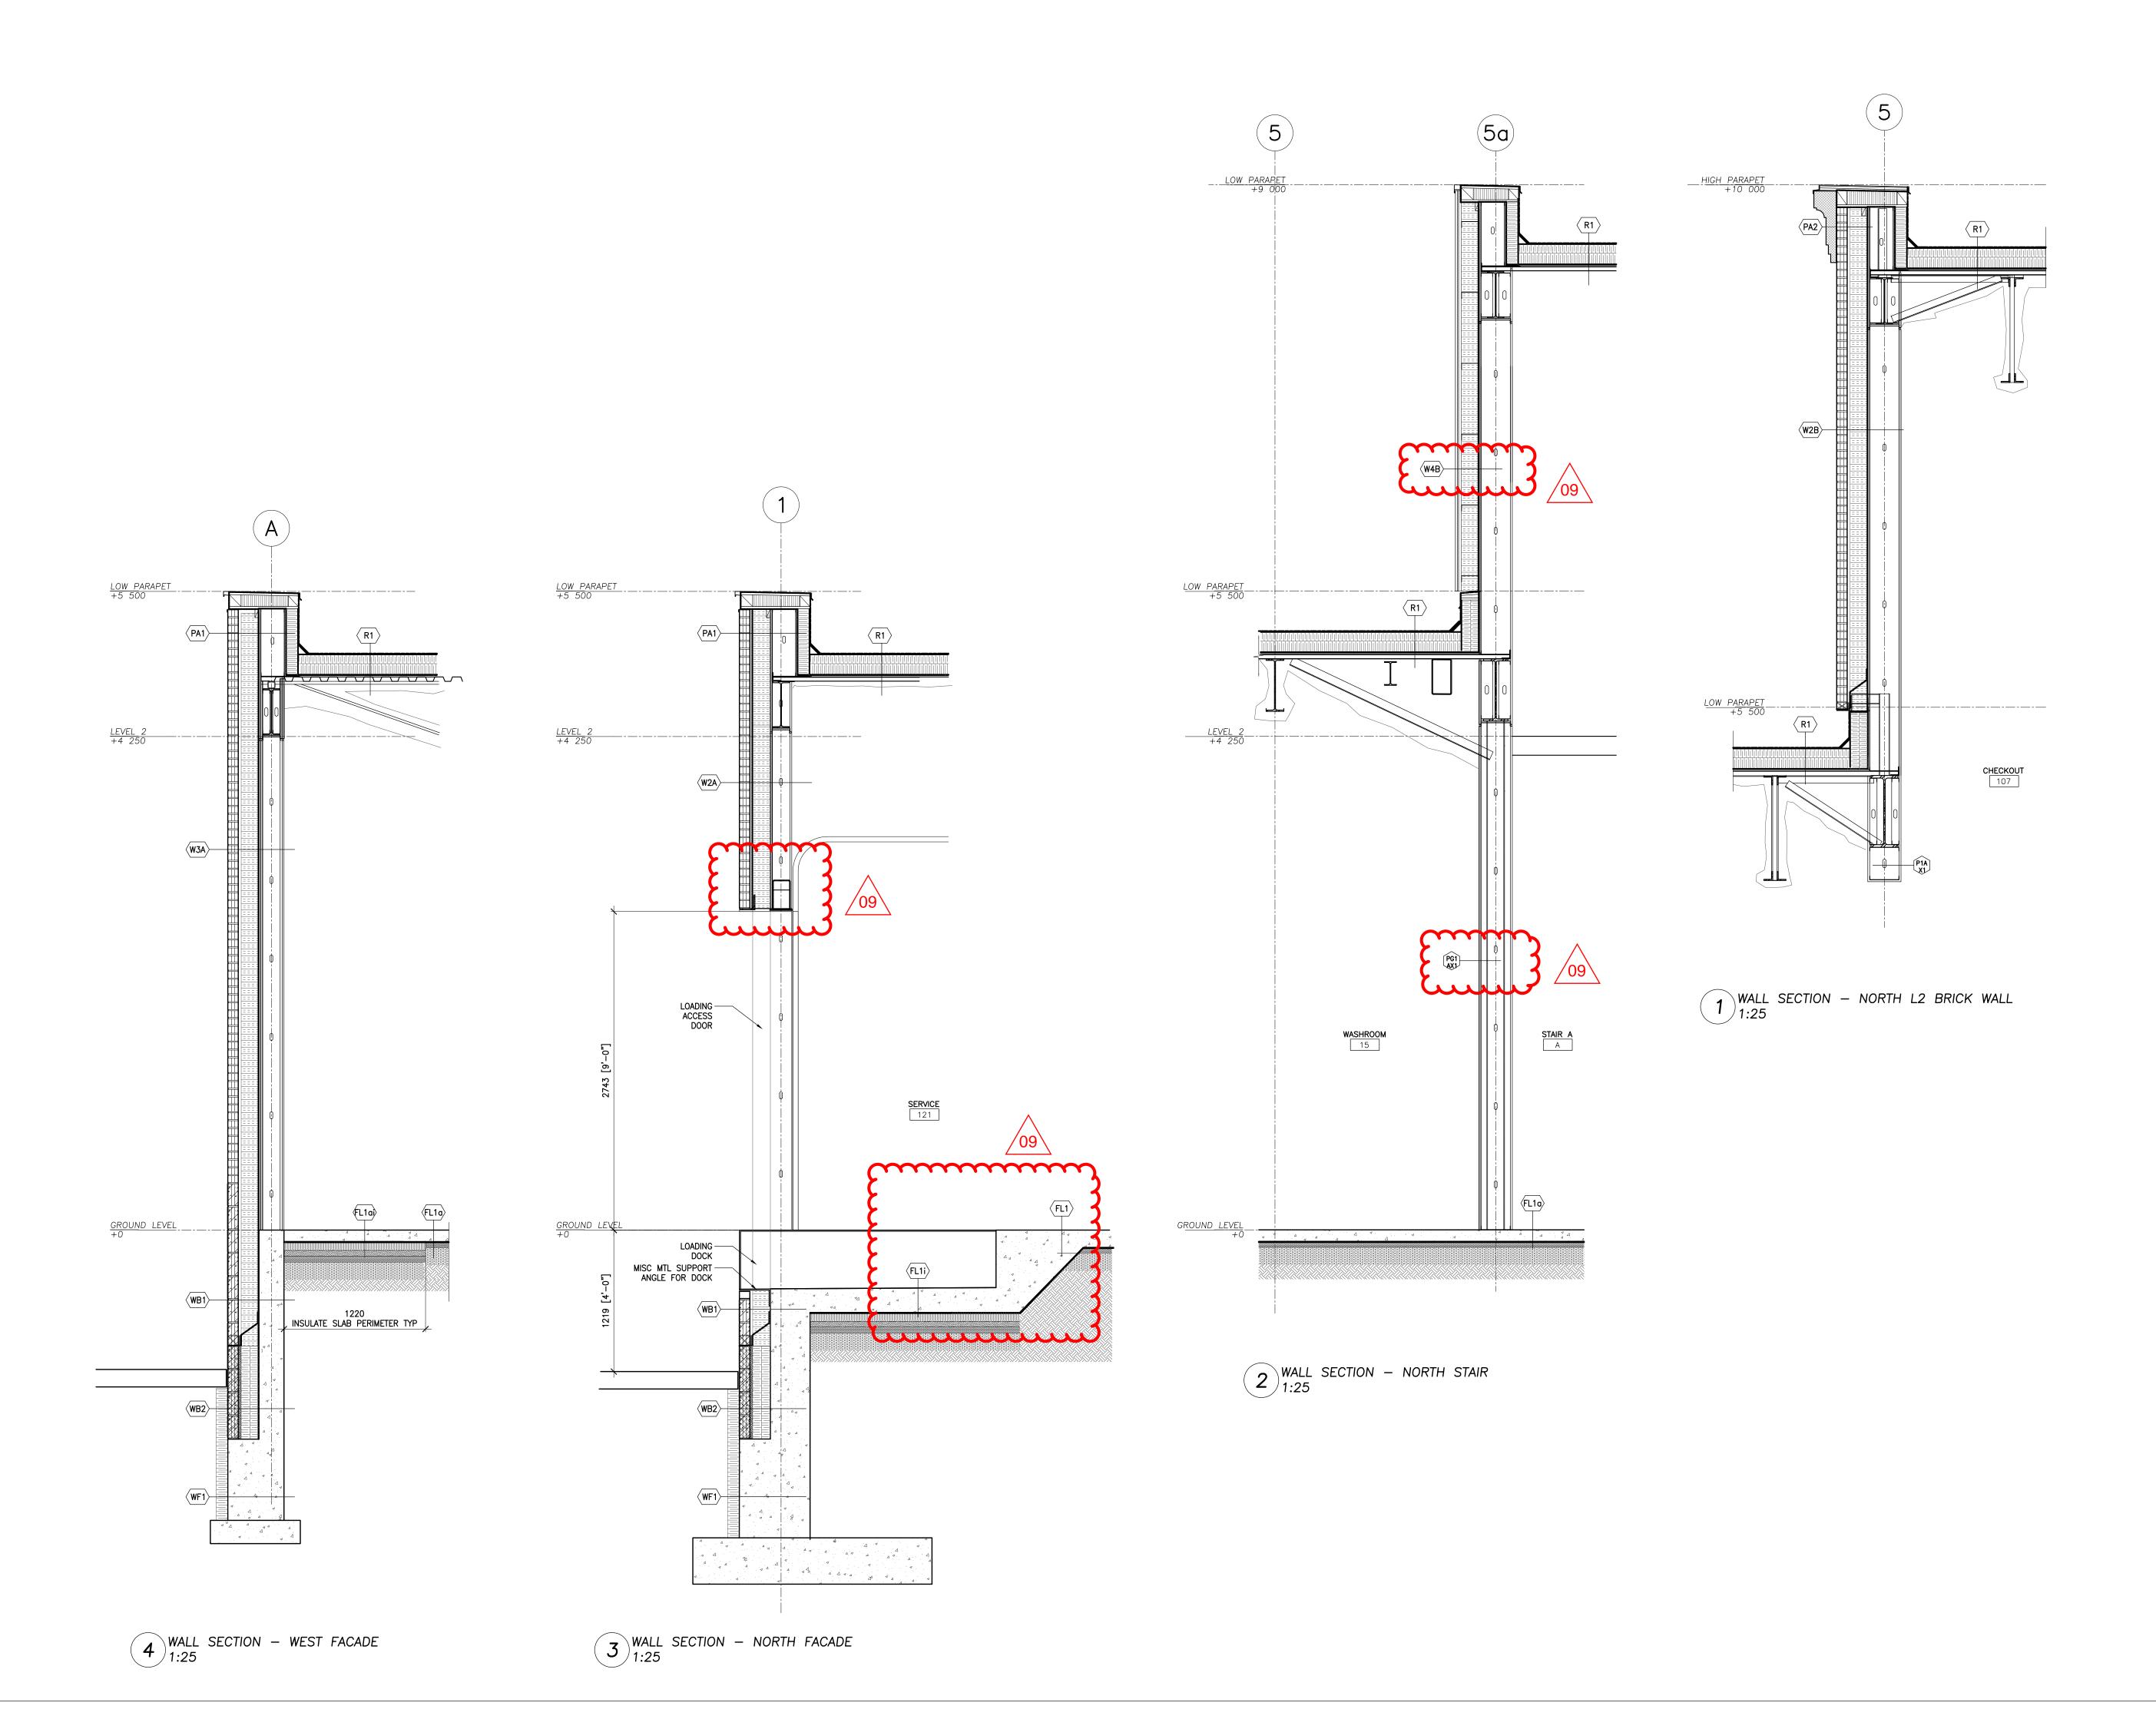
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### BLACKWELL STRUCTURAL ENGINEERS

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134 PETER STREET, SUITE 1301 TORONTO, ONTARIO, M5V 2H2 TEL 416.593.5300 FAX 416.593.4840

SMITH + ANDERSON


MECHANICAL AND ELECTRICAL ENGINEERS

1100 - 100 SHEPPARD AVENUE EAST
TORONTO, ONTARIO, M2N 6N5

## SAYERS FOOD LIMITED

132 BURLEIGH STREET t: 705.656.4531 e: sayers@apsley.ca

NORTH ARR

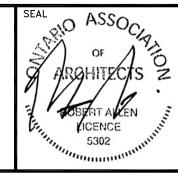

PROJECT TITLE

NEW SAYERS FOOD STORE BURLEIGH STREET, APSLEY

DRAWING TITLE

DELI AND BAKERY
INTERIOR WALL SECTIONS

1:10

SEPTEMBER 27, 2021

PROJECT NUMBER 2102

DRAWING NUMBER



### Smith + Andersen

1100 – 100 Sheppard Ave. East, Toronto ON, M2N 6N5 416 487 8151 f 416 487 9104 smithandandersen.com

PROJECT NAME: New Sayers Food Store				
COMPANY: MacLennan Jaunkains Miller Architects				
ATTENTION: Andrew Bramm				
PROJECT NO.: 21376.000	DATE: 2021-09-27			
ADDENDUM NO.: M-2	ISSUED BY: Leting Xue			
The following amendments are hereby made as part of the Contract Documents. The following revisions and/or additions shall be made to contract documents and the cost shall be included in the Tender Price.				

#### 1.0 SCHEDULES

- 1.1 Refer to Roof Top Unit Schedule (Re-issued)
- 1.1.1 Removed Humidification capacity for all units
- 1.1.2 Added Unit Weight for all units


#### 2.0 DRAWINGS

- 2.1 Refer to M300 FOUNDATION PLAN PLUMBING AND DRAINAGE (Re-issued)
- 2.1.1 Added missing 38Ø sanitary drain from sink above in Room 119 Meat Prep
- 2.1.2 Added missing 100Ø sanitary drain from 100Ø F.D. in Room 118 Meat Cooler
- 2.1.3 Revised two R.W.L. outside the north wall to 100Ø
- 2.1.4 Relocated 200Ø R.W.L. riser and rerouted horizontal piping
- 2.1.5 Relocated 100Ø sanitary riser and rerouted horizontal piping
- 2.1.6 Relocated 100Ø sanitary drain from 100Ø F.F.D. serving Room 118 Meat Cooler and 117 Walk-in Produce
- 2.2 Refer to M301 GROUND FLOOR PLAN PLUMBING AND DRAINAGE (Re-issued)
- 2.2.1 Relocated the F.F.D. serving Room 118 Meat Cooler and Room 117 Walk-in Produce
- 2.2.2 Rerouted the condensate drain line in Room 118 Meat Cooler and Room 117 Walk-in Produce
- 2.2.3 Added a hose bib east of Room 102 Entry Vestibule

## Smith + Andersen

2.2.4	Relocated 25Ø D.C.W. riser and rerouted piping in Room 101 Exit Vestibule
2.2.5	Relocated one F.E.C. to the north east corner
2.3	Refer to M302 SECOND FLOOR PLAN PLUMBING AND DRAINAGE (Re-issued)
2.3.1	Revised all four R.D. on the north canopy to 100Ø
2.3.2	Relocated 25Ø D.C.W. riser into the north wall and rerouted piping
2.3.3	Relocated all three DHWH and DHWH Recirculation pump and rerouted piping
2.3.4	Resized RO system storage tank
2.3.5	Relocated F.E.C. in the south corridor
2.3.6	Relocated 200Ø R.W.L. riser to Room 202 Staff Lounge and rerouted piping
2.4	Refer to M402 SECOND FLOOR PLAN HVAC (Re-issued)
2.4.1	Relocated all three DHWH and revised vent and combustion air duct layout
2.4.2	Removed return grille in Room 207 Storage
2.4.3	Revised EB layout and capacity in Room 202 Staff Lounge
2.5	Refer to M501 GROUND FLOOR PLAN KITCHEN PLUMBING AND DRAINAGE (Reissued)
2.5.1	Relocated F.E.C. to above Sink 32
2.5.2	Relocated F.E.C. to the south west corner
2.5.3	Relocated 200Ø R.W.L. riser from above and rerouted piping
2.5.4	Relocated 200Ø R.W.L. riser and 100Ø sanitary riser down and rerouted piping
3.0	CLARIFICATION
3.1.1	No further items for this addendum
	END OF MECHANICAL ADDENDUM

EQUIPMENT NO.			RTU-	-01	RTU	I-02	RTU	J-03	RTU	-04	MUA	<b>\-01</b>					
SUPPLY FAN	cfm	L/s	3,000	1,416	1,750	826	4,400	2,077	4,450		2,145	1,012					
External Static Pressure	In H2O	Pa	1.5	373	1.5	373	1.5	373	1.5	373	8.0	187					
RPM			1,04	-2	1,4		1,1		1,1		1,4						
Motor	hp	kW	3.0	2.24	2.0	1.49	5.0	3.73	5.0	3.73	0.8	0.61					
Fan Control (vfd/viv/cv)			•														
Outlet sound Power Levels 1 to	6																
Supply Fan Efficiency	%																
RETURN FAN	cfm	L/s	2,700	1,274	1,500	708	4,400	2,077	4,300	2,030							
External Static Pressure	In H2O	Pa	1.25	311	1.25	311	1.25	311	1.25	311							
RPM			•														-
Motor	hp	kW					i I										
Fan Control (vfd/viv/cv)	p				Į.										1		
Inlet sound Power Levels 1 to 6	3																
Return Fan Efficiency	- %																
Neturn Fan Eniciency	70						+										
COOLING (total)	MBH	kW	119.9	35	61.7	18	154.0	45	153.8	45	114.7	34			l <u></u>		
Sensible Capacity	MBH	kW	78.7	23	45.1	13	112.1	33	113.2	33	57.8	17		<del></del>			
	°F	°C	76.7	24.9	76.2	24.6	75.9	24.4	75.8	24.3	84.2	29.0					
Entering Air Temperature (db)																	
Entering Air Temperature (wb)	°F	°C	64.5	18.1	63.8	17.7	63.7	17.6	63.5	17.5	73.4	23.0					
Leaving Air Temperature (db)	°F	°C	51.8	11.0	51.7	10.9	51.6	10.9	51.6	10.9	75.0	23.9					
Leaving Air Temperature (wb)	°F	°C	50.1	10.1	51.2	10.7	51.2	10.7	51.1	10.6	62.5	16.9					
EER	BTU/Wh																
HEATING	MBH	kW	144.0	40	86.0	25	144.0	40	144.0	40	250.0	73			1		
				42				42		42							
Entering Air Temperature (db)	°F	°C	55.6	13.1	61.1	16.2	62.2	16.8	63.4	17.4	-23.8	-31.0					
Type (gas/elec/glycol)			Propa	ane	Prop	ane	Prop	ane	Prop	ane	Prop	ane					
Stages of Electrical Heating											ļ						
Entering Glycol Temperature	°F	°C															
Glycol Flow Rate	USgpm	L/min															
Glycol Pressure Drop	ft H2O	kPa															
Gas Pressure Supplied	psig	kPa	0.25	2	0.25	2	0.25	2	0.25	2	0.25	2					
Heating Efficiency	%						1										
FILTERS																	
Pre-filter	in.	mm.			I		1		1								
Final filter	in.	mm.															
i illai illei	111.	111111.					<del>                                     </del>										
			$\sim\sim$	$\overline{\sim}$	~~~	$\overline{\sim}$		$\overline{\sim}$		$\overline{\sim}$	<b>~~~</b>	$\overline{\sim}$					
HUMIDIFICATION (integral)	lbs/hr	kg/hr	, , , ,		, , , , , , , , , , , , , , , , , , ,			_, , ,	, , , ,	_, , , ,	<del>                                     </del>	<del>``</del>		-			
UNIT WEIGHT	100/111	1.g/1	1363	lh	89	7lh	148	3lh	148	3lh	321	2lh	<u>k</u>		l	l l	-
ONIT WEIGHT			تتك	ححث	تتحد	تحكث	تتحل	كك	تتحك	حكت	تتحد	<del>\( \) \( \) \</del>	)				
CONDENSER																	
Ambient Air Temperature	°F	°C	86.0	30.0	86.0	30.0	86.0	30.0	86.0	30.0							
No. of Compressers					1		1								l.	l l	
Compressor Motor (each)	hp	kW							1								
Compresser meter (cash)			l l		I		1								<u> </u>		
ELECTRICAL																	
ELECTRICAL			000:	100	2027	0/00	2027	0/00	2027	2/00	200	0/00					
Volts/Phase/Cycle			208/3		208/		208/		208/3		208/						
Maximum Circuit Ampacity			54		3	0	7:	3	73	3	53	.1					
							1										
REMARKS							<b></b>										
							1										

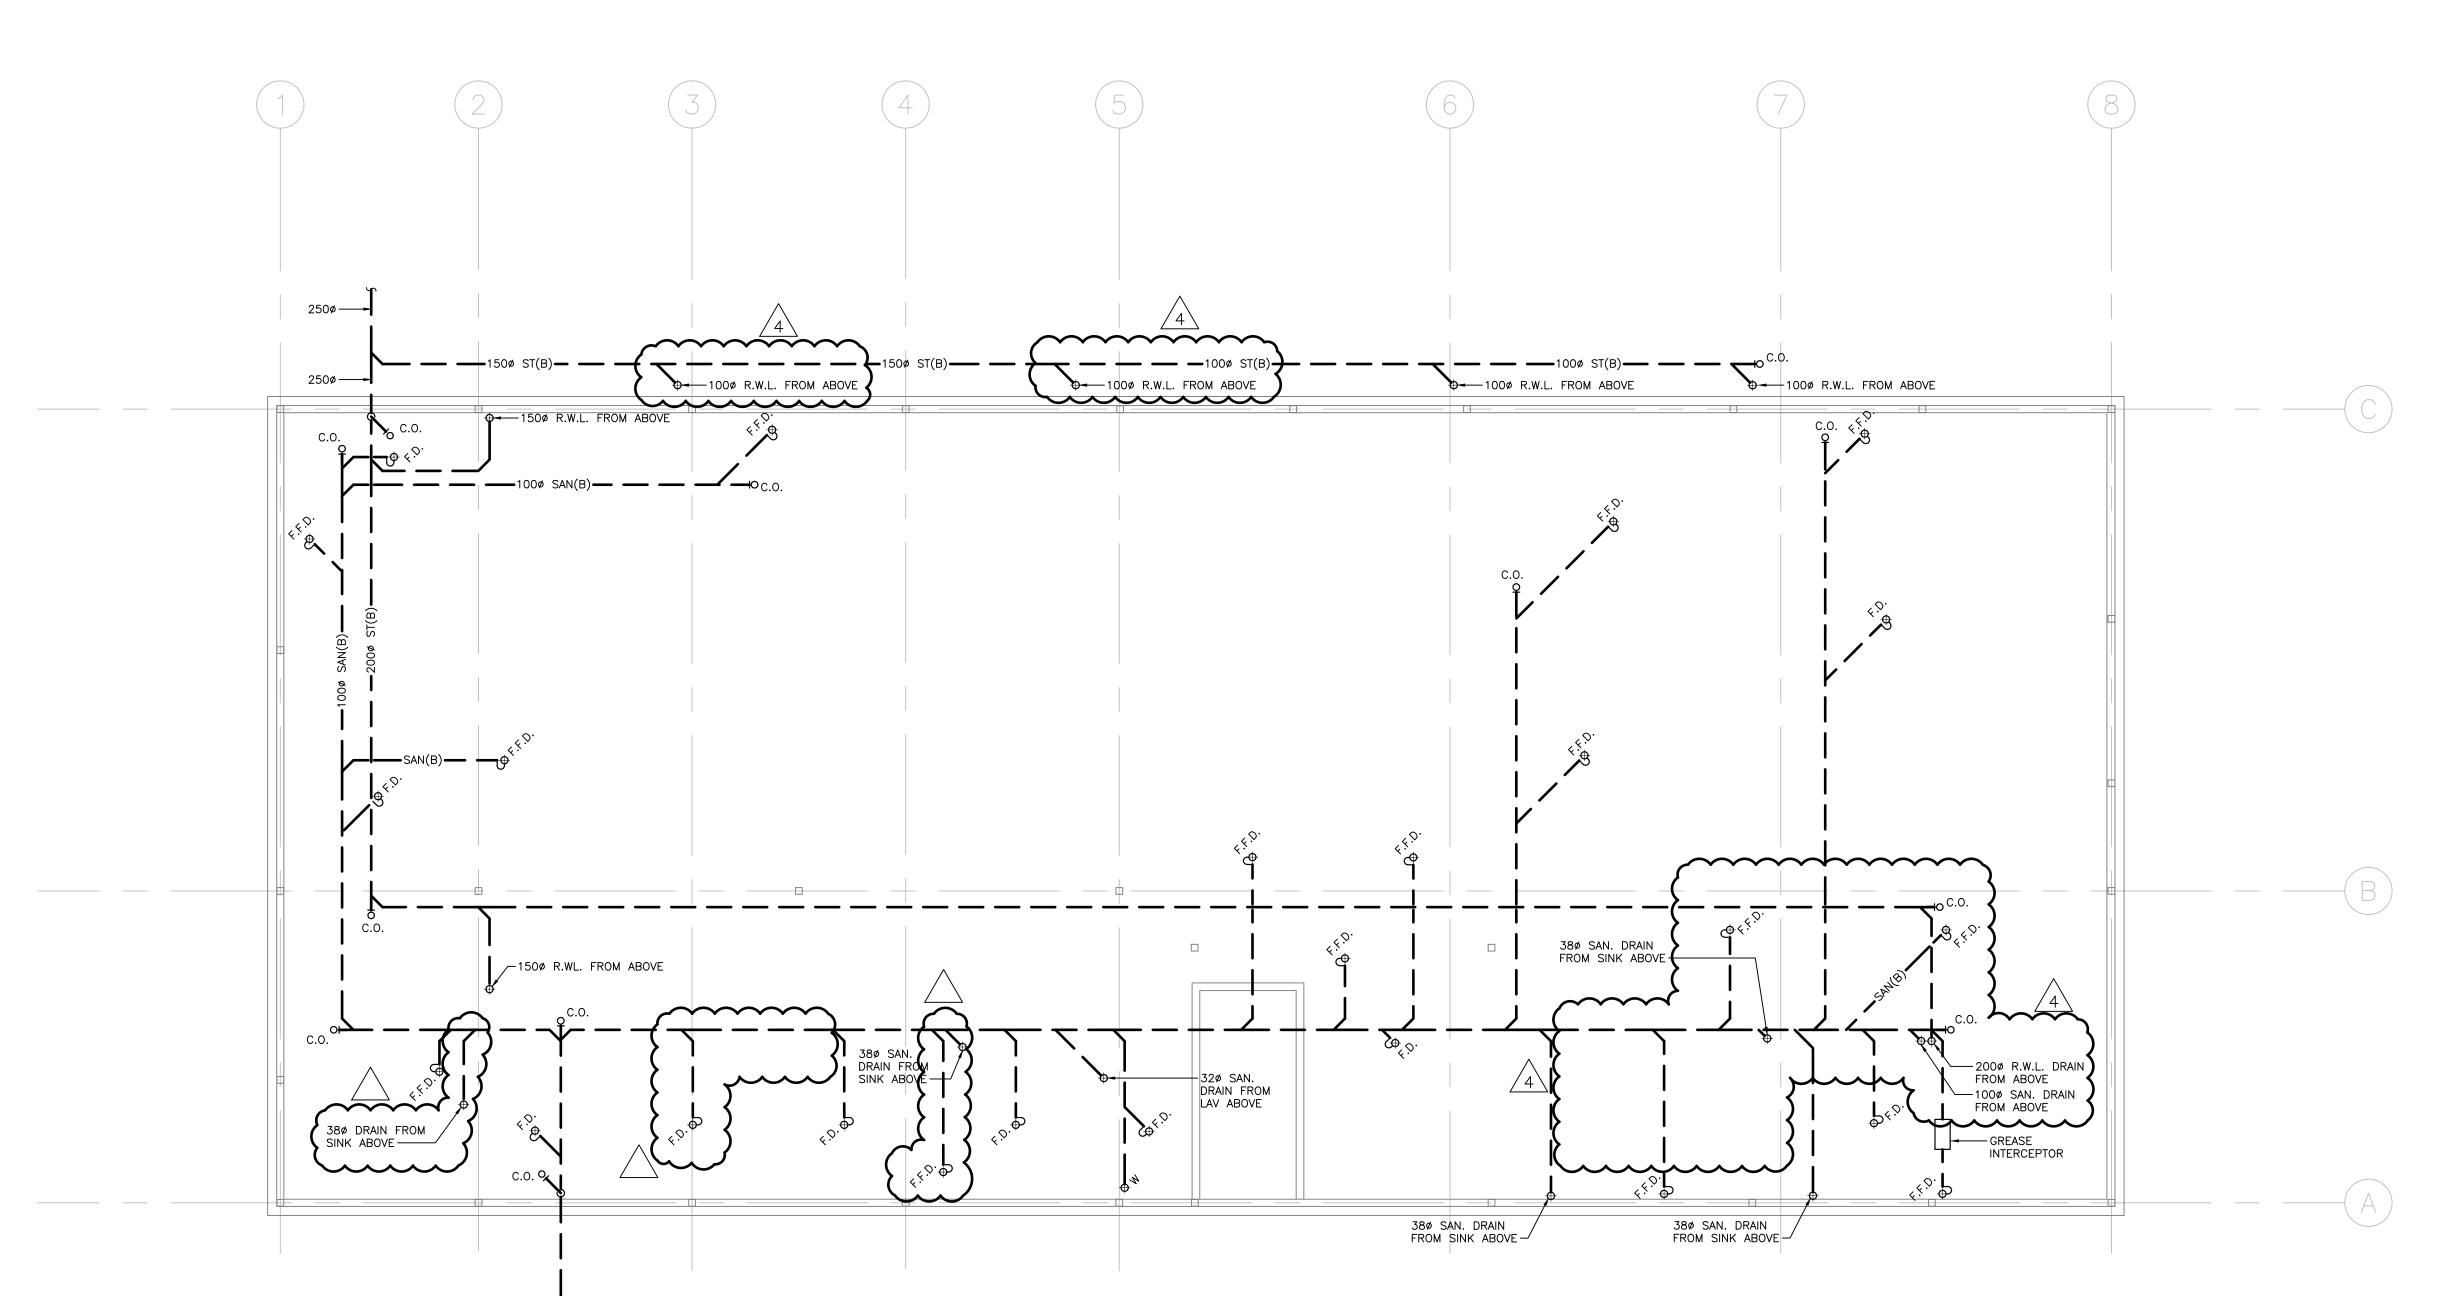

- DO NOT SCALE DRAWINGS. THE LOCATIONS OF ALL ITEMS SHOWN ON THE DRAWINGS OR SPECIFIED THAT ARE NOT DEFINITELY FIXED BY DIMENSIONS ARE APPROXIMATE. DETERMINE THE EXACT LOCATIONS NECESSARY TO SECURE THE BEST CONDITIONS AND RESULTS BASED ON SITE CONDITIONS. REVIEW ALL REVISIONS WITH THE CONSULTANT.
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  2. READ FLOOR PLANS IN CONJUNCTION WITH SCHEMATICS.
  ASSUME INFORMATION SHOWN ON FLOOR PLANS TO BE
  APPLICABLE TO THE RELATED SYSTEM SCHEMATIC AND
  VICE—VERSA TO PROVIDE A COMPLETE AND OPERATIONAL
- VERIFY STRUCTURAL INTEGRITY OF ALL TEMPORARY AND PERMANENT OPENINGS. PROVIDE ADDITIONAL FRAMING TO ENSURE STRUCTURAL INTEGRITY AS REQUIRED.
- 4. REFER TO THE STANDARD DETAILS AND DETAIL SHEETS FOR ADDITIONAL INFORMATION.

### PLUMBING AND DRAINAGE NOTES:

- PROVIDE MINIMUM 75mm (3 IN.) FOR UNDER GROUND SANITARY DRAINAGE UNLESS INDICATED OTHERWISE.
   PROVIDE APPROVED BACK FLOW PREVENTION FOR ALL TRAP PRIMER SYSTEMS.
- PROVIDE MINIMUM 100mm (4 IN.) FOR UNDER GROUND STORM DRAINAGE UNLESS INDICATED OTHERWISE.
- 4. PROVIDE MINIMUM 19mm (3/4 IN.) DOMESTIC COLD WATER AND DOMESTIC HOT WATER PIPES UNLESS INDICATED OTHERWISE
- 5. INSTALL ALL PIPING OVERHEAD, TIGHT TO UNDERSIDE OF THE STRUCTURE WITH SUFFICIENT ROOM FOR INSULATION UNLESS INDICATED OTHERWISE. ROUTE PIPING WITHIN STRUCTURAL STEEL STRATA OR THROUGH CONCRETE BEAMS WHERE
- 6. HEAT TRACE THE ENTIRE SERVICE TO BE PROTECTED FROM FREEZING IN ALL AREAS INDICATED ON THE DRAWINGS AND NOTED IN THE SPECIFICATIONS. PROVIDE HEAT TRACING TO ACCOMMODATE ALTERATIONS IN THE PIPE LAYOUT DUE TO INTERFERENCES OR OTHER INSTALLATION REQUIREMENTS. CONNECT HEAT TRACING CIRCUIT TO THE ELECTRICAL POWER LOCATIONS INDICATED ON THE DRAWINGS OR THE NEAREST CIRCUIT AVAILABLE. COORDINATE WITH ELECTRICAL DIVISION.
  7. PROVIDE SHUT-OFF VALVES ON ALL MAIN RISERS AND AT EACH CONNECTION TO EQUIPMENT.
- PROVIDE COMPLETE VENTING SYSTEMS IN ACCORDANCE WITH THE PLUMBING OR BUILDING CODE.
- HEAT TRACE ALL PIPING WITHIN UNHEATED SPACES SUCH AS PARKING LEVELS, SOFFITS AND WITHIN WALLS WHERE FREEZING MAY OCCUR.

Contractor must check and verify all dimensions on the job, and report any discrepancies to the Architect before proceeding with the work.

Do not scale this drawing.

REVISIONS AND ISSUES

REV DESCRIPTION DATE

1 ISSUED FOR TENDER 2021.08.25

2 ISSUED FOR PERMIT 2021.09.09

3 ISSUED FOR ADDENDUM #1 2021.09.15

4 ISSUED FOR ADDENDUM #2 2021.09.27

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## TRITON ENGINEERING SERVICES LTD CIVIL ENGINEERS

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## BLACKWELL STRUCTURAL ENGINEERS

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### SMITH + ANDERSON MECHANICAL AND ELECTRICAL ENGINEERS

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TEL 416.487.8151 -

Smith + Andersen

1100 — 100 Sheppard Ave. East, Toronto On, M2N 6N5 416 487 8151 f 416 487 9104 smithandandersen.com

# SAYERS FOOD LIMITED

132 BURLEIGH STREET t: 705.656.4531 e: sayers@apsley.ca

NORTH ARROW SEAL

## PROJECT TIT

NEW SAYERS FOOD STORE BURLEIGH STREET, APSLEY

## DRAWING TITLE

FOUNDATION PLAN
PLUMBING AND DRAINAGE


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JUNE 16, 2021

PROJECT NUMBER 21076

DRAWING NUMBER

M300

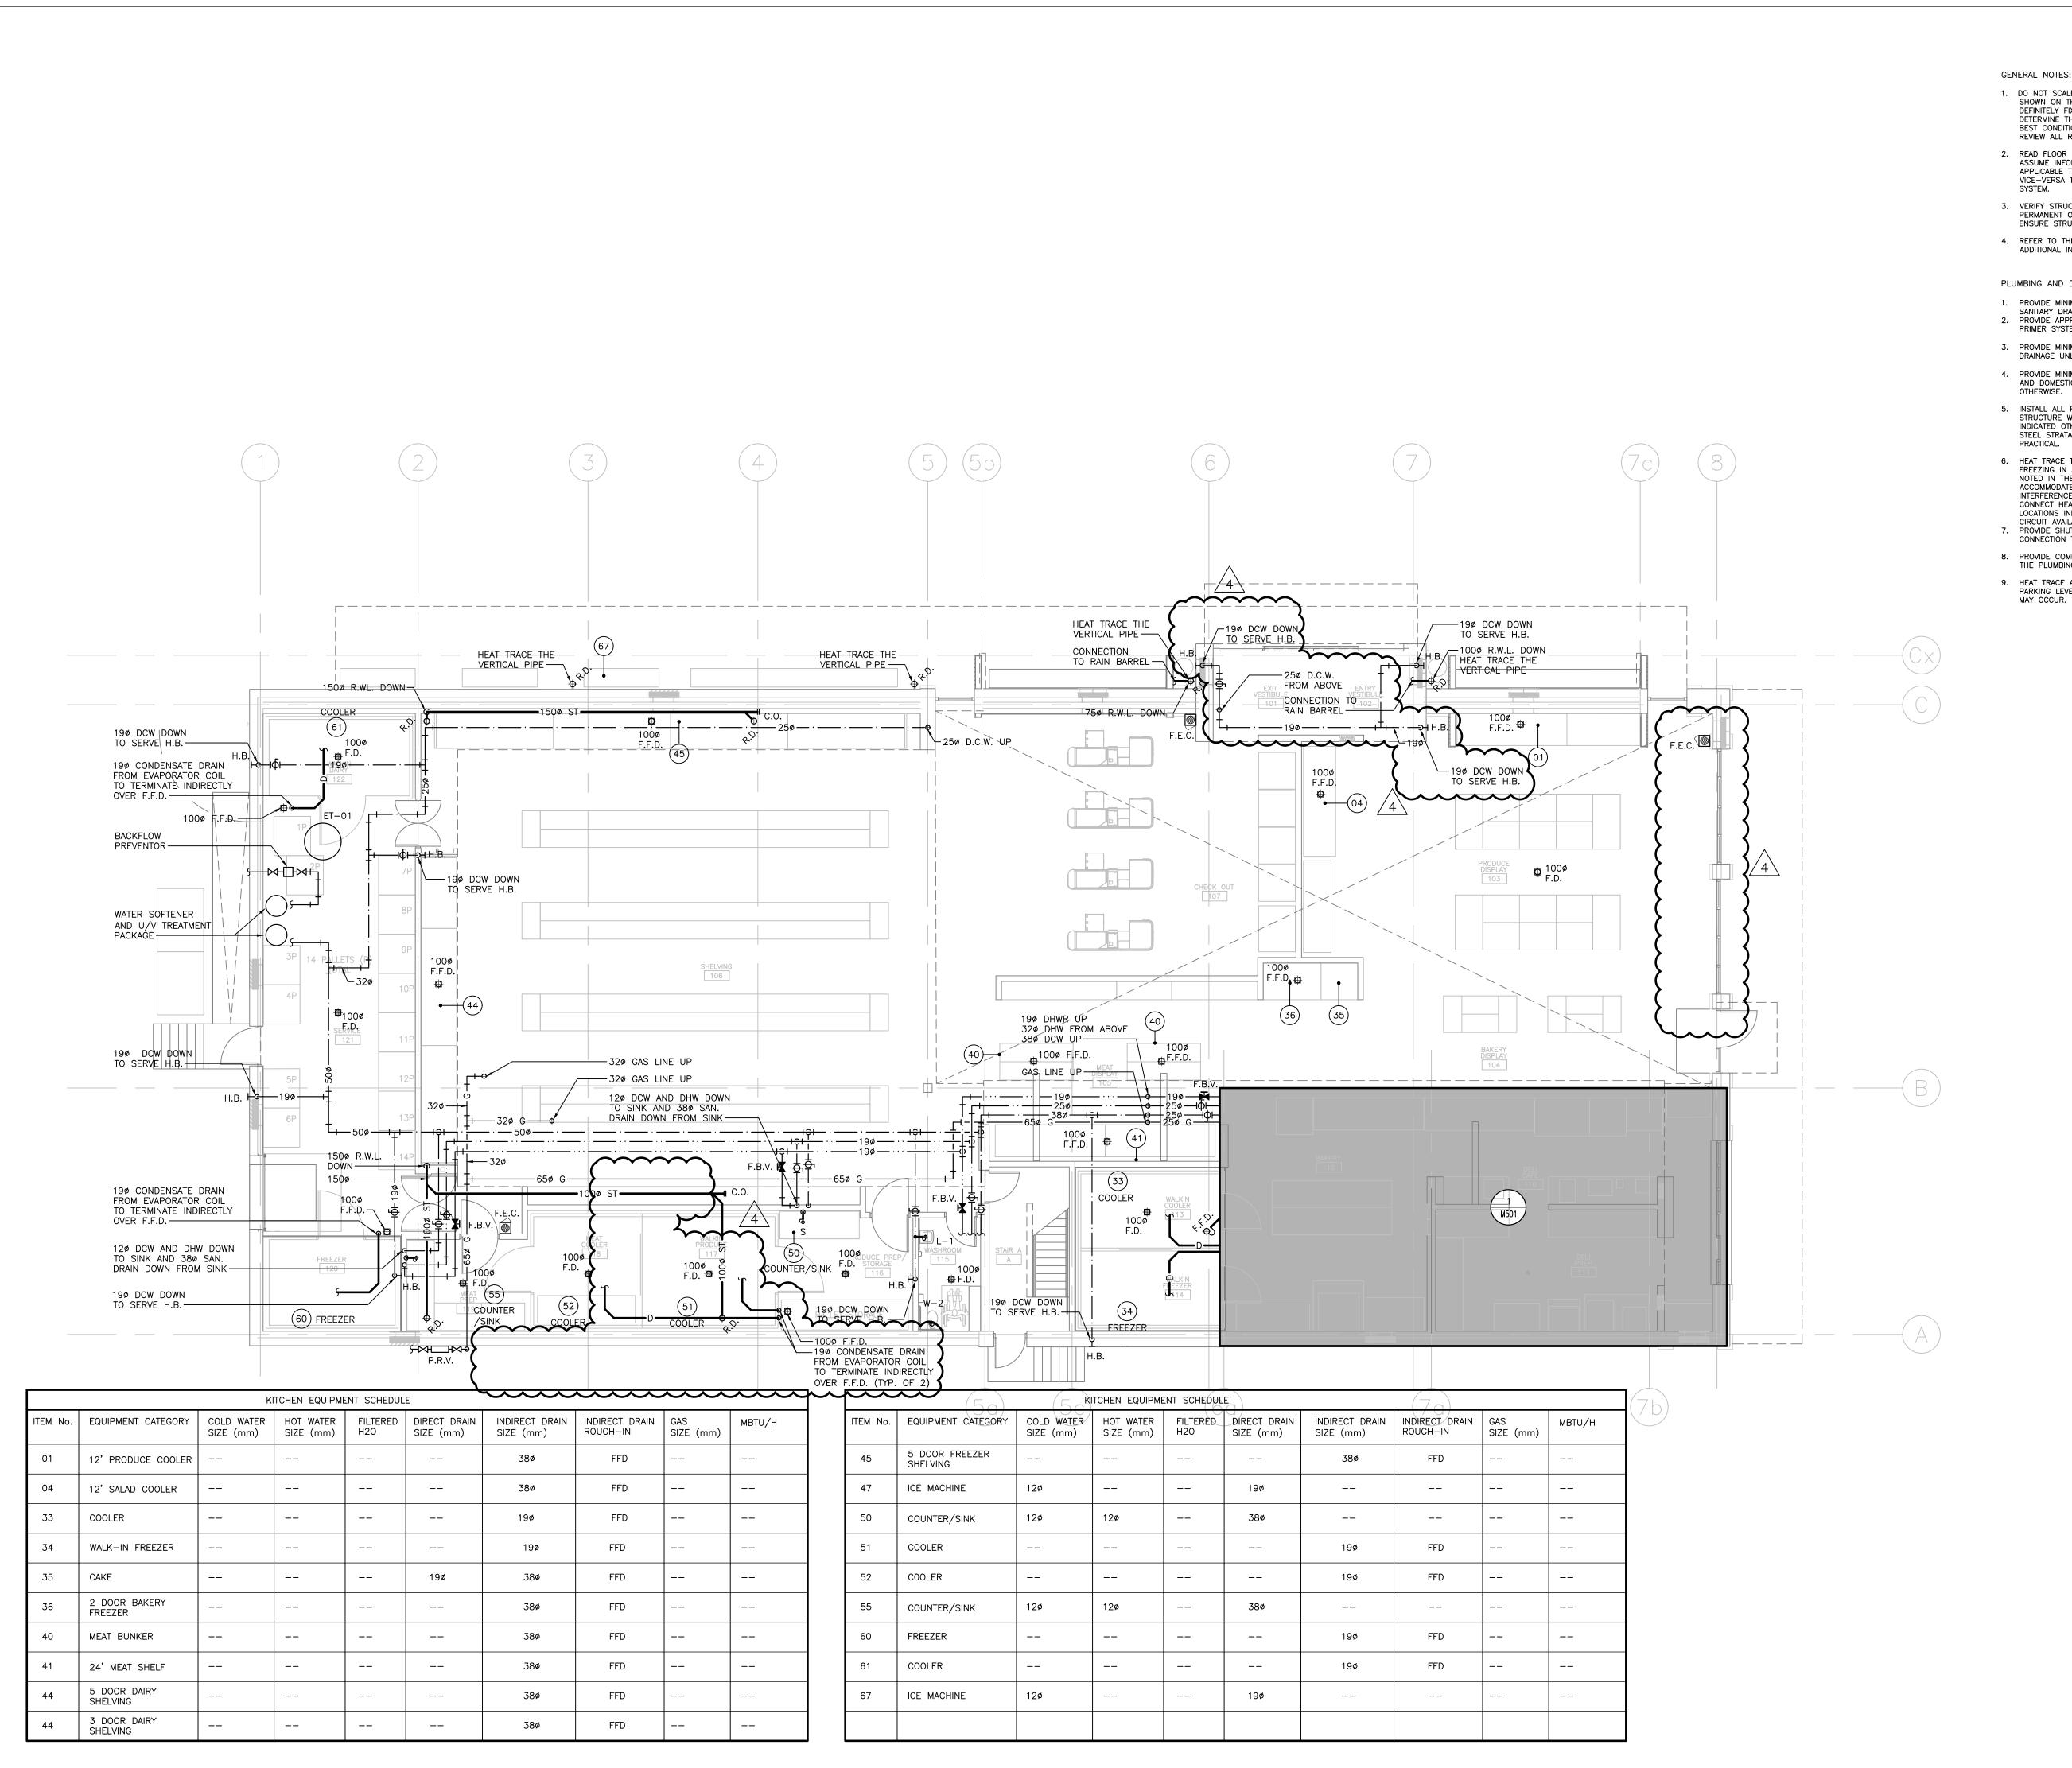

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- VERIFY STRUCTURAL INTEGRITY OF ALL TEMPORARY AND PERMANENT OPENINGS. PROVIDE ADDITIONAL FRAMING TO ENSURE STRUCTURAL INTEGRITY AS REQUIRED.
- 4. REFER TO THE STANDARD DETAILS AND DETAIL SHEETS FOR ADDITIONAL INFORMATION.

## PLUMBING AND DRAINAGE NOTES:

- 1. PROVIDE MINIMUM 75mm (3 IN.) FOR UNDER GROUND SANITARY DRAINAGE UNLESS INDICATED OTHERWISE.
  2. PROVIDE APPROVED BACK FLOW PREVENTION FOR ALL TRAP
- 3. PROVIDE MINIMUM 100mm (4 IN.) FOR UNDER GROUND STORM DRAINAGE UNLESS INDICATED OTHERWISE.
- 4. PROVIDE MINIMUM 19mm (3/4 IN.) DOMESTIC COLD WATER AND DOMESTIC HOT WATER PIPES UNLESS INDICATED
- INSTALL ALL PIPING OVERHEAD, TIGHT TO UNDERSIDE OF THE STRUCTURE WITH SUFFICIENT ROOM FOR INSULATION UNLESS INDICATED OTHERWISE. ROUTE PIPING WITHIN STRUCTURAL STEEL STRATA OR THROUGH CONCRETE BEAMS WHERE
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REVISIONS AND ISSUES

REV	DESCRIPTION	DATE	
1	ISSUED FOR TENDER	2021.08.25	
2	ISSUED FOR PERMIT	2021.09.09	
3	ISSUED FOR ADDENDUM #1	2021.09.15	
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6			

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## SAYERS FOOD LIMITED

132 BURLEIGH STREET t: 705.656.4531 e: sayers@apsley.ca

NORTH ARROW	SEAL

## PROJECT TITLE

NEW SAYERS FOOD STORE BURLEIGH STREET, APSLEY


## DRAWING TITLE

GROUND FLOOR PLAN PLUMBING AND DRAINAGE

SCALE 1:100

JUNE 16, 2021

PROJECT NUMBER

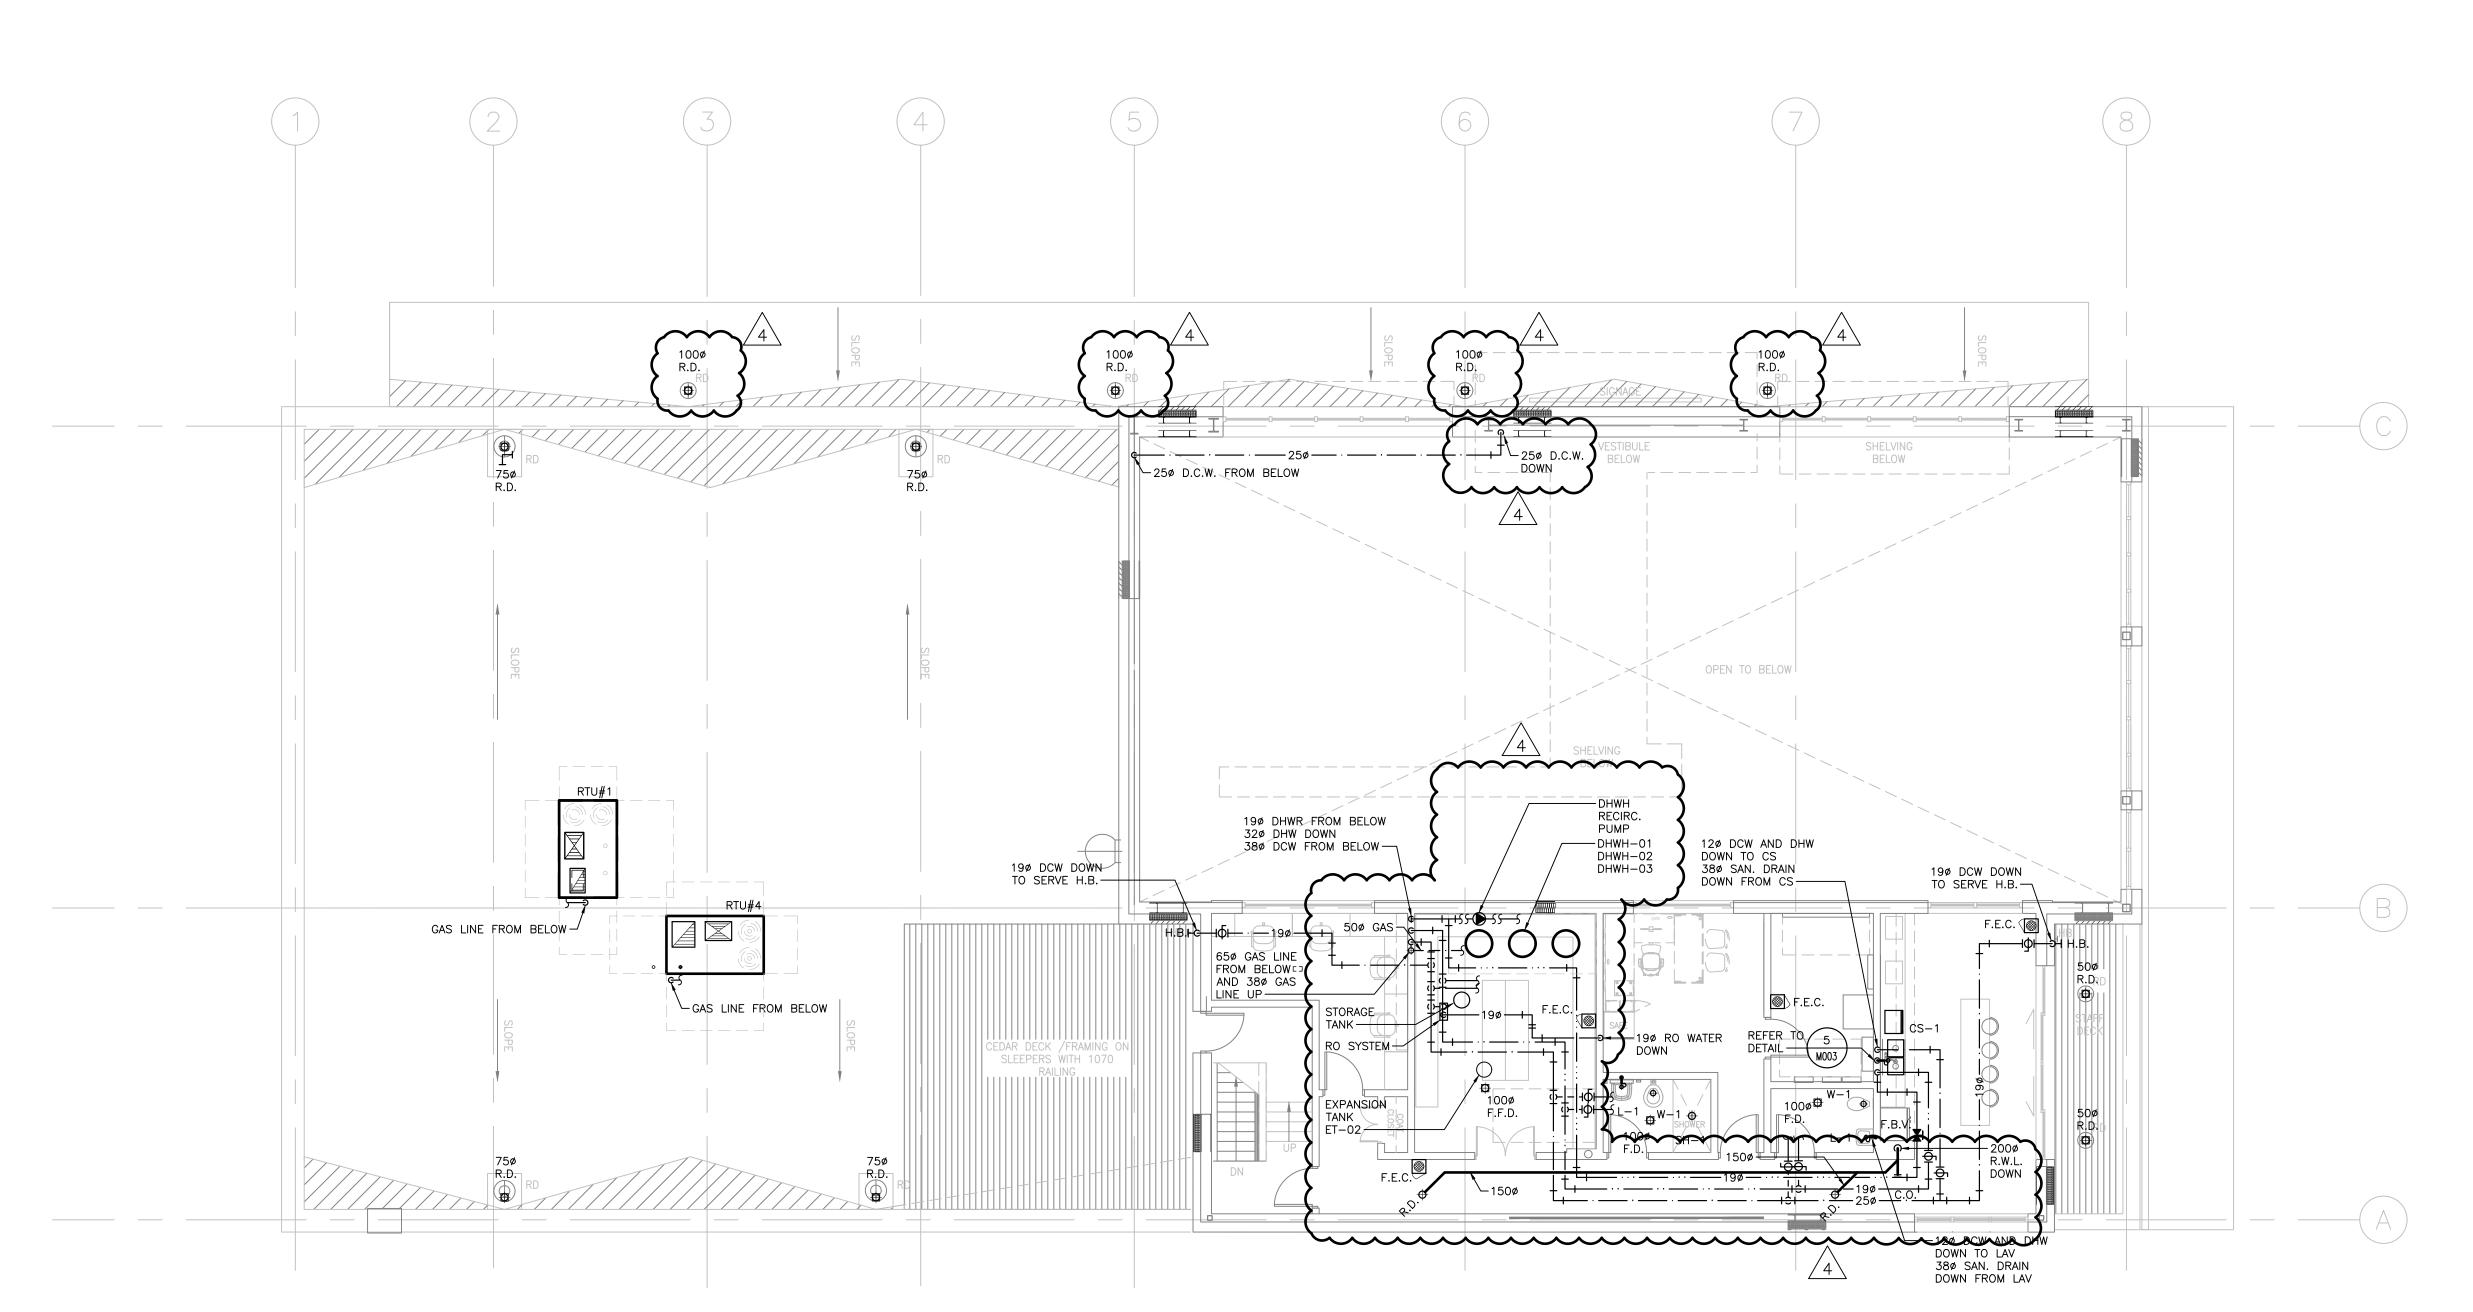

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- VERIFY STRUCTURAL INTEGRITY OF ALL TEMPORARY AND PERMANENT OPENINGS. PROVIDE ADDITIONAL FRAMING TO ENSURE STRUCTURAL INTEGRITY AS REQUIRED.
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### PLUMBING AND DRAINAGE NOTES:

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   PROVIDE APPROVED BACK FLOW PREVENTION FOR ALL TRAP PRIMER SYSTEMS.
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- 4. PROVIDE MINIMUM 19mm (3/4 IN.) DOMESTIC COLD WATER AND DOMESTIC HOT WATER PIPES UNLESS INDICATED
- 5. INSTALL ALL PIPING OVERHEAD, TIGHT TO UNDERSIDE OF THE STRUCTURE WITH SUFFICIENT ROOM FOR INSULATION UNLESS INDICATED OTHERWISE. ROUTE PIPING WITHIN STRUCTURAL STEEL STRATA OR THROUGH CONCRETE BEAMS WHERE
- 6. HEAT TRACE THE ENTIRE SERVICE TO BE PROTECTED FROM FREEZING IN ALL AREAS INDICATED ON THE DRAWINGS AND NOTED IN THE SPECIFICATIONS. PROVIDE HEAT TRACING TO ACCOMMODATE ALTERATIONS IN THE PIPE LAYOUT DUE TO INTERFERENCES OR OTHER INSTALLATION REQUIREMENTS. CONNECT HEAT TRACING CIRCUIT TO THE ELECTRICAL POWER LOCATIONS INDICATED ON THE DRAWINGS OR THE NEAREST CIRCUIT AVAILABLE. COORDINATE WITH ELECTRICAL DIVISION.
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- 8. PROVIDE COMPLETE VENTING SYSTEMS IN ACCORDANCE WITH

THE PLUMBING OR BUILDING CODE.

 HEAT TRACE ALL PIPING WITHIN UNHEATED SPACES SUCH AS PARKING LEVELS, SOFFITS AND WITHIN WALLS WHERE FREEZING MAY OCCUR. Contractor must check and verify all dimensions on the job, and report any discrepancies to the Architect before proceeding with the work.

Do not scale this drawing.

REVISIONS AND ISSUES

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5			
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# SAYERS FOOD LIMITED

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## PROJECT TITLE

NEW SAYERS FOOD STORE BURLEIGH STREET, APSLEY

## DRAWING TITLE

SECOND FLOOR PLAN PLUMBING AND DRAINAGE


1

JUNE 16, 2021

PROJECT NUMBER

21076
DRAWING NUMBER

M302

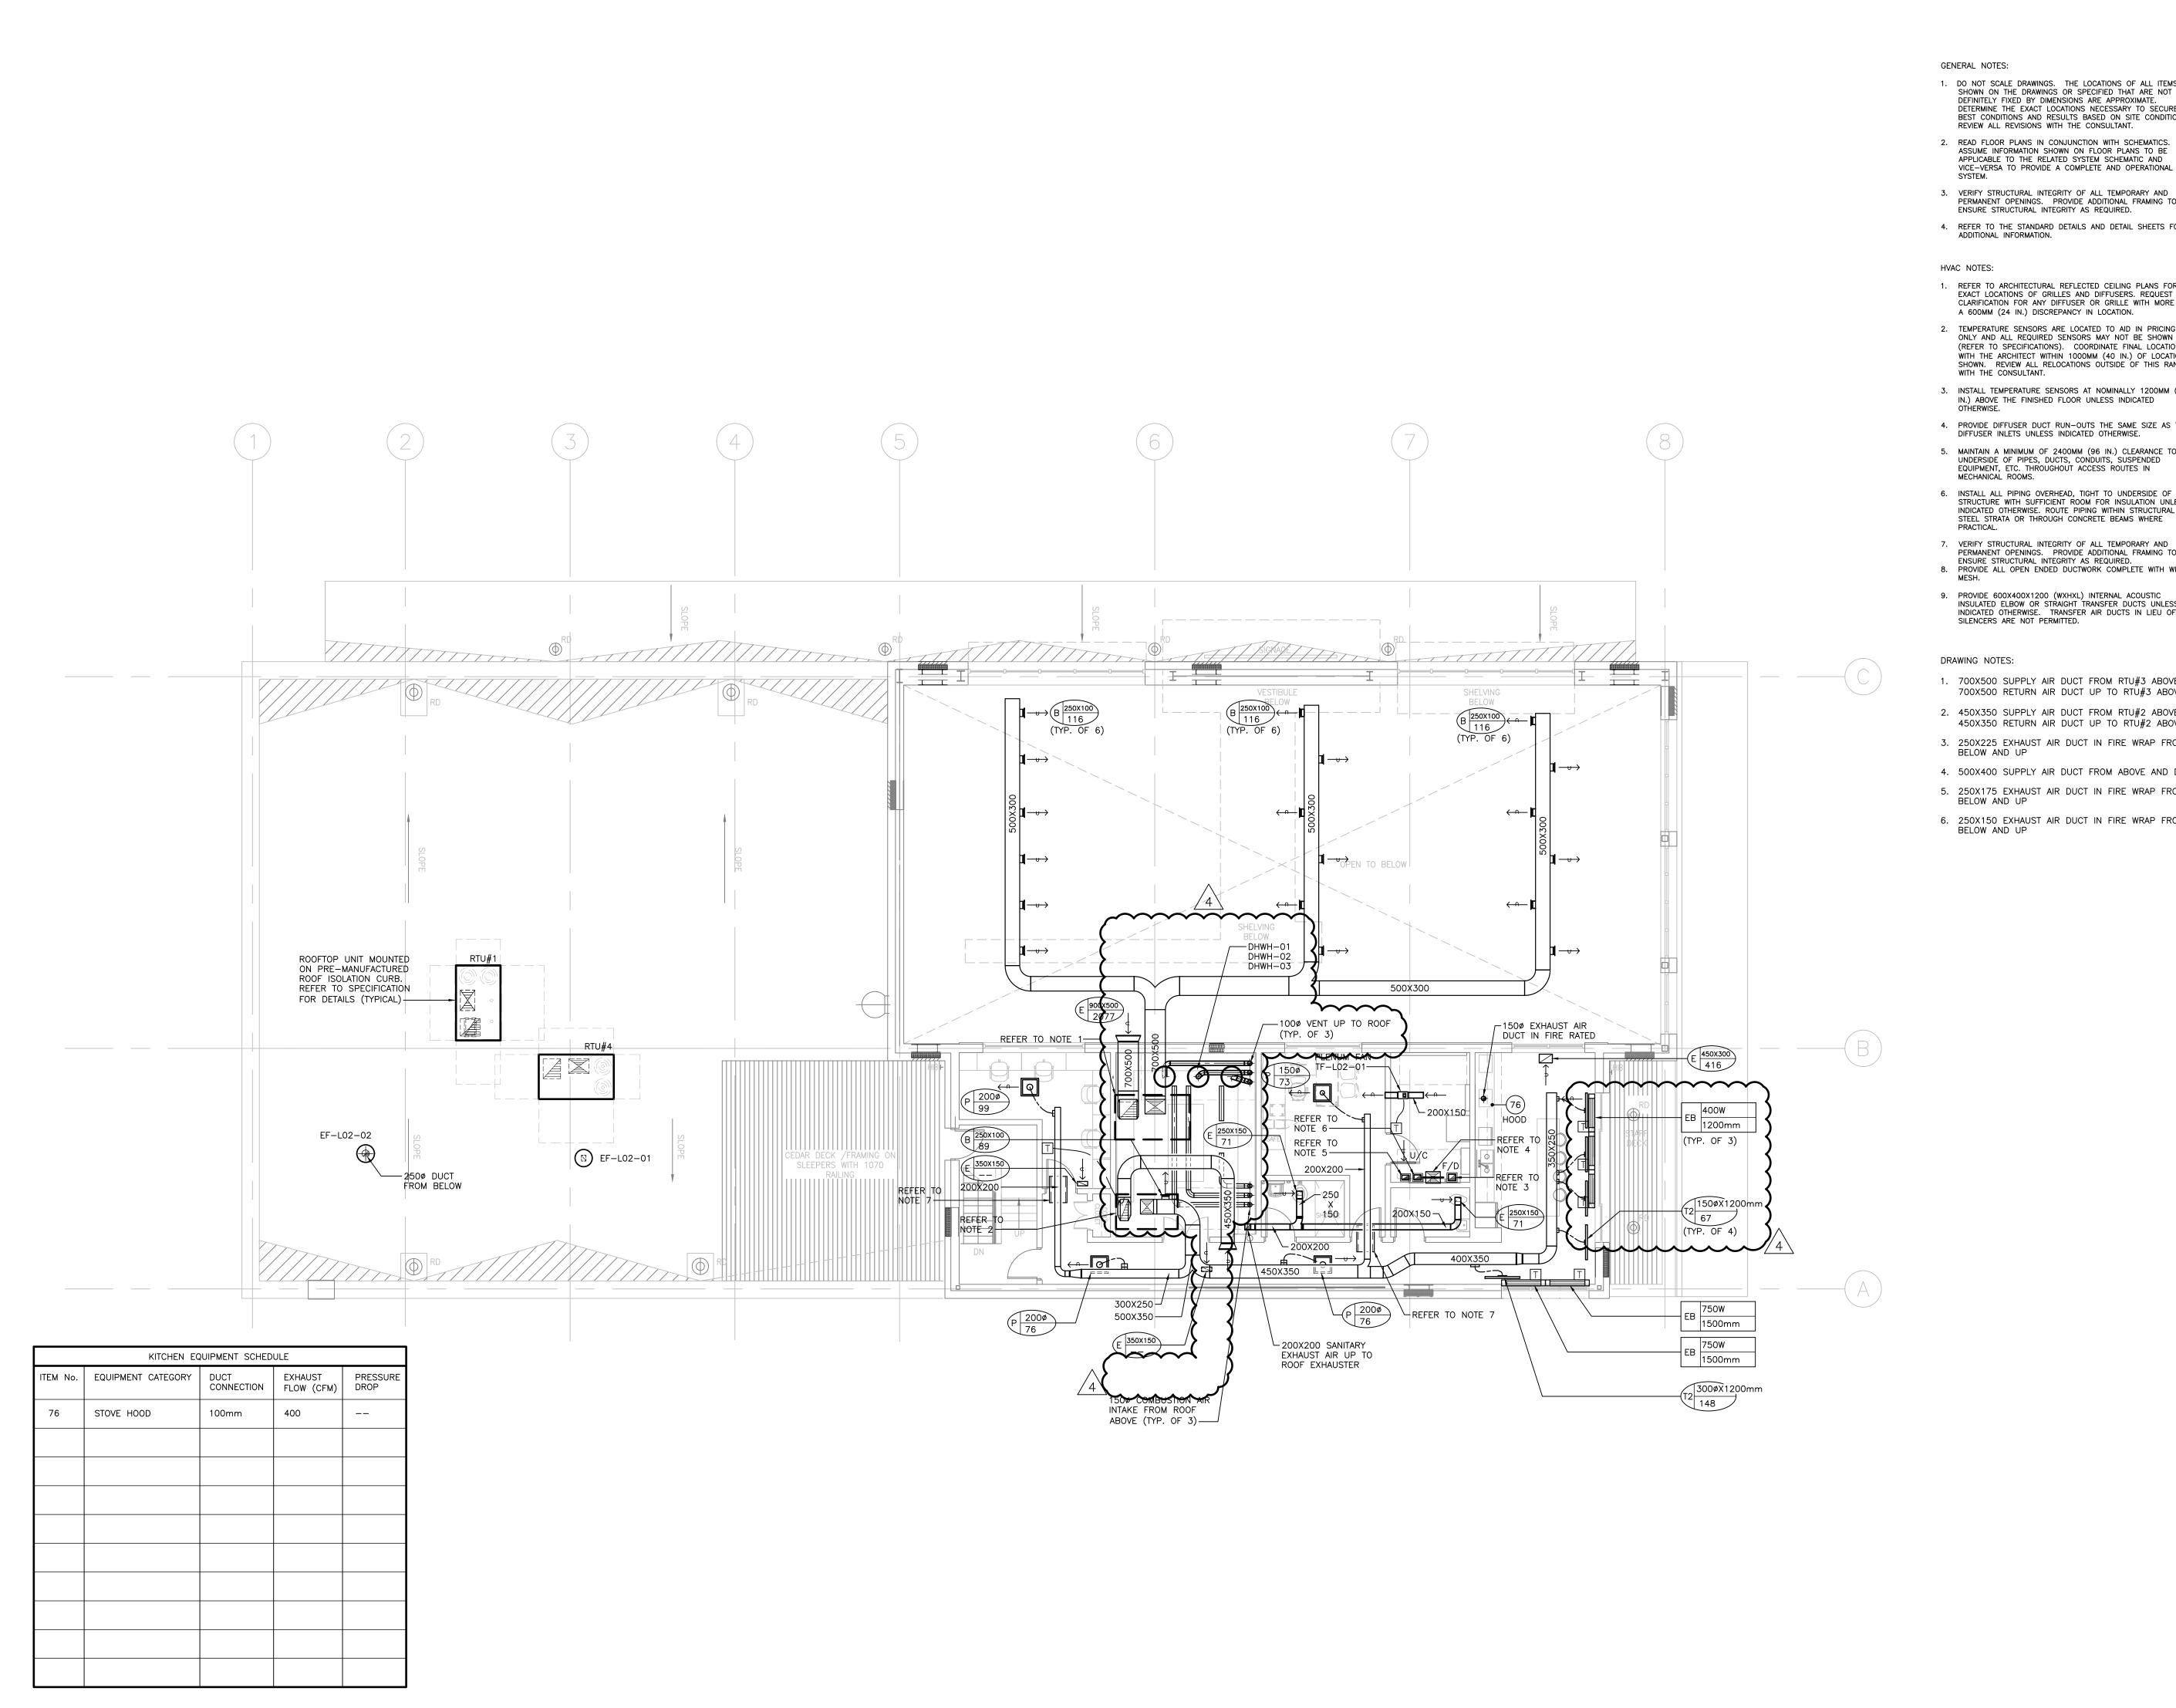

- DO NOT SCALE DRAWINGS. THE LOCATIONS OF ALL ITEMS SHOWN ON THE DRAWINGS OR SPECIFIED THAT ARE NOT DEFINITELY FIXED BY DIMENSIONS ARE APPROXIMATE.

  DETERMINE THE EXACT LOCATIONS NECESSARY TO SECURE THE BEST CONDITIONS AND RESULTS BASED ON SITE CONDITIONS. REVIEW ALL REVISIONS WITH THE CONSULTANT.
- 2. READ FLOOR PLANS IN CONJUNCTION WITH SCHEMATICS. ASSUME INFORMATION SHOWN ON FLOOR PLANS TO BE APPLICABLE TO THE RELATED SYSTEM SCHEMATIC AND
- VERIFY STRUCTURAL INTEGRITY OF ALL TEMPORARY AND PERMANENT OPENINGS. PROVIDE ADDITIONAL FRAMING TO ENSURE STRUCTURAL INTEGRITY AS REQUIRED.
- 4. REFER TO THE STANDARD DETAILS AND DETAIL SHEETS FOR ADDITIONAL INFORMATION.

- 1. REFER TO ARCHITECTURAL REFLECTED CEILING PLANS FOR EXACT LOCATIONS OF GRILLES AND DIFFUSERS. REQUEST CLARIFICATION FOR ANY DIFFUSER OR GRILLE WITH MORE THAN A 600MM (24 IN.) DISCREPANCY IN LOCATION.
- 2. TEMPERATURE SENSORS ARE LOCATED TO AID IN PRICING ONLY AND ALL REQUIRED SENSORS MAY NOT BE SHOWN (REFER TO SPECIFICATIONS). COORDINATE FINAL LOCATION WITH THE ARCHITECT WITHIN 1000MM (40 IN.) OF LOCATION SHOWN. REVIEW ALL RELOCATIONS OUTSIDE OF THIS RANGE WITH THE CONSULTANT.
- 3. INSTALL TEMPERATURE SENSORS AT NOMINALLY 1200MM (48 IN.) ABOVE THE FINISHED FLOOR UNLESS INDICATED OTHERWISE.
- 4. PROVIDE DIFFUSER DUCT RUN-OUTS THE SAME SIZE AS THE DIFFUSER INLETS UNLESS INDICATED OTHERWISE.
- 5. MAINTAIN A MINIMUM OF 2400MM (96 IN.) CLEARANCE TO THE UNDERSIDE OF PIPES, DUCTS, CONDUITS, SUSPENDED EQUIPMENT, ETC. THROUGHOUT ACCESS ROUTES IN MECHANICAL ROOMS.
- 6. INSTALL ALL PIPING OVERHEAD, TIGHT TO UNDERSIDE OF THE STRUCTURE WITH SUFFICIENT ROOM FOR INSULATION UNLESS INDICATED OTHERWISE. ROUTE PIPING WITHIN STRUCTURAL STEEL STRATA OR THROUGH CONCRETE BEAMS WHERE
- 7. VERIFY STRUCTURAL INTEGRITY OF ALL TEMPORARY AND PERMANENT OPENINGS. PROVIDE ADDITIONAL FRAMING TO
- ENSURE STRUCTURAL INTEGRITY AS REQUIRED. 8. PROVIDE ALL OPEN ENDED DUCTWORK COMPLETE WITH WIRE MESH.
- PROVIDE 600X400X1200 (WXHXL) INTERNAL ACOUSTIC INSULATED ELBOW OR STRAIGHT TRANSFER DUCTS UNLESS INDICATED OTHERWISE. TRANSFER AIR DUCTS IN LIEU OF SILENCERS ARE NOT PERMITTED.

- 1. 700X500 SUPPLY AIR DUCT FROM RTU#3 ABOVE. 700X500 RETURN AIR DUCT UP TO RTÜ#3 ABOVE.
- 2. 450X350 SUPPLY AIR DUCT FROM RTU#2 ABOVE. 450X350 RETURN AIR DUCT UP TO RTU#2 ABOVE.
- 3. 250X225 EXHAUST AIR DUCT IN FIRE WRAP FROM
- 4. 500X400 SUPPLY AIR DUCT FROM ABOVE AND DOWN
- 5. 250X175 EXHAUST AIR DUCT IN FIRE WRAP FROM
- 6. 250X150 EXHAUST AIR DUCT IN FIRE WRAP FROM BELOW AND UP

Contractor must check and verify all dimensions on the job, and report any discrepancies to the Architect before proceeding with the work. Do not scale this drawing.

REVISIONS AND ISSUES

REV	DESCRIPTION	DATE
1	ISSUED FOR TENDER	2021.08.25
2	ISSUED FOR PERMIT	2021.09.09
3	ISSUED FOR ADDENDUM #1	2021.09.15
4	ISSUED FOR ADDENDUM #2	2021.09.27
5		
6		

# **MJMA**

maclennan jaunkalns miller architects

toronto ontario m5v 3c1 416 593 6796 www.mjmarchitects.com

CIVIL ENGINEERS

## TRITON ENGINEERING SERVICES LTD

18 ROBB BOULEVARD - UNIT 8 ORANGEVILLE, ONTARIO

TEL 519 941 0330 FAX 519 941 1830

## BLACKWELL STRUCTURAL ENGINEERS

134 PETER STREET, SUITE 1301 TORONTO, ONTARIO, M5V 2H2 TEL 416.593.5300 FAX 416.593.4840

SMITH + ANDERSON MECHANICAL AND ELECTRICAL ENGINEERS

1100 - 100 SHEPPARD AVENUE EAST TORONTO, ONTARIO, M2N 6N5



TEL 416.487.8151 -

## Smith + Andersen

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# SAYERS FOOD LIMITED

132 BURLEIGH STREET t: 705.656.4531 e: sayers@apsley.ca

NORTH ARROW	SEAL

## PROJECT TITLE


NEW SAYERS FOOD STORE BURLEIGH STREET, APSLEY

SECOND FLOOR PLAN HVAC

SCALE

JUNE 16, 2021

PROJECT NUMBER

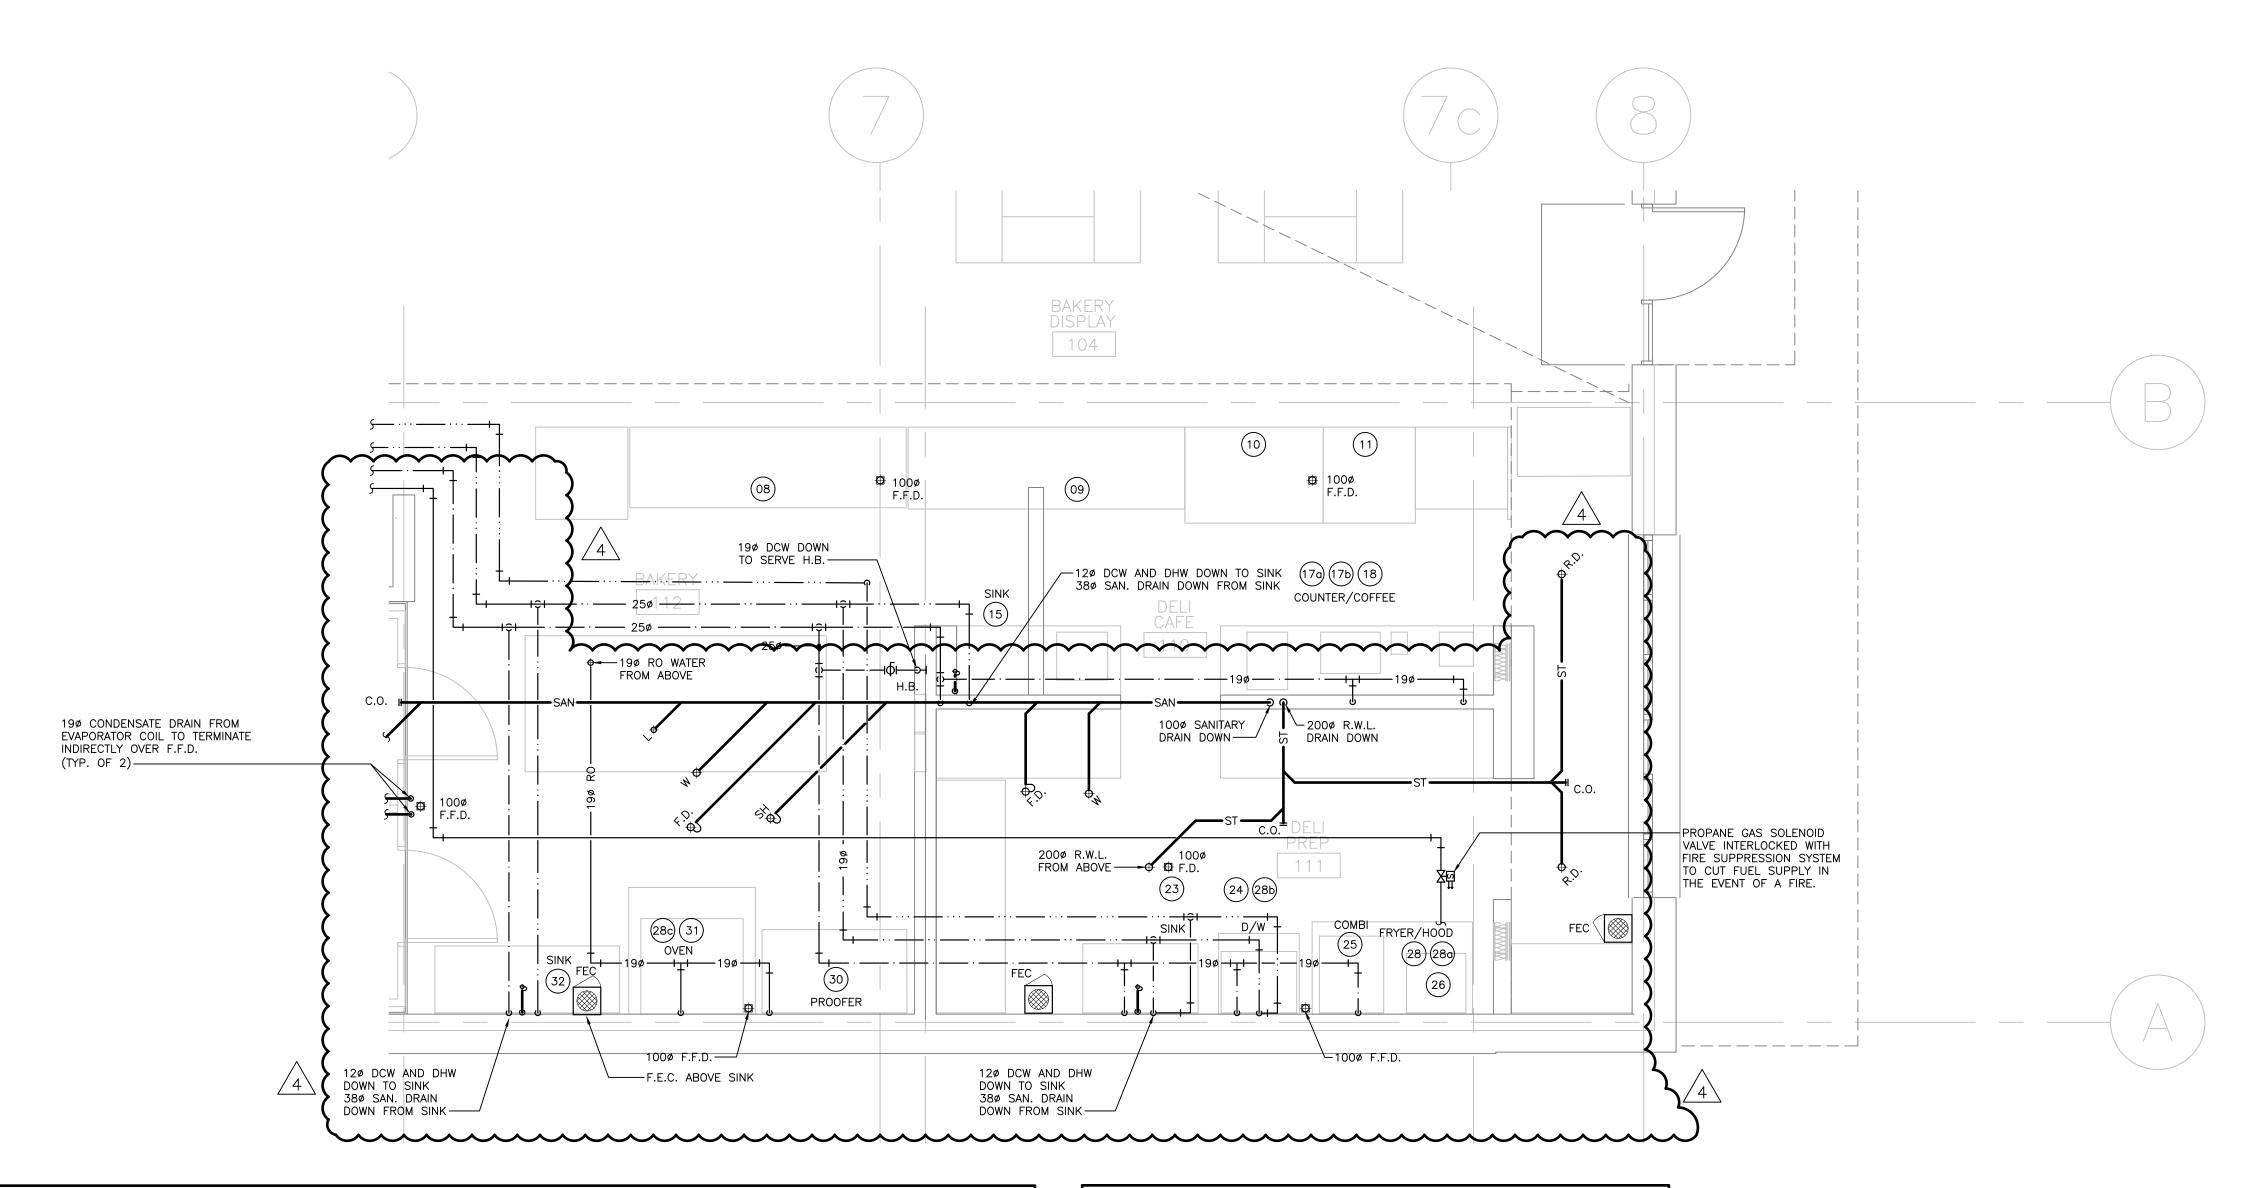

				KITCHEN EQUIPMENT	SCHEDULE				
ITEM No.	EQUIPMENT CATEGORY	COLD WATER SIZE (mm)	HOT WATER SIZE (mm)	FILTERED H2O	DIRECT DRAIN SIZE (mm)	INDIRECT DRAIN SIZE (mm)	INDIRECT DRAIN ROUGH-IN	GAS SIZE (mm)	MBTU/H
08	12' DELI SELF SERVE					38ø	FFD		
09	MEAT AND CHEESE					38ø	FFD		
10	SUB SERV					38ø(x2)	FFD		
11	HOT SRVC					38ø(x2)	FFD		
15	MEAT SLICER COUNTER/SINK	12ø	12ø		38ø				
17	ESPRESSO MACHINE	12ø			25ø				
18	COFFEE MAKER	6ø							
23	SINK	12ø	12ø		38ø				
24	DISHWAHER	19ø	19ø	19ø		16ø	FFD		
25	СОМВІ	19ø				50ø	FFD	19ø	
26	FRYER							19ø	140
30	PROOFER	12ø				19ø	FFD		
31	OVEN	6 NPT		YES					
32	COUNTER/SINK	12ø	12ø		38ø				

KITCHEN EQUIPMENT SCHEDULE						
ITEM No.	EQUIPMENT CATEGORY	DUCT CONNECTION	EXHAUST FLOW (CFM)	PRESSURE DROP		
28	EXHAUST HOOD	50mm	1,000			

- DO NOT SCALE DRAWINGS. THE LOCATIONS OF ALL ITEMS SHOWN ON THE DRAWINGS OR SPECIFIED THAT ARE NOT DEFINITELY FIXED BY DIMENSIONS ARE APPROXIMATE. DETERMINE THE EXACT LOCATIONS NECESSARY TO SECURE THE BEST CONDITIONS AND RESULTS BASED ON SITE CONDITIONS. REVIEW ALL REVISIONS WITH THE CONSULTANT.
- 2. READ FLOOR PLANS IN CONJUNCTION WITH SCHEMATICS. ASSUME INFORMATION SHOWN ON FLOOR PLANS TO BE APPLICABLE TO THE RELATED SYSTEM SCHEMATIC AND VICE—VERSA TO PROVIDE A COMPLETE AND OPERATIONAL
- VERIFY STRUCTURAL INTEGRITY OF ALL TEMPORARY AND PERMANENT OPENINGS. PROVIDE ADDITIONAL FRAMING TO ENSURE STRUCTURAL INTEGRITY AS REQUIRED.
- 4. REFER TO THE STANDARD DETAILS AND DETAIL SHEETS FOR ADDITIONAL INFORMATION.

## PLUMBING AND DRAINAGE NOTES:

- PROVIDE MINIMUM 75mm (3 IN.) FOR UNDER GROUND SANITARY DRAINAGE UNLESS INDICATED OTHERWISE.
   PROVIDE APPROVED BACK FLOW PREVENTION FOR ALL TRAP PRIMER SYSTEMS.
- PROVIDE MINIMUM 100mm (4 IN.) FOR UNDER GROUND STORM DRAINAGE UNLESS INDICATED OTHERWISE.
- PROVIDE MINIMUM 19mm (3/4 IN.) DOMESTIC COLD WATER AND DOMESTIC HOT WATER PIPES UNLESS INDICATED
- INSTALL ALL PIPING OVERHEAD, TIGHT TO UNDERSIDE OF THE STRUCTURE WITH SUFFICIENT ROOM FOR INSULATION UNLESS INDICATED OTHERWISE. ROUTE PIPING WITHIN STRUCTURAL STEEL STRATA OR THROUGH CONCRETE BEAMS WHERE PRACTICAL.
- 6. HEAT TRACE THE ENTIRE SERVICE TO BE PROTECTED FROM FREEZING IN ALL AREAS INDICATED ON THE DRAWINGS AND NOTED IN THE SPECIFICATIONS. PROVIDE HEAT TRACING TO ACCOMMODATE ALTERATIONS IN THE PIPE LAYOUT DUE TO INTERFERENCES OR OTHER INSTALLATION REQUIREMENTS.
  CONNECT HEAT TRACING CIRCUIT TO THE ELECTRICAL POWER LOCATIONS INDICATED ON THE DRAWINGS OR THE NEAREST CIRCUIT AVAILABLE. COORDINATE WITH ELECTRICAL DIVISION.

  7. PROVIDE SHUT—OFF VALVES ON ALL MAIN RISERS AND AT EACH
- CONNECTION TO EQUIPMENT.
- 8. PROVIDE COMPLETE VENTING SYSTEMS IN ACCORDANCE WITH THE PLUMBING OR BUILDING CODE.
- 9. HEAT TRACE ALL PIPING WITHIN UNHEATED SPACES SUCH AS PARKING LEVELS, SOFFITS AND WITHIN WALLS WHERE FREEZING MAY OCCUR.

Contractor must check and verify all dimensions on the job, and report any discrepancies to the Architect before proceeding with the work. Do not scale this drawing.

# REVISIONS AND ISSUES

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ORTH ARROW	SEAL

## PROJECT TITLE

NEW SAYERS FOOD STORE BURLEIGH STREET, APSLEY

## DRAWING TITLE

GROUND FLOOR PLAN KITCHEN PLUMBING AND

SCALE 1:50

JUNE 16, 2021

PROJECT NUMBER

21076