

Regional Municipality of Durham

Bid Opportunity: T-1032-2021 – Relocation of Oral Health Clinic to 200 John Street, Oshawa

Closing Date: Tuesday May 11, 2021 2:00 PM

Addendum number 2 - May 6, 2021

This addendum will form a part of the bid documents for the above-noted bid and shall be read in conjunction therewith. This addendum will take precedence over all requirements of the original bid documents and any addenda issued previously.

Bidders shall acknowledge receipt of this addendum with their electronic bid submission on the declaration page in the bidding system.

Specifications

Architectural

- .1 Section 01 21 13(R1) has been modified as part of this addendum.
 - .1 Revised paragraph 1.2.5.2 to increase the cash allowance for purchase, delivery, and installation of Security Systems and Services.

Drawings

Electrical

- .1 Drawing E-001 has been modified as part of this addendum.
 - .1 Duress system symbols and descriptions added to Legend.

- .2 Updated notes in boxed area.
- .3 Drawing E-002 has been modified as part of this addendum.
- .4 Updated detail number 3.
- .2 Drawing E-003 has been modified as part of this addendum.
 - .1 Updated detail number 3.
- .3 Drawing E-004 has been modified as part of this addendum.
 - .1 Updated detail number 1.
- .4 Drawing E-005 has been modified as part of this addendum.
 - .1 Updated detail number 3 and 4.
- .5 Drawing E-006 has been modified as part of this addendum.
 - .1 Updated details number 1, 2 and 3.
- .6 Drawing E-007 has been modified as part of this addendum.
 - .1 Updated details number 1, 2, 3 and 4.
- .7 Drawing E-008 has been modified as part of this addendum.
 - .1 Updated drawing note and drawing references.
 - .2 Added box note to drawing.
- .8 Drawing E-009 has been modified as part of this addendum.
 - .1 Revised electrical requirements for rooftop units.
- .9 Drawing E-010 has been modified as part of this addendum.
 - .1 Revised electrical requirements for mechanical equipment.
 - .2 Revised fire alarm system requirements.

- .3 Revised access control system, intrusion system requirements.
- .4 Updated drawings notes.
- .5 Miscellaneous updates to electrical design.
- .10 Drawing E-011 has been modified as part of this addendum.
 - .1 Revised fire alarm system device requirements.
 - .2 Revised life safety layout.
 - .3 Revised lighting control system requirements.
- .11 Drawing E-012 has been modified as part of this addendum.
 - .1 Updated detail numberf3.
- .12 Drawing E-015 has been modified as part of this addendum.
 - .1 Updated drawing note, boxed note and drawing references.
 - .2 Updated single line diagram
- .13 Drawing E-016 has been modified as part of this addendum.
 - .1 Updated CCTV system riser diagram, drawing note, boxed note and drawing references.
- .14 Drawing E-017 has been modified as part of this addendum.
 - .1 Updated access control system conduit riser diagram, drawing note, boxed note and drawing references.
 - .2 Updated detail number 1.
- .15 Drawing E-018 has been modified as part of this addendum.
 - .1 Updated access control system riser diagram, device schedule, drawing note, boxed note and drawing references.
- .16 Drawing E-019 has been modified as part of this addendum.

- .1 Updated intrusion system riser diagram, device schedule, drawing note, boxed note and drawing references.
- .17 Drawing E-020 has been modified as part of this addendum.
 - .1 Updated intercom system riser diagram, drawing note, boxed note and drawing references.
- .18 Drawing E-021 has been created as part of this addendum.
 - .1 Updated detail number 1.

Communications

- .1 Drawing T-001 has been modified as part of this addendum.
 - .1 Updated Detail No. 1 and legend.
- .2 Drawing T-002 has been modified as part of this addendum.
 - .1 Updated cabinet elevation detail.
- .3 Drawing T-003 has been modified as part of this addendum.
 - .1 Updated Detail number 1.
- .4 Drawing T-004 has been modified as part of this addendum.
 - .1 Updated Detail number 1 and 2.
- .5 Drawing T-005 has been modified as part of this addendum.
 - .1 Updated demolition requirements.

Attachments

.1 Drawing E-001 (Addendum #E-01)

- .2 Drawing E-002 (Addendum #E-01)
- .3 Drawing E-003 (Addendum #E-01)
- .4 Drawing E-004 (Addendum #E-01)
- .5 Drawing E-005 (Addendum #E-01)
- .6 Drawing E-007 (Addendum #E-01)
- .7 Drawing E-007 (Addendum #E-01)
- .8 Drawing E-008 (Addendum #E-01)
- .9 Drawing E-009 (Addendum #E-01)
- .10 Drawing E-010 (Addendum #E-01)
- .11 Drawing E-011 (Addendum #E-01)
- .12 Drawing E-012 (Addendum #E-01)
- .13 Drawing E-015 (Addendum #E-01)
- .14 Drawing E-016 (Addendum #E-01)
- .15 Drawing E-017 (Addendum #E-01)
- .16 Drawing E-018 (Addendum #E-01)
- .17 Drawing E-019 (Addendum #E-01)
- .18 Drawing E-020 (Addendum #E-01)
- .19 Drawing E-021 (Addendum #E-01)
- .20 Panel schedule for RP-A (Addendum #E-01)

- .21 Panel schedule for RP-B (Addendum #E-01)
- .22 Panel schedule for RP-C (Addendum #E-01)
- .23 Panel schedule for RP-D (Addendum #E-01)
- .24 Drawing T-001 (Addendum #T-01)
- .25 Drawing T-002 (Addendum #T-01)
- .26 Drawing T-003 (Addendum #T-01)
- .27 Drawing T-004 (Addendum #T-01)
- .28 Drawing T-005 (Addendum #T-01)
- .29 Specification Section(R1) 01 21 13 Cash Allowances

Questions and answers

Question 1:

Please confirm if we can use the existing washrooms during construction.

Answer 1:

Please refer to Section 01 50 00 Temporary Facilities and Controls.

Question 2:

Please Confirm if we can use the existing Power & Water during construction.

Answer 2:

Please refer to Section 01 50 00 Temporary Facilities and Controls.

Question 3:

With reference to Section 11 73 13 - Patient lifts, please provide the manufacturer/supplier contact details as it missing at the document.

Answer 3:

The patient lift is performance based specified. No manufacturer or supplier provided.

Question 4:

Please advise if any special material / need to be added to the partitions / ceiling related to the X-Ray location, if any?

Answer 4:

Two layers of 3/4" plywood for backing support as noted on A-005 Partition, Furring & General Notes No.3 and detail 4 on A3.1.

Question 5:

Please provide the BAS (Control) Contractor.

Answer 5:

Refer to Addendum No.1 – Answer 3.

Question 6:

Please confirm that all security / CCTV / Intercom and related works should be covered by the cash allowance.

Answer 6:

Security cash allowance is for supplying, installing and commissioning of access control system and intrusion system. Conduits, rough-ins and power required for

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access control system and intrusion system devices shall be included as part of the base bid price over and above the stated cash allowance value.

Question 7:

Please advise / provide details & exact scope of work –if any- that we should consider in our offer related to the relocation of the old location.

Answer 7:

Allow access and coordinate time for the relocation of other equipment and dental chairs with the successful bidder of the dental equipment tender T-1032-2021.

Question 8:

Please confirm if the medical piping and supply & installation of all equipment are by mechanical contractors? Or by others are not part of this tender.

Answer 8:

The supply and installation of dental equipment will be completed by the successful bidder of dental equipment tender T-1032-2021. The other contractor will only be connecting the equipment to the mechanical piping once the rooms are ready for occupancy. It is part of this tender to have a certified medical gas sub-contractor to install the medical piping. Please refer to General Notes of drawing A0. Please note that all in-floor vacuum, air lines, and dental gas line to be submitted with sealed engineered shop drawings and all work done in place to be reviewed by that engineering consultant.

Question 9:

Please provide specifications for the stainless steel coat hooks as noted on drawing 1/A007 finish floor plan notations. No information provided in specifications.

Answer 9:

Refer to Section 10 28 13.

Question 10:

Is there a finish schedule for the plastic laminate/solid surface materials? We see notations for PL1, PL5, PL6 etc. but do not see a schedule. Please confirm.

Answer 10:

Finish schedule and board to be put together by the architect once finishes are confirmed with the client.

Question 11:

What are the tile patterns for both walls?

Answer 11:

Refer to Drawing A-012 for tile patterns.

Question 12:

What is the trim type and locations?

Answer 12:

Refer to answers 13 to 16.

Question 13:

Can a specified trim for outside corners be provided?

Answer 13:

Refer to specification Section 09 30 00.

Question 14:

Are we installing cove trim at the inside corner where that floor & base tile meet? If so, is it surface or flush mounted?

Answer 14:

Refer to specification Section 09 30 00 – 3.3 Installation.

Question 15:

Is there a trim termination @ 6' in all three (3) WC's. If so, please specify.

Answer 15:

Yes. Refer to specification Section 09 30 00.

Question 16:

Is there a trim termination on all the base? If so, please specify.

Answer 16:

No trim required where the tile base meets tile wall. Only grout required.

Question 17:

Is there a millwork finish schedule or color/finish specs for millwork finishes?

Answer 17:

Refer to answer 10.

Question 18:

What is the extent of the existing stucco to be re-painted on the exterior/outside walls? See dwg #A-005 (note on the top) and dwg #A-009/detail #2 (hatched area to the right)?

Answer 18:

Existing stucco on the north of the building should be painted to cover up where the existing signage is to be removed (+/-140ft²). Contractor to site verify. Extents of stucco to be painted on the south of the building (3/A009) should be painted where old canopy is being removed (+/-40ft²). Contractor to site verify.

Question 19:

As per the drawings (drawing E-006), the notes state that the Access Control and Intrusion control panel will be provided by Owner. Can we get more information on what system the Owner will be providing?

Answer 19:

Access control system and intrusion system to be provided as part of this scope of work.

Question 20:

As per Specifications and Drawings, please confirm that the scope of work for Security and Access Control is just installation, programming, testing, commissioning and training. This is further implied in Drawing E-019 where Note N-10 states that intrusion system devices are supplied by client, and in Drawing E-018 Note N-15 which states that access control system

device to be supplied by client. Drawings also state the communications contractor is to supply and install equipment cabinets/racks, and the owner will also be supplying the main control panels, electric strike power supplies and system server. It sounds like the proponent won't be supplying any equipment.

Answer 20:

Access control system and intrusion system to be provided as part of this scope of work.

Question 21:

Drawing E-016 makes reference to the Specification for additional requirements for the CCTV system. The Specification provided does not have a section for CCTV. Please advise.

Answer 21:

Security Services Installation and Security System Standards was issued as part of Addendum 1.

Question 22:

Drawing E-016 states that a Senstar Thin Client 10D is to be provided as part of the CCTV workstation. Is this absolutely required? Most NVRs can be accessed through any computer on the same network through a web browser to display CCTV feed and make configurations.

Answer 22:

Thin Client 10D is required as per Drawing E-016.

Question 23:

Addendum 02

If additional equipment/materials are required beyond what is provided by the client, how will this be managed?

Answer 23:

Access control system and intrusion system to be provided as part of this scope of work.

Question 24:

Can you please let us know if mechanical pipes noted on drawing P1 in purple, green, and blue colours will be provided by the Owner or will be part of this tender?

Answer 24:

All work on P1 is to be included as part of this tender. Refer to Answer 8 above for further information.

Question 25:

Drawing T-001 – Detail 2 – Please clarify number of patch cords needed. Shall be supplied 445 patch cords as described in detail 2/T-001 or just the quantity of data cables?

Answer 25:

Provide quantity of patch cords per patch cord schedule.

Question 26:

Does a new BAS System need to be required for this facility?

Answer 26:

There is no BAS in the current building to be removed or maintained and no new BAS specified.

Question 27:

Will you post the virtual pre-bid meeting video for us to refer back to?

Answer 27:

A recording of the virtual pre-bid meeting will not be made available to bidders as this is verbal communication. Bidders should only rely on information provided in the Project Manual and addenda.

End of addendum

CEILING MOUNTED/SUSPENDED FIXTURE. CONNECT TO BASE BUILDING UTILITY LIGHTING CIRCUIT.

RECESSED/PENDENT DOWNLIGHT. CONNECT TO SWITCHED BASE BUILDING

CEILING MOUNTED/SUSPENDED FIXTURE. CONNECT TO NON SWITCHED BASE

UTILITY LIGHTING CIRCUIT.

RECESSED/PENDENT DOWNLIGHT. CONNECT TO NON SWITCHED BASE BUILDING 24-HOUR LIGHTING CIRCUIT.

CEILING OR WALL MOUNTED "EXIT" LIGHT.

BUILDING 24-HOUR LIGHTING CIRCUIT.

EMERGENCY BATTERY UNIT, TYPE 'D1', SOURCE 'M1'. BATTERY SHALL BE MOUNTED AT HIGH LEVEL.

REMOTE EMERGENCY LIGHTING FIXTURE, TYPE 'D2' FED FROM SOURCE 'M2'.

M2 N WHITE DECORA STYLE LIGHT SWITCH, VOLTAGE AND CURRENT RATINGS AS REQUIRED.

WALL MOUNTED ROOM LIGHT SWITCH WATT STOPPER LMSW-10X OR APPROVED EQUAL.

'OV1' DENOTES ONE (1) DIGITAL PUSH BUTTON. 'OV2' DENOTES TWO (2) DIGITAL PUSH BUTTONS. 'OV3' DENOTES THREE (3) DIGITAL PUSH BUTTONS.

'OV4' DENOTES FOUR (4) DIGITAL PUSH BUTTONS. WALL MOUNTED AREA LIGHT SWITCH WATT STOPPER LMSW-10X OR APPROVED EQUAL.

'OW2' DENOTES TWO (2) DIGITAL PUSH BUTTONS. 'OW3' DENOTES THREE (3) DIGITAL PUSH BUTTONS. 'OW4' DENOTES FOUR (4) DIGITAL PUSH BUTTONS. 'OW5' DENOTES FIVE (5) DIGITAL PUSH BUTTONS.

'OW6' DENOTES SIX (6) DIGITAL PUSH BUTTONS.

'TS' DENOTES WALL MOUNTED TIME SWITCH WATT STOPPER TS-400-24 OR APPROVED EQUAL C/W POWER PACK (VOLTAGE RATINGS TO SUIT LIGHTING LOADS) AND BOTH VISUAL AND AUDIBLE WARNING (TIMER PRESET AT 20 MINUTE TIME OUT SETTING).

'WS' DENOTES CRESTRON WALL STATION ROUGH-IN

15AMP/120VOLT, U-GROUND DUPLEX RECEPTACLE. GFI DENOTES OUTLET C/W GROUND FAULT INTERRUPT PROTECTION.

RECEPTACLE, REQUIREMENT AS NOTED

20A/120V DUPLEX RECEPTACLE, CSA 5-20R (T-SLOT). HUBBELL DR20 + 20/120 SERIES.

20A/120V PLUG LOAD CONTROLLED DUPLEX RECEPTACLE, CSA 5-20R +20/120 (T-SLOT). HUBBELL DR20C2WHI SERIES.

20A/120V HOSPITAL GRADE DUPLEX RECEPTACLE, CSA 5-20R (T-SLOT). HUBBELL 2182 SERIES. GFI DENOTES OUTLET C/W GROUND FAULT INTERRUPT PROTECTION. HUBBELL GFRST83XX SERIES.

DIRECT CONNECTION.

NON-FUSED HORSEPOWER RATED VISIBLE BLADE HEAVY DUTY DISCONNECT SWITCH C/W PADLOCK PROVISION IN OFF POSITION

VISIBLE BLADE HEAVY DUTY DISCONNECT SWITCH C/W PADLOCK PROVISION IN OFF POSITION FUSED AT '15A' 30/15A/3P

COMBINATION STARTER C/W FUSES, OVERLOAD PROTECTION, CONTROL TRANSFORMER, 2 NO AND 2 NC CONTACTS, PILOT LIGHT AND HOA. FUSED 30/15A/3P

CIRCUIT 'X' FED FROM RECEPTACLE PANEL 'A'. '(D)' DENOTES DESIGNATED RP-A-X(D)CIRCUIT FOR ISOLATED GROUND DUPLEX RECEPTÀCLE.

DENOTES EXISTING DEVICE TO REMAIN

DENOTES EXISTING DEVICE TO BE REMOVED. REMOVE CONDUIT AND WIRE BACK TO SOURCE.

DENOTES ROOF MOUNTED

DENOTES CLOCK STYLE RECEPTACLE

DENOTES CEILING MOUNTED

DENOTES NEMA TYPE 4X ENCLOSURE SUITABLE FOR HOSE DIRECTED WATER

DENOTES DEVICE COMPLETE WITH PROTECTIVE WIRE GUARD

DENOTES MOUNTING HEIGHT TO BE IN LINE WITH LIGHT SWITCHES.

DENOTES SURFACE MOUNTED

DENOTES MOUNTED IN MILLWORK

4" SQUARE BACKBOX C/W SINGLE DEVICE COVER (PLASTER RING) AND 3/4" EMPTY ZONE CONDUIT ASSEMBLY FOR COMMUNICATIONS CONTRACTOR'S USE. PROVIDE A PULL STRING IN CONDUIT.

DE 2-GANG DEEP BACKBOX C/W COVER PLATE AND 3/4" EMPTY ZONE CONDUIT ASSEMBLY TO COMPRESSOR ROOM/O&N CLOSET C/W PULLSTRING FOR DENTAL EQUIPMENT CONTRACTOR'S USE.

4" SQUARE DEEP BACKBOX C/W COVER PLATE AND 1 1/2" ZONE CONDUIT SYSTEM C/W PULLSTRING FOR A/V CONTRACTOR'S USE.

4" SQUARE DEEP BACKBOX C/W COVER PLATE AND 1 1/2" ZONE CONDUIT SYSTEM C/W PULLSTRING FOR A/V CONTRACTOR'S USE.

WALL MOUNTED OFFICE GROUP CONSISTING OF ONE (1) DUPLEX RECEPTACLE, ONE (1) PLUG LOAD CONTROLLED DUPLEX RECEPTACLE AND 4" SQUARE BACKBOX C/W SINGLE DEVICE COVER (PLASTER RING) WITH 3/4" ZONE CONDUIT C/W PULL STRING FOR COMMUNICATIONS CONTRACTOR'S USE.

WALL MOUNTED OFFICE GROUP CONSISTING OF TWO (2) DUPLEX RECEPTACLES AND 4" SQUARE BACKBOX C/W SINGLE DEVICE COVER (PLASTER RING) WITH 3/4" ZONE CONDUIT C/W PULL STRING FOR COMMUNICATIONS CONTRACTOR'S USE.

WALL MOUNTED OFFICE GROUP CONSISTING OF ONE (1) HOSPITAL GRADE DUPLEX RECEPTACLE AND 4" SQUARE BACKBOX C/W SINGLE DEVICE COVER (PLASTER RING) WITH 3/4" ZONE CONDUIT C/W PULL STRING FOR COMMUNICATIONS CONTRACTOR'S USE.

FLOOR MOUNTED OFFICE GROUP CONSISTING OF ONE (1) DUPLEX RECEPTACLE, ONE (1) PLUG LOAD CONTROLLED DUPLEX RECEPTACLE AND CUTOUTS FOR COMMUNICATIONS CONTRACTOR'S USE. 'F' DENOTES RECESSED MOUNTED.

RECESSED MOUNTED OFFICE GROUP CONSISTING OF CUTOUTS FOR A/V CONTRACTOR'S USE.

DENOTES LOCATION OF COLUMN/WALL MOUNTED CABLE ENTRY FOR SYSTEMS FURNITURE. PROVIDE ELECTRICAL REQUIREMENTS AND COMMUNICATIONS ROUGH-IN REQUIREMENTS.

DENOTES LOCATION OF FLOOR MOUNTED CABLE ENTRY FOR SYSTEMS FURNITURE. PROVIDE ELECTRICAL REQUIREMENTS AND COMMUNICATIONS ROUGH-IN REQUIREMENTS.

DENOTES LOCATION OF FLOOR MOUNTED CABLE ENTRY. PROVIDE ELECTRICAL REQUIREMENTS AND COMMUNICATIONS ROUGH—IN REQUIREMENTS. 'CHAIR' DENOTES CONDUIT STUBBED UP INTO DENTAL CHAIR BASE.

SMOKE DETECTOR. CONNECT TO BASE BUILDING FIRE ALARM SYSTEM.

HEAT DETECTOR. CONNECT TO BASE BUILDING FIRE ALARM SYSTEM.

MANUAL PULL STATION. CONNECT TO BASE BUILDING FIRE ALARM SYSTEM

6" FIRE ALARM SYSTEM BELL. CONNECT TO BASE BUILDING FIRE ALARM SYSTEM. 'G' DENOTES RECESS (WALL/CEILING) MOUNTED BACKBOX C/W FIELD PAINTABLE GRILL.

FIRE ALARM SYSTEM STROBE LIGHT. CONNECT TO BASE BUILDING FIRE ALARM SYSTEM. WHITE IN COLOUR.

ISOLATION MODULE. CONNECT TO BASE BUILDING FIRE ALARM SYSTEM.

EOL END OF LINE RESISTOR. CONNECT TO BASE BUILDING FIRE ALARM SYSTEM. INITIATING DEVICE INTERFACE ZONE MODULE. CONNECT TO BASE BUILDING FIRE ALARM SYSTEM.

CONTROL ZONE MODULE. CONNECT TO BASE BUILDING FIRE ALARM SYSTEM.

CARD READER. CONNECT TO ACCESS CONTROL SYSTEM.

ELECTRIC STRIKE. CONNECT TO ACCESS CONTROL SYSTEM.

AUDIBLE ALARM. CONNECT TO ACCESS CONTROL SYSTEM. DOOR RELEASE. CONNECT TO ACCESS CONTROL SYSTEM.

MOTION DETECTOR REQUEST TO EXIT. CONNECT TO ACCESS CONTROL

UNIVERSAL WASHROOM DURESS SYSTEM CIRCUIT ACCESS CONTROL SYSTEM INTERFACE C/W CONDUIT AND WIRE.

BARRIER FREE WAVE SENSOR ROUGH-IN C/W CONDUIT AND WIRE.

DOOR OPERATOR INTERFACE DEVICE. CONNECT TO ACCESS CONTROL

ROOM CEILING MOUNTED OCCUPANCY SENSOR WATT STOPPER LMDC-100 OR APPROVED EQUAL. SENSOR PRESET AT 20 MINUTE TIME OUT SETTING C/W

MANUAL ON AND AUTO OFF AND DEFAULT DETECTION TECHNOLOGY SETTING

OPEN OFFICE AREA CEILING MOUNTED OCCUPANCY SENSOR WATT STOPPER LMDC-100 OR APPROVED EQUAL. SENSOR PRESET AT 20 MINUTE TIME OUT SETTING C/W MANUAL ON AND AUTO OFF AND DEFAULT DETECTION

TECHNOLOGY SETTING. NON-SWITCHED CORRIDOR CEILING MOUNTED OCCUPANCY SENSOR WATT STOPPER LMDC-100 OR APPROVED EQUAL. SENSOR PRESET AT 20 MINUTE TIME OUT SETTING C/W AUTO ON AND AUTO OFF WALK THROUGH MODE ON

EQUIPMENT ROOM MOUNTED OCCUPANCY SENSOR WATT STOPPER LMPC-100 OR APPROVED EQUAL. SENSOR PRESET AT 20 MINUTE TIME OUT SETTING C/W AUTO ON AND AUTO OFF AND DEFAULT DETECTION TECHNOLOGY SETTING.

AND DEFAULT SETTING.

DIGITAL ON/OFF/DIMMING ROOM CONTROLLER WATT STOPPER LMRC-212/LMRC-212-347 OR APPROVED EQUAL (VOLTAGE RATING AS REQUIRED TO SUIT LIGHTING LOAD).

DIGITAL DIMMING ROOM CONTROLLER WATT STOPPER 120V LINE VOLTAGE LMRC-222 OR APPROVED EQUAL.

DIGITAL PLUG LOAD CONTROLLER WATT STOPPER LMPL-101 OR APPROVED EQUAL.

CEILING MOUNTED PHOTOSENSOR WATT STOPPER LMLS-400 OR APPROVED EQUAL. SENSOR PRESET 35FC. 'P' DENOTES PRIMARY SIDE LIGHTED AREA.

'S' DENOTES SECONDARY SIDE LIGHTED AREA. HARDWIRED INTRUSION SYSTEM DOOR CONTACT. CONNECT TO INTRUSION

SYSTEM HARDWIRED INTRUSION SYSTEM KEYPAD. CONNECT TO INTRUSION SYSTEM.

INTRUSION SYSTEM HARDWIRED GLASS BREAK DETECTOR. CONNECT TO INTRUSION SYSTEM.

HARDWIRED INTRUSION SYSTEM MOTION SENSOR. CONNECT TO INTRUSION

DURESS SYSTEM PANIC BUTTON. CONNECT TO INTRUSION SYSTEM

DURESS SYSTEM STROBE LIGHT. CONNECT TO INTRUSION SYSTEM PB

UNIVERSAL WASHROOM DURESS SYSTEM COMBINATION STROBE LIGHT/HORN

UNIVERSAL WASHROOM DURESS SYSTEM STATION

VANDAL RESISTANT CCTV DOME CAMERA C/W MOUNTING BRACKETS, 'CX' DENOTES CAMERA DESIGNATION.

THERMOSTAT SUPPLIED BY MECHANICAL CONTRACTOR AND INSTALLED BY LECTRICAL CONTRACTOR PROVIDE CONDUIT AND WIRE.

INTERCOM SYSTEM MASTER STATION

INTERCOM SYSTEM DOOR STATION. 'V' DENOTES VIDEO DOOR STATION, 'A' DENOTES AUDIO DOOR STATION.

SUBSTITUTES ARE NOT PERMITTED FOR ALL SPECIFIED PRODUCTS.

SHOP DRAWINGS ARE REQUIRED FOR ALL PRODUCTS SPECIFIED FOR THIS PROJECT INCLUDING BUT NOT LIMITED TO LIGHTING CONTROL, ELECTRICAL DISTRIBUTION, RECEPTACLE PANELS, CABLE TRAYS, LIGHTING FIXTURES, EXIT SIGNS, SWITCHES, RECEPTACLES, COVER PLATES, DIMMERS, FLOOR BOXES, CCTV SYSTEM, INTERCOM SYSTEM, ACCESS CONTROL SYSTEM, INTRUSION SYSTEM, FIRE ALARM SYSTEM DEVICES AND GROUNDING SYSTEM MATERIALS.

ELECTRICAL CONTRACTOR AND ALL SUBCONTRACTORS MUST READ AND COMPLY WITH ELECTRICAL SPECIFICATIONS (ISSUED AS A SEPARATE DOCUMENT).

CIRCUITING MUST BE COMPLETED AS SHOWN ON DRAWINGS. DO NOT CHANGE

INSTALLATION AND MANUFACTURING OF ALL DEVICES AND SERVICES INCLUDING DISTRIBUTION, LIGHT FIXTURES, FEEDERS, BRANCH CIRCUITS, VARIOUS SYSTEMS, ETC. MUST COMPLY WITH ALL LOCAL SEISMIC RESTRAINT REQUIREMENTS.

THESE DRAWINGS SHALL BE READ IN CONJUNCTION WITH THE ARCHITECTURAL DRAWINGS FOR DIMENSIONS, MOUNTING HEIGHTS, CONSTRUCTION DETAILS, LOCATION OF LIGHT FIXTURES, FINISHES AND COLOURS.

AS PART OF THIS SCOPE OF WORK AND PRIOR TO CONSTRUCTION, ELECTRICAL CONTRACTOR SHALL COORDINATE AND PAY FOR THE SERVICES OF THE FIRE ALARM MANUFACTURER, FIRE INSPECTOR AND BUILDING INSPECTOR TO THOROUGHLY REVIEW THE PROPOSED INSTALLATION LOCATIONS FOR EACH AND EVERY CONTROL PANEL, REMOTE ANNUNCIATOR PANEL, ANCILLARY DEVICE, FIELD DEVICE, ETC TO ENSURE THAT THE PROPOSED INSTALLATION IS FULLY COMPLIANT WITH CAN/ULC S524-14-AMD1 AND ONTARIO BUILDING CODE. COMPLIANCE SHALL INCLUDE INTERFERENCE AND PROXIMITY TO NEW AND EXISTING DEVICES AND OBSTRUCTIONS (INCLUDING BUT NOT LIMITED TO LIGHT FIXTURES, SUPPLY AIR DUCTS, EXPOSED DUCT WORK, BEAMS, RACEWAYS, ETC) SPACING BETWEEN FIELD DEVICES PROVIDED AS PART OF THIS SCOPE OF WORK IN PROPOSED INSTALLATION LOCATIONS, ETC.

AS PART OF THIS SCOPE OF WORK AND PRIOR TO CONSTRUCTION. ELECTRICAL CONTRACTOR SHALL COORDINATE AND PAY FOR THE SERVICES OF THE BUILDING INSPECTOR TO REVIEW THE PROPOSED EXIT SIGN ORIENTATIONS, LOCATIONS, FACES (READ OR PICTOGRAM) AND CHEVRONS.

AS PART OF THE BASE BID PRICE ELECTRICAL CONTRACTOR SHALL PROVIDE A FIRE WATCH THROUGHOUT THE DURATION OF THE PROJECT.

10. FIRE ALARM SYSTEM TESTING AND VERIFICATIONS MUST TAKE PLACE BETWEEN 11PM AND 5AM DURING THE WEEK.

11. AS BUILT DRAWING REQUIREMENTS:

AS BUILT DRAWINGS TO BE PREPARED AND SUBMITTED IN AUTOCAD FORMAT BY THE ELECTRICAL CONTRACTOR. ALL DEMOLITION SCOPES OF WORK ARE TO BE ERASED FROM AS BUILT

ROUTING OF ALL FEEDERS, BRANCH WIRING (LIGHTING, EMERGENCY LIGHTING, POWER, ETC), LOW VOLTAGE WIRING, MISCELLANEOUS SYSTEMS WIRING, MISCELLANEOUS CONDUIT SYSTEMS, ETC, TO BE SHOWN ON AS BUILT

REFER TO DRAWINGS AND SPECIFICATIONS FOR ADDITIONAL REQUIREMENTS.

12. ALL SCOPES OF WORK REQUIRED TO BE COMPLETED IN OCCUPIED AREAS OF THE FACILITY INCLUDING WORK RELATED TO DEFICIENCIES MUST BE COMPLETED BETWEEN 11PM AND 5AM DURING THE WEEK, REMOVAL AND REINSTALLATION OF CEILING TILES TO ACCOMMODATE ALL SCOPES OF WORK SHALL BE PROVIDED BY THE ELECTRICAL CONTRACTOR.

PROVIDE A DEDICATED GREEN INSULATED COPPER GROUND WIRE FOR EACH RECEPTACLE, DEVICE, LIGHT SWITCH, ETC. IN PATIENT CARE AREAS, OPERATORY


ROOMS, LABS, ETC. AS PART OF THIS SCOPE OF WORK SET UP ACCESS CONTROL SYSTEM KEY CARDS PROVIDED AS PART OF THIS SCOPE OF WORK, INCLUDING TAKING EMPLOYEE PHOTOS AND SETTING UP AND PROGRAMING NEW DATABASE PROVIDED AS PART OF THIS SCOPE OF WORK. ELECTRICAL CONTRACTOR SHALL COORDINATE, ORGANIZE AND SCHEDULE TIME TO TAKE PHOTOS OF ALL STAFF AT THE SITE. PROVIDE A BLUE CURTAIN BACKDROP. ALL REQUIRED LIGHTING AND ALL OTHER EQUIPMENT REQUIRED FOR PHOTO TAKING. REFER TO DRAWING NO. E-018 FOR ADDITIONAL REQUIREMENTS.

15. ALL PANEL SCHEDULE DIRECTORIES MUST BE UPDATED WITH TYPEWRITTEN PANEL SCHEDULES. KROY TAPE MUST BE USED FOR ALL LABELING AT ALL OUTLETS AND LAMACOIDS FOR ENCLOSURES.

THE CONTRACTOR MUST ENSURE THAT FIRESTOPPING AND SEALANTS ARE INSTALLED AT NEW FLOOR OPENINGS IN ACCORDANCE WITH THE CURRENT FIRE CODE REQUIREMENTS AND TO PREVENT WATER LEAKAGE TO THE FLOORS BELOW. AREAS PRONE TO WATER LEAKAGE ARE TO BE WATERPROOFED PRIOR TO INSTALLATION OF THE TENANT FLOOR COVERINGS. THE LANDLORD WILL APPROVE THE PROPOSED WATERPROOFING METHOD PRIOR TO THE TENANT

PROCEEDING WITH CONSTRUCTION. ALL DENTAL EQUIPMENT SHALL BE INSTALLED AT THE END OF CONSTRUCTION AFTER SITE CLEAN UP AND DEMOBILIZATION. AS PART OF THIS SCOPE OF WORK ELECTRICAL CONTRACTOR SHALL ALLOW FOR REMOBILIZATION AND TO COORDINATE AND SCHEDULE TIME TO COMPLETE FINAL ELECTRICAL CONNECTIONS TO DENTAL EQUIPMENT, BUCK & BOOST TRANSFORMERS, ETC., WITH PROJECT MANAGER.

ALL MEASUREMENTS ARE TO BE VERIFIED BY THE CONTRACTOR ON SITE AND ANY DISCREPANCIES ARE TO BE REPORTED BEFORE PROCEEDING WITH THE WORK. THE REGION OF DURHAM ASSUMES NO RESPONSIBILITY FOR THE ACCURACY OF THE LOCATION OF EXISTING SERVICES AS INDICATED ON THIS DRAWING. DO NOT SCALE DRAWINGS.

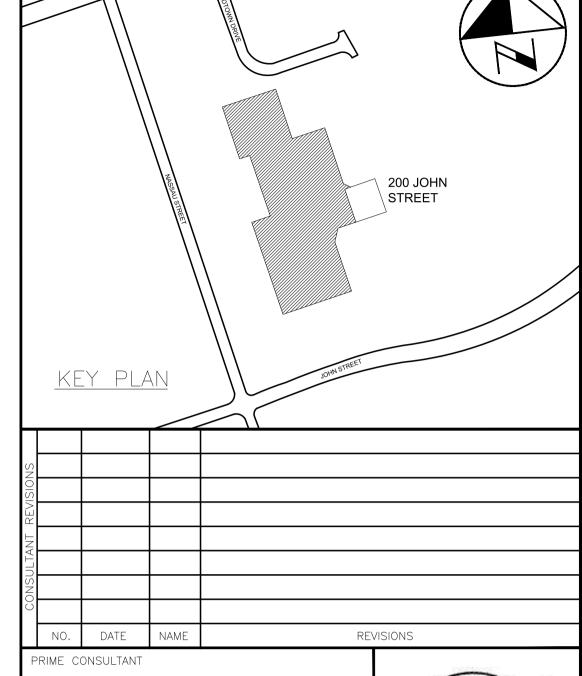

ASSOCIATES Project Managers L1N 0G5 Tel: (905) 666-5252 Fax: (905) 666-5256



SUB-CONSULTANT

HCC Project No.: 20104

HCC ENGINEERING DESIGN AND TECHNOLOGY SERVICES GROUP

HCC ENGINEERING LIMITED 40 EGLINTON AVENUE EAST, SUITE 600 TORONTO, ONTARIO, M4P 3A2 Tel: (416) 932-2423



DESIGN BY: PC SCALE AS SHOWN DRAWN BY: TLR DATE: **2020-05-01** CONSULTANT PROJECT NO. 20060 CHECKED BY: PC/HDC APPROVED BY: HDC 4 MAY02/2021 HCC | ISSUED FOR ADDENDUM #E-01 3 | FEB09/2021 | HCC | ISSUED FOR PERMIT & TENDER 2 OCT30/2020 HCC ISSUED FOR 90% REVIEW MAY15/2020 HCC | ISSUED FOR 60% REVIEW



DATE

THE REGIONAL MUNICIPALITY OF DURHAM

REVISIONS


WORKS DEPARTMENT

DESIGN, CONSTRUCTION & ASSET MANAGEMENT RELOCATION OF DENTAL CLINIC

ELECTRICAL LEGEND AND DETAILS

TO 200 JOHN ST., OSHAWA

property no. N/A	facility code LEA-0-07	facilities project no. LEA-0-07-19-01
CONTRACT NO.	DRAWING NO.	SHEET NO.
T-1032-2021	E-001	034

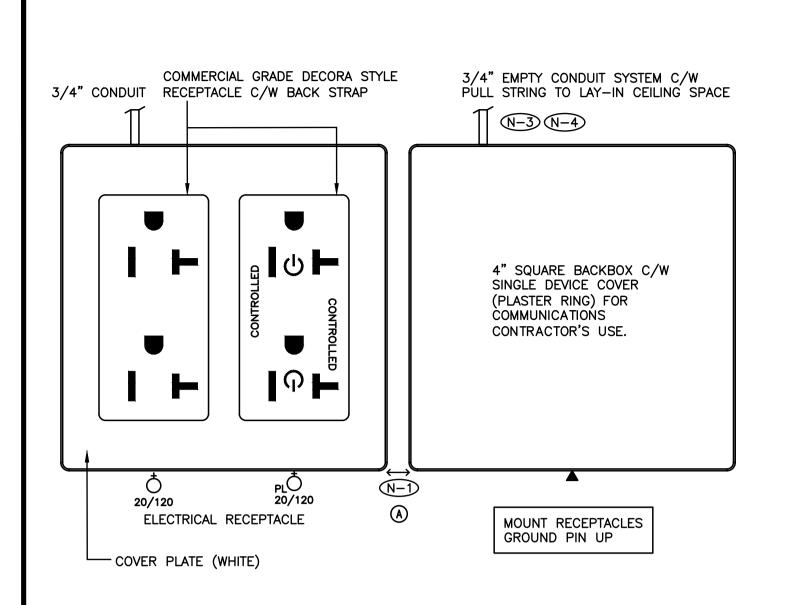

- N-1 MINIMUM CLEARANCE.
- N-2 NEATLY LABEL ALL FLOOR MOUNTED AND WALL DEVICE BOX COVERS WITH CORRESPONDING PANEL NAMES AND CIRCUIT NUMBERS, UTILIZE SELF ADHESIVE MECHANICALLY PRINTED LABELS.
- N-3 PROVIDE PUNCH OUTS IN BACKBOX TO ACCOMMODATE
- CONDUITS INDICATED.

1" CONDUIT

OR SMALLER


1 1/4" CONDUIT

3" EXPANSION

OR LARGER

N-4) TERMINATE CONDUIT WITH A 90 DEGREE BEND AND PLASTIC BUSHING IN THE ACCESSIBLE CEILING SPACE.

UTILITY CCT - WHITE RECEPTACLE

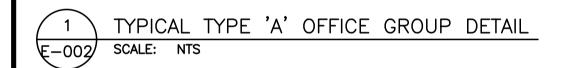


EXPANSION JOINT

FLEX CONDUIT

EMT

JUNCTION BOX SUPPORTED


ON ONE SIDE ONLY

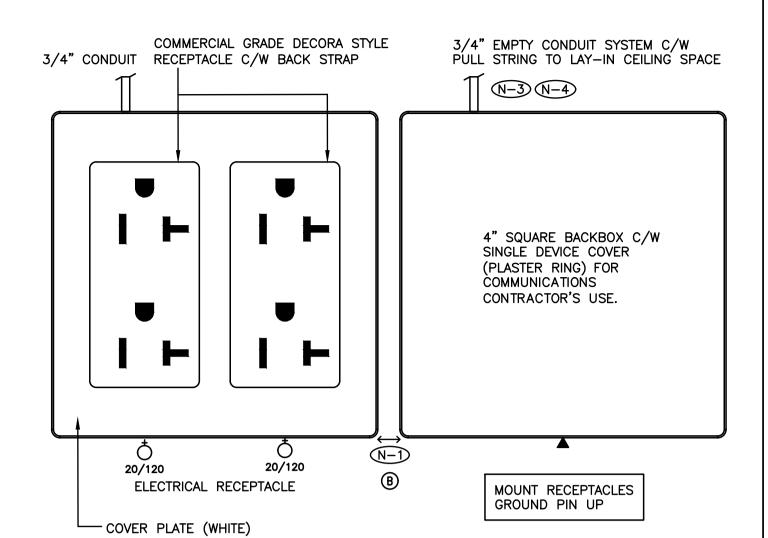

- N-1) MINIMUM CLEARANCE.
- N-2 NEATLY LABEL ALL FLOOR MOUNTED AND WALL DEVICE BOX COVERS WITH CORRESPONDING PANEL NAMES AND CIRCUIT NUMBERS, UTILIZE SELF ADHESIVE MECHANICALLY PRINTED LABELS.
- N-3 PROVIDE PUNCH OUTS IN BACKBOX TO ACCOMMODATE CONDUITS INDICATED.
- N-4 TERMINATE CONDUIT WITH A 90 DEGREE BEND AND PLASTIC BUSHING IN THE ACCESSIBLE CEILING SPACE.


UTILITY CCT - WHITE RECEPTACLE

TYPICAL TYPE 'B' OFFICE GROUP DETAIL SCALE: NTS

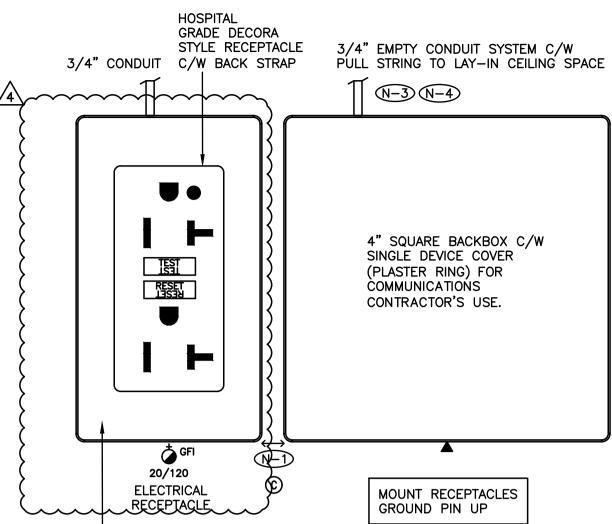

- N-1 MINIMUM CLEARANCE.
- N-2 NEATLY LABEL ALL FLOOR MOUNTED AND WALL DEVICE BOX COVERS WITH CORRESPONDING PANEL NAMES AND CIRCUIT NUMBERS, UTILIZE SELF ADHESIVE MECHANICALLY PRINTED LABELS.
- N-3 PROVIDE PUNCH OUTS IN BACKBOX TO ACCOMMODATE CONDUITS INDICATED.
- N-4) TERMINATE CONDUIT WITH A 90 DEGREE BEND AND PLASTIC BUSHING IN THE ACCESSIBLE CEILING SPACE.


UTILITY CCT - WHITE RECEPTACLE

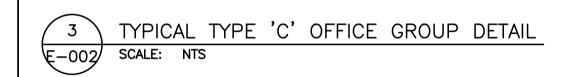

④|

1

(5) (N-3)

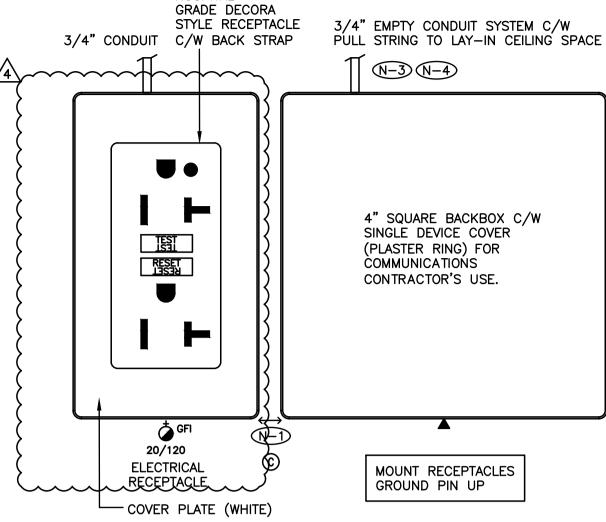

BARRY BRYAN ASSOCIATES Project Managers Whitby, Ontario L1N 0G5 Tel: (905) 666-5252 Fax: (905) 666-5256

PRIME CONSULTANT

DATE

KEY PLAN

SCALE DRAWINGS.



X. P. CHEN

100219955

FEB09/2021

REVISIONS

200 JOHN STREET

SUB-CONSULTANT

HCC ENGINEERING DESIGN AND TECHNOLOGY SERVICES GROUP HCC ENGINEERING LIMITED 40 EGLINTON AVENUE EAST, SUITE 600 TORONTO, ONTARIO, M4P 3A2

Tel: (416) 932-2423

HCC Project No.: 20104

	DESIGN BY: PC				SCALE AS SHOWN	
	DRAWN BY: TLR				DATE: 2020-05-01	
	CHECKE	BY: PC/	HDC		CONSULTANT PROJECT NO.	20060
Δ	\PPROVE	BY: HDC	-			
(0						
NO						
REVISIONS						
	4	MAY02/2021	HCC	ISSUED FOR A	DDENDUM #E-01	
RAC	3	FEB09/2021	HCC	ISSUED FOR P	ERMIT & TENDER	
CONTRACT	2	OCT30/2020	HCC	ISSUED FOR 9	0% REVIEW	
	1	JUNE 1/20	HCC	ISSUED FOR 6	0% REVIEW	

ALL MEASUREMENTS ARE TO BE VERIFIED BY THE CONTRACTOR ON SITE AND ANY DISCREPANCIES ARE TO BE REPORTED BEFORE

PROCEEDING WITH THE WORK. THE REGION OF DURHAM ASSUMES

NO RESPONSIBILITY FOR THE ACCURACY OF THE LOCATION OF

EXISTING SERVICES AS INDICATED ON THIS DRAWING. DO NOT

CONFIRM SLAB THICKNESS

BOX FOR MANUFACTURING

PRIOR TO RELEASING FLOOR

DATE

THE REGIONAL MUNICIPALITY OF DURHAM


REVISIONS

WORKS DEPARTMENT DESIGN, CONSTRUCTION & ASSET MANAGEMENT

RELOCATION OF DENTAL CLINIC TO 200 JOHN ST., OSHAWA

ELECTRICAL DETAILS

operty no. /A	FACILITY CODE LEA-0-07	LEA-0-07-19-01
NTRACT NO.	DRAWING NO.	SHEET NO.
-1032-2021	E-002	035

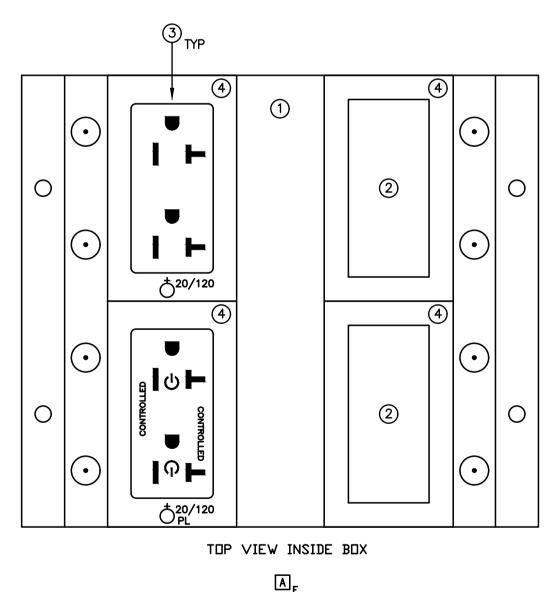

LID FINISH SHALL BE SEMI-GLOSS BLACK EPOXY POWDER.

NEATLY LABEL ALL FLOOR MOUNTED AND WALL DEVICE BOX COVERS WITH CORRESPONDING PANEL NAMES AND CIRCUIT NUMBERS, UTILIZE SELF ADHESIVE MECHANICALLY PRINTED LABELS.

UTILITY CCT - WHITE RECEPTACLE

- (1) FLUSH MOUNTED FLOOR BOX MODEL 400 AS MANUFACTURED BY WELLMARK C/W CARPET RECESSED LID
- 2 SPACE FOR COMMUNICATIONS CONTRACTOR'S
- (3) DECORA STYLE RECEPTACLE
- (4) DECORA STYLE COVERPLATE

BOX FOR MANUFACTURING

CONFIRM SLAB THICKNESS PRIOR TO RELEASING FLOOR

2" LEVELING PLATES SIDE VIEW 3/4" KNOCK OUT 1 1/4" KNOCK OUT

RECESSED FLOOR MOUNTED TYPE 'A' OFFICE GROUP OUTLET DETAIL

EXPANSION JOINT CROSSING DETAIL SCALE: NTS

GROUND

GROUND BUSHING

E-003 SCALE: NTS

TYPICAL RECESSED FLOOR MOUNTED TYPE 'F' OFFICE GROUP OUTLET DETAIL SCALE: NTS Œ-002/

(5) (N-3)

E

1 FLUSH MOUNTED FLOOR BOX MODEL 400 AS MANUFACTURED BY WELLMARK C/W CARPET RECESSED LID

2 NOT USED

(3) NOT USED

4) DECORA STYLE COVERPLATE

5 INSERT C/W CUTOUT FOR VGA OUTLET AND AUDIO OUTLET FOR A/V CONTRACTOR'S USE

NUMBERS, UTILIZE SELF ADHESIVE MECHANICALLY PRINTED LABELS.


N-1) LID FINISH SHALL BE SEMI-GLOSS BLACK EPOXY POWDER.

NEATLY LABEL ALL FLOOR MOUNTED AND WALL DEVICE BOX COVERS WITH CORRESPONDING PANEL NAMES AND CIRCUIT


INSERT C/W CUTOUTS FOR A/V OUTLETS PROVIDED AS PART OF THIS SCOPE OF WORK. TEMPLATE TO BE PROVIDED BY A/V CONTRACTOR DURING CONSTRUCTION.


- N-1) ROUGH-IN DETAILS ARE DIAGRAMMATIC.
- N-2) PROVIDE WIRE, CONDUIT AND BACKBOXES INDICATED.
- COORDINATE THE ROUGH-IN REQUIREMENT WITH DOOR MANUFACTURER AND DOOR OPERATOR CONTRACTOR PRIOR TO CONSTRUCTION.
- (N-4) PULLBOX INDICATED MUST BE LOCATED AT THE SECURED SIDE OF THE DOOR. MINIMUM PULLBOX SIZE 12" X 12".



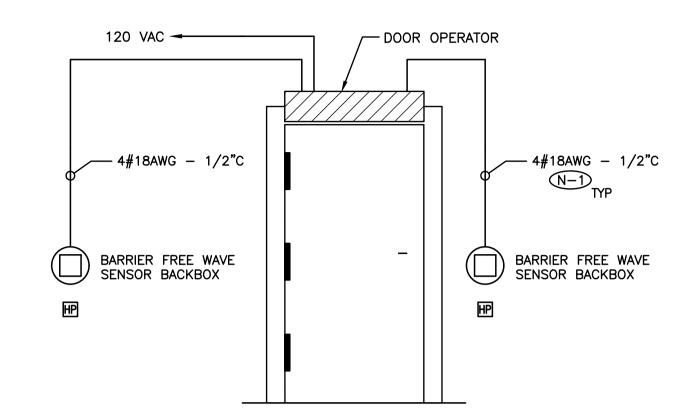

- PROVIDE WIRE, CONDUIT AND BACKBOXES INDICATED.
- COORDINATE THE ROUGH-IN REQUIREMENT WITH DOOR MANUFACTURER PRIOR TO CONSTRUCTION.

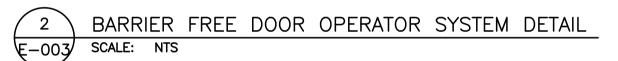


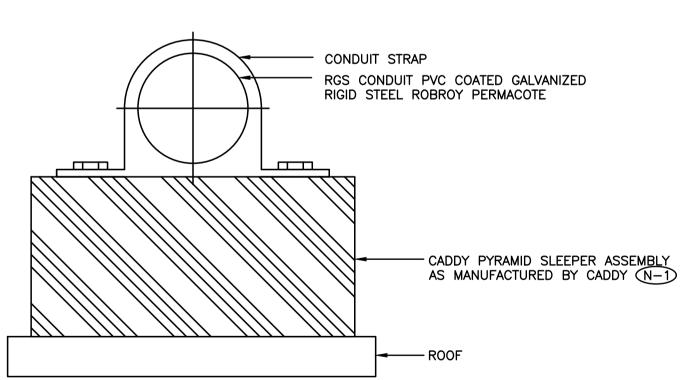

- N-1) LOW VOLTAGE CABLES AND TERMINATIONS PROVIDED BY A/V CONTRACTOR.
- N-2 PROVIDE NYLON INSULATED THROATS FOR ALL BUSHINGS AND CONNECTORS.


TABLE

- N-3 SAW CUTTING OF FLOOR SLAB PROVIDED BY ELECTRICAL CONTRACTOR. EXACT ROUTING TO BE DETERMINED BY SCANNING/X-RAY RESULTS. SUBMIT LAYOUT C/W CONDUIT SIZES TO ELECTRICAL CONSULTANT FOR APPROVAL PRIOR TO CUTTING OF FLOOR SLAB.
- N-4) REFER TO DETAIL NO. 3 ON DRAWING NO. E-004 FOR ADDITIONAL CONDUIT REQUIREMENTS.
- N-5) PROVIDE DEDICATED CORE DRILLED WALL PENETRATIONS ON EVERY FLOOR. EXACT LOCATION OF ALL CORE DRILLS TO BE DETERMINED BY X-RAY RESULTS. ALL X-RAYS MUST BE REVIEWED AND APPROVED BY LANDLORD PRIOR TO CORE DRILLING.
- N-6 COORDINATE CONDUIT TERMINATION REQUIREMENTS ON SITE WITH A/V
- 1) 1 1/2" CONDUIT C/W PULL STRING
- 2 4" SQUARE WALL MOUNTED DEEP BACKBOX C/W WHITE COVERPLATE (PUNCHOUT AS DIRECTED ON SITE) FOR A/V CONTRACTOR'S USE
- (3) LOW PROFILE FLOOR BOX/RECESSED FLOOR MONUMENT/POKE THROUGH/CONDUIT STUB UP
- PROJECTOR CONDUIT ROUGH-IN SYSTEM DETAIL E-003 SCALE: NTS

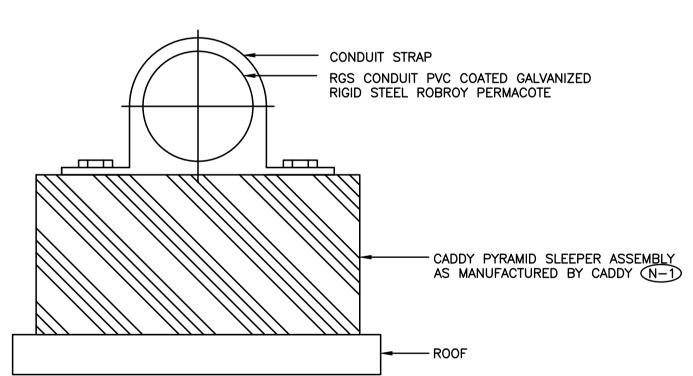

- N-1 PROVIDE SLEEPERS AT 5' INTERVALS.
- N-2) PROVIDE SECONDARY MEMBRANES AND FOAMS AS RECOMMENDED BY MANUFACTURER FOR SPECIFIC ROOF TYPES AND APPLICATIONS.

ROOFTOP CONDUIT MOUNTING DETAIL SCALE: NTS Æ-003/

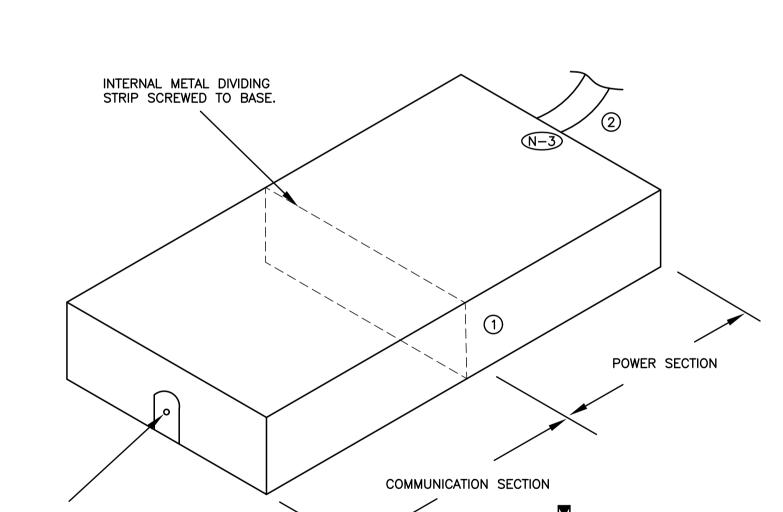

N-1) FINAL POWER CONNECTION TO FURNITURE PROVIDED BY ELECTRICAL CONTRACTOR.

ONE 1 1/4" DIAMETER

GROMMET ON END BASE FOR

COMMUNICATIONS CONTRACTOR'S USE

N-2 NEATLY LABEL ALL FLOOR MOUNTED AND WALL DEVICE BOX COVERS WITH CORRESPONDING PANEL NAMES AND CIRCUIT NUMBERS, UTILIZE SELF ADHESIVE MECHANICALLY PRINTED LABELS.

24 VOLT AC SOURCE PROVIDED

OUTSIDE

SCHEMATIC IS DIAGRAMMATIC ONLY. REFER TO FLOOR PLANS FOR

PROVIDE EDWARDS SIGN-EMERG-PUSH SIGNAGE PER OBC ABOVE

PROVIDE DEDICATED CORE DRILLED WALL PENETRATIONS ON EVERY FLOOR. EXACT LOCATION OF ALL CORE DRILLS TO BE DETERMINED

N-2) PROVIDE WIRING, CONTACTORS AND DUAL VOLTAGE RELAYS (DVR'S)

N-3 ALL LOW VOLTAGE WIRING TO BE ENCLOSED IN A CONDUIT SYSTEM.

WIRE THE APPLIANCE INDICATED FOR VISUAL ALARM ONLY.

BY X-RAY RESULTS. ALL X-RAYS MUST BE REVIEWED AND

APPROVED BY LANDLORD PRIOR TO CORE DRILLING.

(1) DURESS SYSTEM COMBINATION STROBE LIGHT/HORN -

2 DURESS SYSTEM STATION, PUSH BUTTON — EDWARDS

× √4\

UNIVERSAL WASHROOM DURESS SYSTEM SCHEMATIC DIAGRAM

SS-2001E C/W SUB-102722-R SPACER

TRANSFORMER - EDWARDS 592

(4) SECURITY SYSTEM ACCESS CONTROL PANEL

AS REQUIRED FOR A FULLY OPERATIONAL SYSTEM.

LOCATION AND QUANTITY OF DEVICES.

THE DURESS SYSTEM STATION.

EDWARDS 6536-G5

SCALE: NTS

Æ-003


BY ELECTRICAL CONTRACTOR

2 (N-4)

- N-3 PROVIDE OPENING OF ADEQUATE SIZE TO ACCEPT POWER HARNESS.
- 1) LOW PROFILE VIP FLOOR MONUMENT AS MANUFACTURED BY WELLMARK
- (2) FURNITURE POWER HARNESS PROVIDED BY FURNITURE MANUFACTURER

TYPICAL FURNITURE FEED MONUMENT **€**−003 SCALE: NTS

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ASSOCIATES Project Managers Suite 201 Whitby, Ontario L1N 0G5 Tel: (905) 666-5252 Fax: (905) 666-5256

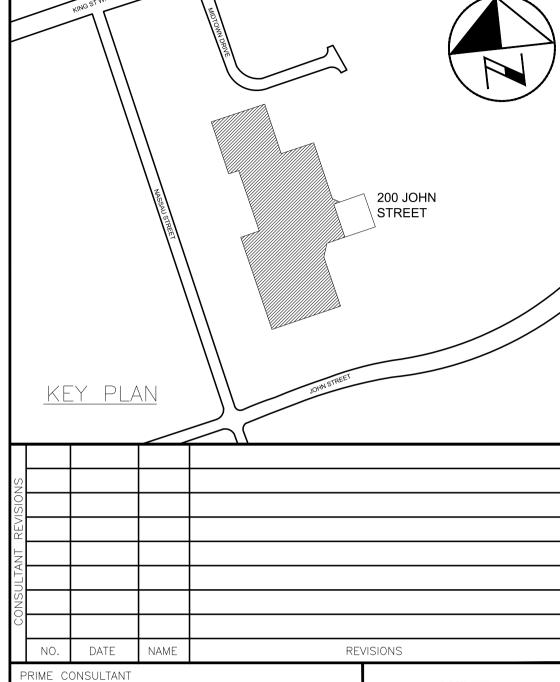

SUB-CONSULTANT

HCC Project No.: 20104

HCC ENGINEERING DESIGN AND TECHNOLOGY SERVICES GROUP

HCC ENGINEERING LIMITED 40 EGLINTON AVENUE EAST, SUITE 600 TORONTO, ONTARIO, M4P 3A2 Tel: (416) 932-2423



DESIGN BY: PC SCALE AS SHOWN DRAWN BY: TLR DATE: **2020-05-01** CONSULTANT PROJECT NO. 20060 CHECKED BY: PC/HDC APPROVED BY: HDC

/4\ |MAY02/2021| HCC | ISSUED FOR ADDENDUM #E-01 3 | FEB09/2021 | HCC | ISSUED FOR PERMIT & TENDER 2 OCT30/2020 HCC ISSUED FOR 90% REVIEW JUNE 1/20 HCC ISSUED FOR 60% REVIEW REVISIONS



THE REGIONAL MUNICIPALITY OF DURHAM

WORKS DEPARTMENT DESIGN, CONSTRUCTION & ASSET MANAGEMENT

RELOCATION OF DENTAL CLINIC TO 200 JOHN ST., OSHAWA

ELECTRICAL DETAILS

FACILITIES PROJECT NO. PROPERTY NO. FACILITY CODE _EA-0-07 EA-0-07-19-01 CONTRACT NO. DRAWING NO. SHEET NO. T - 1032 - 202E - 00

- ROUGH-IN DETAILS ARE DIAGRAMMATIC. REFER TO FLOOR PLANS FOR ADDITIONAL REQUIREMENTS, DEVICE QUANTITY AND LOCATION.
- PULLBOX INDICATED MUST BE LOCATED AT THE SECURED SIDE OF THE DOOR. MINIMUM PULLBOX SIZE 10" X 10" C/W FOUR (4) SECURITY SCREWS TYPE SNAKE EYES.
- N-3 ALL ZONE CONDUITS C/W PULL STRING.
- (N-4) CONTACT SECURITY CONTRACTOR FOR EXACT LOCATION OF SECURITY SYSTEM CABINET, ADDITIONAL CONDUIT AND PULLBOX REQUIREMENTS AND FOR POWER
- N-5 ALL POWER AND CONDUIT WORK REQUIRED AND/OR SHOWN ON DRAWINGS RELATED TO SECURITY SYSTEM SHALL BE INCLUDED IN ELECTRICAL CONTRACTOR'S PRICE. CONTACT SECURITY CONTRACTOR FOR SPECIFIC REQUIREMENTS.
- NOT USED.

- EQUIP THE HANDICAP DOOR OPENER SYSTEM WITH A CONTROL CIRCUIT TO ALLOW FOR AUTOMATIC DOOR OPENING WHEN A CARD IS BADGED AT THE READER. DEPRESSING OF THE HANDICAP PUSH BUTTON WILL NOT BE REQUIRED.
- PROVIDE DOOR OPERATOR INTERFACE DEVICE TO PREVENT AUTOMATIC DOOR OPERATION WHILE THE ELECTRIC STRIKE IS ENERGIZED. REFER TO DETAIL NO. 2 ON DRAWING NO. E-004 FOR ADDITIONAL REQUIREMENTS.

INTERIOR SWITCH (IN CIRCUIT ONLY

WHILE LOCK RELAY IS ACTIVE)

INTERIOR SWITCH (IN CIRCUIT ONLY

WHILE LOCK RELAY IS ACTIVE)

Door Operator

€-004 SCALE: NTS

> 12 - 24 V AC/DC Power

PANEL

CONSTANT POWER FROM DOOR

OPERATOR OR ACCESS CONTROL

Electric Strike

MOV

Wire MOV (supplied) directly to strike

CARD ACCESS CONTROL SYSTEM ROUGH-IN DETAILS


1

CX-12

1 2 3 4 5 6 7 8 9 10 11 12 13 14 15 16 000000000000000000

*** * * * * * * ***

- SCHEMATIC IS DIAGRAMMATIC ONLY. PROVIDE QUANTITY OF INTERFACE DEVICES, HARDWARE, DEVICES, POWER CIRCUITS, CONDUIT, WIRE, SECURITY CABLES, ETC, TO ENSURE A FULLY OPERATIONAL SECURITY SYSTEM. REFER TO ROOM LAYOUTS AND FLOOR PLANS FOR ADDITIONAL REQUIREMENTS.
- (N-2) PROVIDE CONDUITS AND WIRES IN ACCORDANCE WITH THE MANUFACTURER'S RECOMMENDATIONS.
- N-3 ALL CONDUITS TO BE EMT. EMT COUPLING AND CONNECTORS SHALL BE T&B STEEL, SET SCREW TYPE. PROVIDE SPARE PULLSTRING IN ALL CONDUITS FOR
- N-4 ELECTRICAL CONTRACTOR SHALL NOT USE PULLBOXES AS SUBSTITUTES FOR 90° BENDS. 12" X 12" X 6" PULLBOXES C/W TYPE SNAKE EYE SECURITY SCREWS SHALL BE PROVIDED ON THE BASIS OF NOT MORE THAN TWO (2) RIGHT ANGLE BENDS OR NOT MORE THAN 100' IN STRAIGHT RUNS BETWEEN
- N-5) CONTACT SECURITY MANUFACTURER FOR ADDITIONAL WIRE, CONDUIT, PULLBOX AND POWER REQUIREMENTS OVER AND ABOVE THOSE SHOWN ON DRAWING.
- N-6 PROVIDE DEDICATED FLOOR AND WALL PENETRATIONS. EXACT LOCATION OF ALL CORE DRILLS TO BE DETERMINED BY X-RAY RESULTS. X-RAYS MUST BE REVIEWED AND APPROVED BY LANDLORD AND STRUCTURAL ENGINEER PRIOR TO CORE DRILLING.
- 1) DOOR OPERATOR INTERFACE DEVICE CAMDEN DOOR CONTROLS CX-12 SWITCHING NETWORK AND BI-DIRECTIONAL DOOR SEQUENCER

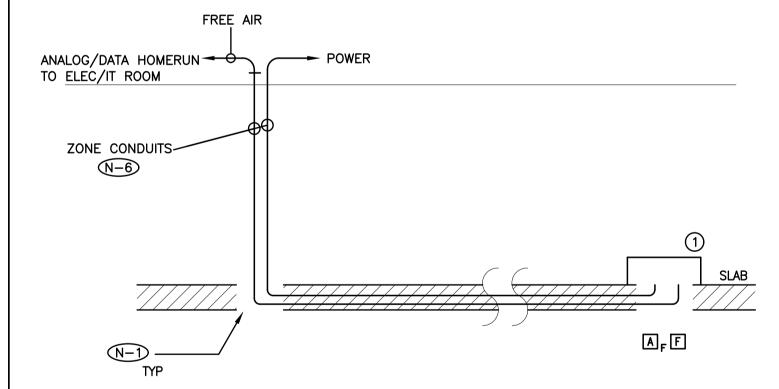

- N-1) SEAL OPENING AROUND CONDUITS.
- N-2 ALL CONDUITS PROVIDED FOR COMMUNICATIONS CONTRACTOR SHALL BE C/W PULLSTRING.
- N-3 SAW CUTTING OF FLOOR SLAB PROVIDED BY ELECTRICAL CONTRACTOR. EXACT ROUTING TO BE DETERMINED BY SCANNING/X-RAY RESULTS. SUBMIT LAYOUT C/W CONDUIT SIZES TO ELECTRICAL CONSULTANT FOR APPROVAL PRIOR TO CUTTING OF FLOOR SLAB.
- N-4 MINIMUM COMMUNICATIONS CONDUIT SIZE TO SERVICE EACH LOW PROFILE FLOOR BOX /RECESSED FLOOR MONUMENT/CONDUIT STUB UP/POKE THROUGH AS FOLLOWS:


$A_{\rm F}$ 1 X 1 1/4"C

- N-5) REFER TO DETAIL NO. 4 ON DRAWING NO. E-003 FOR A/V CONDUIT REQUIREMENTS.
- N-6 ELECTRICAL CONTRACTOR TO CONFIRM TERMINATION REQUIREMENTS AND ROUTING WITH COMMUNICATIONS CONTRACTOR ON SITE PRIOR TO INSTALLATION OF ZONE CONDUITS.
- N-7) PROVIDE DEDICATED CORE DRILLED WALL PENETRATIONS ON EVERY FLOOR. EXACT LOCATION OF ALL CORE DRILLS TO BE DETERMINED BY X-RAY RESULTS. ALL X-RAYS MUST BE REVIEWED AND APPROVED BY LANDLORD PRIOR TO CORE DRILLING.
- (1) LOW PROFILE FLOOR BOX/RECESSED FLOOR MONUMENT/CONDUIT STUB UP/POKE THROUGH

E-004 SCALE: NTS

SAW CUTTING FLOOR FEED SERVICES DETAIL

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ASSOCIATES Project Managers Suite 201 Whitby, Ontario L1N 0G5 Tel: (905) 666-5252 Fax: (905) 666-5256

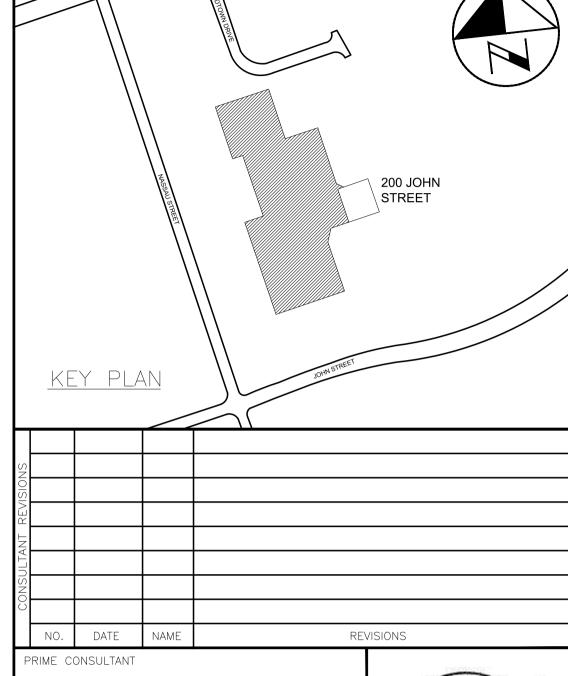

SUB-CONSULTANT

HCC Project No.: 20104

HCC ENGINEERING DESIGN AND TECHNOLOGY SERVICES GROUP HCC ENGINEERING LIMITED 40 EGLINTON AVENUE EAST, SUITE 600

TORONTO, ONTARIO, M4P 3A2 Tel: (416) 932-2423

S AMONION X. P. CHEN 100219955 FEB09/2021

DESIGN BY: PC SCALE AS SHOWN DATE: **2020-05-01** DRAWN BY: TLR CONSULTANT PROJECT NO. 20060 CHECKED BY: PC/HDC PPROVED BY: HDC

4 MAY02/2021 HCC | ISSUED FOR ADDENDUM #E-01 3 | FEB09/2021 | HCC | ISSUED FOR PERMIT & TENDER 2 OCT30/2020 HCC ISSUED FOR 90% REVIEW 1 JUNE 1/20 HCC ISSUED FOR 60% REVIEW DATE



THE REGIONAL MUNICIPALITY OF DURHAM

WORKS DEPARTMENT DESIGN, CONSTRUCTION & ASSET MANAGEMENT

REVISIONS

RELOCATION OF DENTAL CLINIC TO 200 JOHN ST., OSHAWA

ELECTRICAL DETAILS

PROPERTY NO. FACILITY CODE FACILITIES PROJECT NO. _EA-0-07 EA-0-07-19-01 CONTRACT NO. DRAWING NO. SHEET NO. T - 1032 - 202E - 004



DOOR OPERATOR INTERFACE SCHEMATIC SCALE: NTS

• | | | | | | | •

for Strike

- N-1) DETAIL IS DIAGRAMMATIC ONLY.
- N-2 REFER TO FLOOR PLANS FOR EXACT QUANTITY AND LOCATION OF
- N-3 CONDUIT, TIE WIRE AND OTHER ASSEMBLY MEANS TO SUPPORT DEVICE BACKBOX IS NOT ACCEPTABLE.
- (1) BACKBOX SUPPORTING SMOKE DETECTOR/HEAT DETECTOR

TYPICAL FIRE DETECTOR T-BAR CEILING SUPPORT DETAIL

POWER

PANELS

POWER

PANELS

BOOSTER

SPRINKLER ROOM

N-15
TVP

PARTIAL BASE BUILDING FIRE ALARM SYSTEM RISER DIAGRAM

BOOSTER

- 2 CEILING TILE FRAME
- (3) CEILING TILE
- (4) BOX HANGER C/W BOX MOUNTING CLIP
- (5) T-BAR CLIP

€-005/

EXISTING FIRE

ALARM SYSTEM


CONTROL PANEL

N-6 N-8

BASE BUILDING

E-005 SCALE: NTS

SCALE: NTS

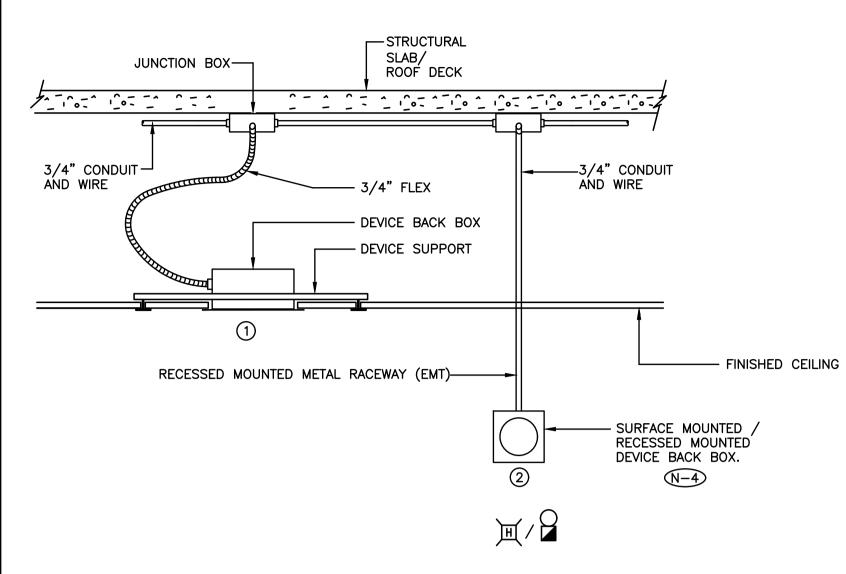

- (N-1) DETAIL IS DIAGRAMMATIC ONLY.
- N-2 REFER TO FLOOR PLANS FOR EXACT QUANTITY AND LOCATION OF DEVICES.
- N-3 CONDUIT/TIE WIRE AND OTHER ASSEMBLY MEANS TO SUPPORT DEVICE BACKBOX IS NOT ACCEPTABLE.
- N-4 ALL WALL MOUNTED DEVICES TO BE RECESSED MOUNTED FOR ALL INTERIOR
- (1) CEILING MOUNTED FIRE ALARM SYSTEM SIGNALLING DEVICE.
- (2) WALL MOUNTED FIRE ALARM SYSTEM SIGNALLING DEVICE.

FIXTURE SCHEDULE

- 25W 3000 LUMEN 2' X 2' RECESSED MOUNTED LED FIXTURE, SUITABLE FOR LAY-IN CEILING C/W IN LINE POWER DISCONNECT, POWER SUPPLY, 120V 0 TO 10VDC DIMMING DRIVER, BASKET LENS AND LAMP (4000K/85% CRI). PACO LIGHTING PRTX-22-L-30-40-MV-DM OR APPROVED EQUAL.
- 40W 5000 LUMEN 2' X 2' RECESSED MOUNTED LED FIXTURE, SUITABLE FOR LAY-IN CEILING C/W IN LINE POWER DISCONNECT, POWER SUPPLY, 120V 0 TO 10VDC DIMMING DRIVER, BASKET LENS AND LAMP (4000K/85% CRI). PACO LIGHTING PRTX-22-L-50-40-MV-DM OR APPROVED EQUAL.
- TYPE A1 1' X 4' SURFACE MOUNTED FLUORESCENT FIXTURE C/W ELECTRONIC BALLAST, WRAP AROUND ACRYLIC LENS AND 2 X 32W T8 LAMPS.
- 1' X 4' RECESSED MOUNTED FLUORESCENT FIXTURE, SUITABLE FOR LAY-IN CEILING C/W ELECTRONIC BALLAST, ACRYLIC LENS AND 2 X 32W T8 LAMPS.
- TYPE A3 1' X 4' RECESSED MOUNTED FLUORESCENT FIXTURE, SUITABLE FOR LAY-IN CEILING C/W ELECTRONIC BALLAST AND 2 X 32W T8 LAMPS.
- 2' X 4' RECESSED MOUNTED FLUORESCENT FIXTURE, SUITABLE FOR LAY-IN CEILING C/W ELECTRONIC BALLAST, ACRYLIC LENS AND 4 X 32W T8 LAMPS.
- 2' X 4' RECESSED MOUNTED FLUORESCENT FIXTURE, SUITABLE FOR LAY-IN CEILING C/W ELECTRONIC BALLAST AND 4 X 32W T8 LAMPS.
- 2' X 2' RECESSED MOUNTED FLUORESCENT FIXTURE, SUITABLE FOR LAY-IN CEILING C/W ELECTRONIC BALLAST, ACRYLIC LENS AND 2 X 32W T8 U-LAMPS.
- 4' SUSPENDED FLUORESCENT STRIP FIXTURE C/W ELECTRONIC BALLAST, WIRE GUARD AND 2 X
- TYPE A8 4' SURFACE MOUNTED FLUORESCENT STRIP FIXTURE C/W ELECTRONIC BALLAST AND 2 X 32W T8
- 14W 1315 LUMEN 4" LED RECESSED ROUND DOWNLIGHT SUITABLE FOR DRYWALL CEILING C/W IN LINE POWER DISCONNECT. 120V 0 TO 10VDC DIMMING DRIVER AND LAMP (4000K 90%CRI). PATHWAY LIGHTING 4VLFL2X15004KE1DA, 4VLED SCLPF OR APPROVED EQUAL
- TYPE B1 7W 688 LUMEN 4" LED RECESSED ROUND DOWNLIGHT SUITABLE FOR DRYWALL CEILING C/W IN LINE POWER DISCONNECT, 120V 0 TO 10VDC DIMMING DRIVER AND LAMP (4000K 90%CRI). PATHWAY LIGHTING 4VLFL2X8004KE1DA, 4VLED SCLPF OR APPROVED EQUAL.
- TYPE B2 6" RECESSED MOUNTED DOWNLIGHT SUITABLE FOR LAY-IN CEILING C/W ELECTRONIC BALLAST AND
- TYPE B3 -RECESSED MOUNTED ADJUSTABLE DOWNLIGHT SUITABLE FOR LAY-IN CEILING C/W ELECTRONIC BALLAST AND MR16 LAMP (3500K/85% CRI).
- LED UNDERCABINET FIXTURE C/W IN LINE POWER DISCONNECT AND LAMPS (4000K, 97%CRI). COLOR KINETICS EW PROFILE POWERCOVE GEN4 OR APPROVED EQUAL FOR SHADOWLESS ILLUMINATION C/W 120 VOLT REVERSE PHASE DIMMING ELECTRONIC DRIVERS (QUANTITY TO SUIT RUN LENGTH), INSTALLATION MOUNTING CHANNEL, LEAD CABLES, 125X120 BEAM SPREAD. REFER TO ARCHITECTURAL DRAWINGS FOR RUN LENGTH AND ADDITIONAL BUILD OUT DETAILS .
- EMERGENCY LIGHTING SYSTEM C/W 10 YEAR 24VOLT/720W/0.5 HOUR/BATTERY UNIT/120/347 VOLT INPUT/LUMACELL RGS SERIES OR BEGHELLI NOVA SERIES OR APPROVED EQUAL
- TYPE D2 2 X 4W MR16 LED 24V SIGNATURE COLLECTION OR 2 X 5W MR16 24V BEGHELLI BTMR SERIES REMOTE HEADS OR APPROVED EQUAL, WHITE IN COLOUR.
- 1 X 4W MR16 LED 24V SIGNATURE COLLECTION OR 1 X 5W MR16 24V BEGHELLI BTMR SERIES TYPE D3
- REMOTE HEADS OR APPROVED EQUAL, WHITE IN COLOUR.
- TYPE D4 2 X 6W MR16 LED 24V SIGNATURE COLLECTION OR 2 X 7W MR16 24V BEGHELLI BTMR SERIES REMOTE HEADS OR APPROVED EQUAL, WHITE IN COLOUR.
- 1 X DC REMOTE HEAD
- 2 X DC REMOTE HEADS
- EMERGENCY LIGHTING SYSTEM DC BATTERY UNIT
- PICTOGRAM WHITE LED EXIT SIGN C/W 120/347VAC/24VDC LED. LUMACELL LA-3 SERIES PICTOGRAM EXTRUDED ALUMINUM EXIT SIGN C/W LUMACELL EZ2 CANOPY OR BEGHELLI STELLA RM SERIES SL-RM-L-U-OLR-M-120/347-UDC OR APPROVED EQUAL.
- TYPE E2 EXIT SIGN. READ TYPE.

FIXTURE SCHEDULE E-005/ SCALE: NTS

DWG FIRE

ZONE NO.

DMSD01

DMSD02

DMSD03

WALL/CEILING MOUNTED FIRE ALARM SYSTEM SIGNALLING DEVICE DETAIL SCALE: NTS



N-1) RISER IS DIAGRAMMATIC ONLY. PROVIDE QUANTITY OF PROVIDE QUANTITY OF BELL CIRCUITS, INITIATING DEVICE CIRCUITS, HARDWARE, MODULES, ACCESSORIES, DEVICES, CONDUIT, WIRE, ETC. TO ENSURE A FULLY OPERATIONAL FIRE ALARM SYSTEM.

REFER TO FLOOR PLANS AND REFLECTED CEILING PLANS FOR EXACT

ACCESSORIES (IE. WIRE GUARD, EXPLOSION PROOF DEVICES, WEATHER PROOF DEVICES, ETC.). (N-3) PROVIDE POWER, CONDUIT, BACKBOX AND WIRING IN ACCORDANCE WITH

QUANTITY AND LOCATION OF DEVICES, DEVICE PERIPHERALS AND

MANUFACTURER'S RECOMMENDATIONS. MINIMUM CONDUIT SIZE 3/4". N-4) PROVIDE DEDICATED CORE DRILLED FLOOR AND WALL PENETRATIONS ON EVERY FLOOR AS REQUIRED FOR FIRE ALARM SYSTEM CONDUITS/MI CABLE.

EXACT LOCATION OF ALL CORE DRILLS TO BE DETERMINED BY X-RAYING

- N-5) PROVIDE STROBE CIRCUIT SYNCHRONIZATION MODULES.
- N-6) MODIFY, REWORK AND PROVIDE ALL COMPONENTS AND ACCESSORIES FOR CONTROL PANEL AS REQUIRED TO ACCOMMODATE ALL SCOPES OF WORK AS NOTED ON DRAWINGS AND IN SPECIFICATION.
- N-7) PROVIDE REMOTE ULC APPROVED BOOSTER PANELS AND POWER SUPPLIES. C/W BATTERIES APPROVED FOR THE SIGNALING DEVICES PROVIDED AS PÁRT OF THIS SCOPE OF WORK. REFER TO FLOOR PLANS AND REFLECTED CEILING PLANS FOR LOCATION AND QUANTITY OF SIGNALING DEVICES. PROVIDE ADDRESSABLE INPUT MODULE TO MONITOR THE TROUBLE RELAY.
- PROVIDE ADDITIONAL BATTERIES IN EXISTING CONTROL PANEL AS REQUIRED TO SUPPORT THE TOTAL LOAD REQUIREMENTS AT THE COMPLETION OF
- N-9 PROVIDE 24VDC CIRCUITS FOR 24VDC DEVICES. MAXIMUM LOAD ON EACH CIRCUIT SHALL NOT EXCEED 70%. CIRCUIT REQUIREMENTS NOT SHOWN ON RISER DIAGRAM.
- AS PART OF THE BASE BID PRICE ELECTRICAL CONTRACTOR SHALL PROVIDE A FIRE WATCH THROUGHOUT THE DURATION OF THE PROJECT.
- (N-1) NOT USED.

─ EOL RTU−1

EOL RTU-2

EOL RTU-3

- $\sqrt{12}$ DO NOT REUSE EXISTING FIELD WIRING, FIRE ALARM DEVICES, ETC., REMOVED AS PART OF THIS SCOPE OF WORK.
- √13 DUCTMOUNT SMOKE DETECTORS SHALL BE HARD WIRED INTO CORRESPONDING FAN CIRCUITS TO DIRECTLY SHUT DOWN FANS UPON FIRE ALARM CONDITION. PROVIDE CONTACTORS, DVR'S AND ENCLOSURES REQUIRED.
- √-1

 PROVIDE REMOTE INDICATING LED FOR EACH DUCTMOUNT SMOKE

 Output

 Description

 Output

 Description

 D DETECTOR. EXACT MOUNTING LOCATION TO BE DETERMINED ON SITE. LED'S NOT SHOWN ON DRAWINGS.
 - EXACT MOUNTING LOCATION OF DUCT MOUNTED SMOKE DETECTORS TO BE DETERMINED BY MANUFACTURER ON SITE.

- (1) EXISTING FIRE ALARM SYSTEM CONTROL PANEL - MIRCOM SERIES 1000
- (2) CONDUIT AND WIRE PER MANUFACTURER'S SPECIFICATIONS
- (3) FIRE ALARM SYSTEM BOOSTER PANEL PROVIDED AS PART OF THIS SCOPE OF

BASE BUILDING FIRE ALARM SYSTEM MANUFACTURER CONTACT: KRYSTAL NICHOLAS, MIRCOM: KNICHOLAS@MIRCOMGROUP.COM / (647) 460-2449

DENOTES NEW PROVIDED BY

ELECTRICAL CONTRACTOR

REMOVED BY ELECTRICAL

---- DENOTES EXISTING TO REMAIN

CONTRACTOR

-X-X-X-X-DENOTES EXISTING TO BE

N-1) ZONE DESCRIPTION TO BE DETERMINED ON SITE.

RTU-1

RTU-2

RTU-3

- N-2) 'SC' DENOTES SUPERVISORY CONTACT.

FIRE ZONE

ID LABEL (N-1)

N-3 SEQUENCE OF OPERATIONS AND ALARM/ALERT SIGNALING REQUIREMENTS TO BE COORDINATED WITH CONSULTANT, MECHANICAL CONTRACTOR, FIRE ALARM MANUFACTURER AND BUILDING INSPECTOR THROUGH SHOP DRAWING APPROVAL PROCESS.

INITIATING

DEVICE

ALARM

SIGNAL


TROUBLE

SIGNAL

(N-4) SCHEDULE REFLECTS NEW ZONES TO BE ADDED TO THE BASE BUILDING FIRE ALARM SYSTEM AS PART OF THIS CONTRACT. UPDATE EXISTING BASE BUILDING FIRE ALARM SYSTEM CPU, TRANSPONDER, ANNUNCIATOR PANELS, PASSIVE GRAPHIC DISPLAY, ACTIVE GRAPHIC DISPLAY, ETC.

FIRE ALARM SYSTEM ZONE SCHEDULE E-005 SCALE: NTS

ALL MEASUREMENTS ARE TO BE VERIFIED BY THE CONTRACTOR ON SITE AND ANY DISCREPANCIES ARE TO BE REPORTED BEFORE PROCEEDING WITH THE WORK, THE REGION OF DURHAM ASSUMES NO RESPONSIBILITY FOR THE ACCURACY OF THE LOCATION OF EXISTING SERVICES AS INDICATED ON THIS DRAWING. DO NOT SCALE DRAWINGS.

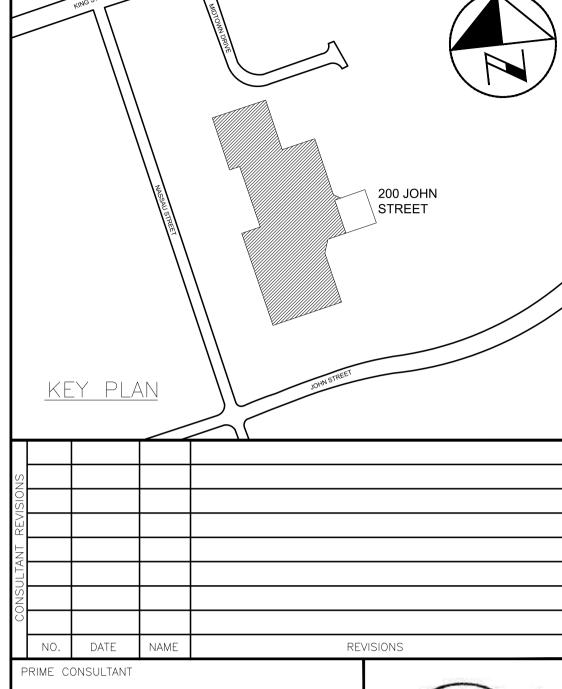

ASSOCIATES Project Managers Whitby, Ontario L1N 0G5



SUB-CONSULTANT

HCC ENGINEERING DESIGN AND TECHNOLOGY SERVICES GROUP HCC ENGINEERING LIMITED 40 EGLINTON AVENUE EAST, SUITE 600

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Fax: (905) 666-5256



HCC Project No.: 20104

[DESIGN BY: PC				^{SCALE} AS SHOWN	
[DRAWN BY: TLR				DATE: 2020-05-01	
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RACT		FEB09/2021	HCC	ISSUED FOR F	PERMIT & TENDER	
INO	2	OCT30/2020	HCC	ISSUED FOR 9	0% REVIEW	
C	1	JUNE 1/20	HCC	ISSUED FOR 6	0% REVIEW	



DATE

THE REGIONAL MUNICIPALITY OF DURHAM

REVISIONS

WORKS DEPARTMENT

DESIGN, CONSTRUCTION & ASSET MANAGEMENT

RELOCATION OF DENTAL CLINIC | TO 200 JOHN ST., OSHAWA

ELECTRICAL DETAILS

property no. N/A	facility code LEA-0-07	facilities project no. LEA-0-07-19-01
CONTRACT NO.	DRAWING NO.	SHEET NO.
T-1032-2021	E-005	038

SCHEMATIC IS DIAGRAMMATIC ONLY. REFER TO FLOOR PLANS AND REFLECTED CEILING PLANS FOR DEVICE QUANTITY AND LOCATIONS. PROVIDE QUANTITY OF HARDWARE, ROOM CONTROLLERS, PLUG LOAD CONTROLLERS, SENSORS, DEVICES, CONDUIT, WIRE, CONFIGURATION TOOLS, ETC. TO ENSURE A FULLY OPERATIONAL LOW VOLTAGE LIGHTING CONTROL SYSTEM.

ALL CONTROLLED RECEPTACLES SHALL BE PERMANENTLY MARKED TO VISUALLY DIFFERENTIATE THEM FROM UNCONTROLLED RECEPTACLES.

PLUG LOAD CONTROLLERS TO BE INSTALLED IN CEILING MOUNTED JUNCTION BOXES.

ALL LOW VOLTAGE WIRING TO BE INSTALLED IN AN ENCLOSED CONDUIT SYSTEM.

PROVIDE POWER, CONDUIT, BACKBOX AND WIRING IN ACCORDANCE WITH MANUFACTURER'S SPECIFICATIONS. MINIMUM CONDUIT SIZE

PROVIDE DEDICATED CORE DRILLED WALL AND FLOOR PENETRATIONS ON EVERY FLOOR. EXACT LOCATION OF ALL CORE DRILLS TO BE DETERMINED BY X-RAY RESULTS. ALL X-RAYS MUST BE REVIEWED AND APPROVED BY LANDLORD PRIOR TO CORE DRILLING.

PROVIDE ROOM CONTROLLERS TO ACCOMMODATE ALL LIGHTING ZONES IN CLOSED ROOMS (IE. OFFICES, MEETING ROOMS, ETC.) PROVIDED AS PART OF THIS SCOPE OF WORK. MAXIMUM OF TWO (2) SWITCH LEGS PER ROOM CONTROLLER.

NOT USED.

ROOM CONTROLLERS TO BE INSTALLED IN CEILING MOUNTED JUNCTION BOXES.

TERMINATE AND TEST ALL LOW VOLTAGE CONTROL CABLES PROVIDED AS PART OF THIS SCOPE OF WORK. PROVIDE TEST RESULTS FOR ALL LOW VOLTAGE CONTROL CABLES PROVIDED AS PART OF THIS SCOPE OF WORK AT THE END OF CONSTRUCTION. TEST RESULTS SHALL BE INCLUDED AS PART OF THE CLOSE OUT DOCUMENTS. REFER TO SPECIFICATIONS FOR ADDITIONAL REQUIREMENTS.

REFER TO MANUFACTURER'S INSTALLATION GUIDELINES FOR ADDITIONAL INSTALLATION REQUIREMENTS OVER AND ABOVE THOSE DETAILS ON THIS SCHEMATIC.

NOT USED. NOT USED.

PROVIDE POWER PACKS, AS REQUIRED FOR A FULLY OPERATIONAL

SITE PRIOR TO EXECUTION.

SYSTEM. POWER PACKS NOT SHOWN ON REFLECTED CEILING PLANS. ELECTRICAL CONTRACTOR'S BASE BID PRICE SHALL INCLUDE EIGHT (8) HOURS OF ON SITE COORDINATION TIME WITH LIGHTING CONTROL SYSTEM MANUFACTURER PRIOR TO ORDERING LIGHTING SYSTEM COMPONENTS TO CONFIRM DEVICES AND WIRING REQUIREMENTS. ALL CHANGES TO BE REVIEWED AND APPROVED BY CONSULTANT ON

N-16 (LIGHT LEVEL OUTPUT (IE, DIMMING LEVEL) FOR EACH AND EVERY FIXTURE PROVIDED AS PART OF THIS SCOPE OF WORK IN ROOMS/AREAS/CORRIDORS/ETC., WITH DLM CONTROL TO BE FIELD ADJUSTED ON SITE WITH CLIENT POST OCCUPANCY. TARGET LIGHT LEVELS FOR EACH LOW VOLTAGE LIGHTING ZONE TO BE PROVIDED \triangleright BY THE CLIENT POST OCCUPANCY. PROCURE (COORDINATE AND PAY FOR) THE SERVICES OF WATTSTOPPER TO ADJUST, PROGRAM AND COMMISSION THE LIGHTING CONTROL SYSTEM.

AS PART OF THIS SCOPE OF WORK PROCURE THE SERVICES OF A THIRD PARTY PROFESSIONAL ENGINEER TO MEASURE AND RECORD LIGHTING LEVELS IN FOOT CANDLES THROUGHOUT THE ENTIRE SCOPES OF WORK AREAS WITH A CALIBRATED LIGHT METER, AFTER ALL FIELD ADJUSTMENTS HAVE BEEN COMPLETED. READINGS SHALL BE TAKEN BASED ON A MINIMUM OF ONE READING FOR EVERY 20' CENTER IN OPEN OFFICE AREAS AND CORRIDORS / HALLWAYS AND ONE READING IN EACH CLOSED OFFICE, MEETING ROOM, BOARDROOM, ETC. ALL LIGHT LEVEL READINGS ARE TO BE TAKEN DURING NON-DAYLIGHT HOURS. PROVIDE A SEALED REPORT IDENTIFYING LIGHT LEVEL READINGS.

INSTALL LOW VOLTAGE CONTROL SYSTEM IN ACCORDANCE WITH THE MANUFACTURER'S INSTRUCTIONS, ASHRAE 90.1 2013, ONTARIO BUILDING CODE, ELECTRICAL SAFETY CODE AND THESE DOCUMENTS.

TYPICAL RECEPTACLE / LIGHTING PANEL. REFER TO DRAWING NO. E-015 FOR ADDITIONAL REQUIREMENTS

(2) NOT USED

(3) NOT USED

(4) ON / OFF / DIMMING ROOM CONTROLLER

(5) PLENUM RATED 4 PAIR CAT6 UTP CABLE AS MANUFACTURED BY LIGHTING CONTROL SYSTEM MANUFACTURER


(6) 0 TO 10VDC CONTROL WIRING PER MANUFACTURER'S RECOMMENDATIONS

(7) PLUG LOAD CONTROLLER


DENOTES NEW PROVIDED BY ELECTRICAL CONTRACTOR. DENOTES EXISTING TO REMAIN.

DENOTES EXISTING TO BE REMOVED BY ELECTRICAL CONTRACTOR.

ALL MEASUREMENTS ARE TO BE VERIFIED BY THE CONTRACTOR ON SITE AND ANY DISCREPANCIES ARE TO BE REPORTED BEFORE PROCEEDING WITH THE WORK. THE REGION OF DURHAM ASSUMES NO RESPONSIBILITY FOR THE ACCURACY OF THE LOCATION OF EXISTING SERVICES AS INDICATED ON THIS DRAWING. DO NOT SCALE DRAWINGS.

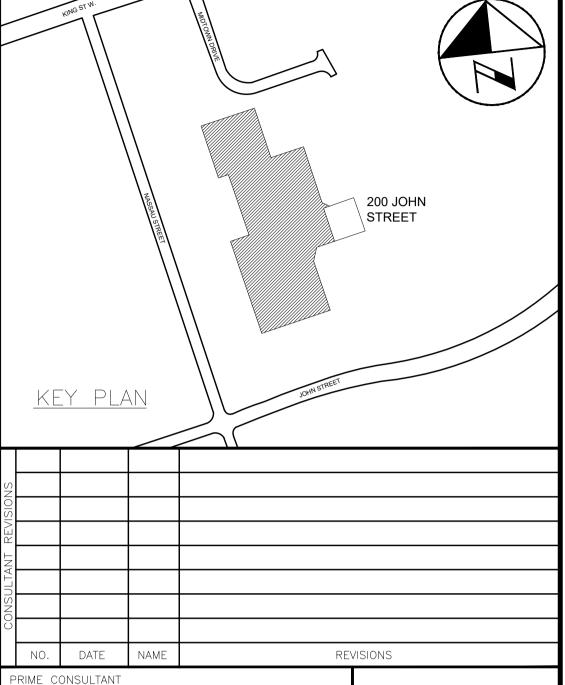


ASSOCIATES roject Managers Whitby, Ontario L1N 0G5 Tel: (905) 666-5252 Fax: (905) 666-5256

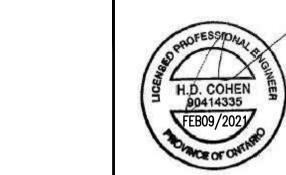

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HCC Project No.: 20104

DESIGN BY: SCALE AS SHOWN DRAWN BY: TLR DATE: **2020-05-01** CONSULTANT PROJECT NO. 20060 CHECKED BY: PC/HDC APPROVED BY: HDC 4\ APR15/2021 HCC | ISSUED FOR ADDENDUM #E-01 3 | FEB09/2021 | HCC | ISSUED FOR PERMIT & TENDER OCT30/2020 HCC I ISSUED FOR 90% REVIEW JUNE 1/20 | HCC | ISSUED FOR 60% REVIEW

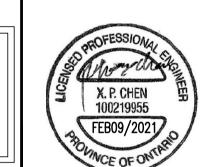

THE REGIONAL MUNICIPALITY OF DURHAM

REVISIONS

WORKS DEPARTMENT

DESIGN, CONSTRUCTION & ASSET MANAGEMENT

RELOCATION OF DENTAL CLINIC | TO 200 JOHN ST., OSHAWA

ELECTRICAL DETAILS

FACILITY CODE PROPERTY NO. FACILITIES PROJECT NO. EA - O - O7 - 19 - O_EA-0-07 CONTRACT NO. DRAWING NO. SHEET NO. T-1032-202

D-64/66/62 0000 N-1) EXACT LOCATION OF ALL DEVICES AND RESPECTIVE HEIGHTS TO BE COORDINATED ON SITE WITH ARCHITECT. $\sqrt{140} D - 48/50$ 2 X Q{20/120} N-2) NEATLY LABEL ALL FLOOR MOUNTED AND WALL DEVICE BOX COVERS WITH CORRESPONDING PANEL NAMES AND CIRCUIT NUMBERS. UTILIZE SELF ADHESIVE MECHANICALLY PRINTED LABELS. CIRCUIT NUMBERS MAY NOT BE CHANGED WITHOUT PRIOR APPROVAL FROM THE ELECTRICAL ENGINEER. **-□**Ø€-15 CONFIRM BREAKER/FUSE AND RECEPTACLE/DISCONNECT REQUIREMENTS PRIOR TO INSTALLATION. MCA:1.0 LAYOUT OF DISTRIBUTION EQUIPMENT, GROUND BARS, CABLE TRAY, ETC. MUST BE AS SHOWN ON DRAWING. CONTRACTOR IS NOT TO DEVIATE FROM LAYOUT. CONTRACTOR TO MARK EXACT LOCATION AND LAYOUT OF ALL DISTRIBUTION, EQUIPMENT, ETC. PROVIDED AS PART OF THIS SCOPE OF WORK AND ALL EQUIPMENT CABINET AND EQUIPMENT RACK FOOTPRINTS ON SLAB FOR FINAL REVIEW AND APPROVAL FROM STRUCTURAL ENGINEER AND ELECTRICAL ENGINEER. ELECTRICAL CONTRACTOR SHALL BE RESPONSIBLE FOR COORDINATING LAYOUT WITH MECHANICAL

DUCT WORK, SPRINKLER PIPING, EXISTING CONDUIT SYSTEMS, ETC. (AS PART OF THE BASE BID PRICE ELECTRICAL CONTRACTOR SHALL PROVIDE (SUPPLY AND INSTALL) AN ADDITIONAL TWO (2) WALL MOUNTED CSA 5-20R (T SLOT) DUPLEX RECEPTACLES OVER AND ABOVE THOSE SHOWN ON DETAIL NO. 2 ON DRAWING NO. É-006 ON AN AD HOC BASIS - UP TO SUBSTANTIAL COMPLETION. EACH ADDITIONAL RECEPTACLE SHALL BE ON A DEDICATED CIRCUIT COMPLETE WITH BRANCH WIRING (CONDUIT AND WIRE) AND BREAKER. BREAKER REQUIREMENTS NOT INDICATED ON PANEL SCHEDULES.

PROVIDE RECEPTACLES, CONDUIT, WIRE (200' OF 2#10AWG + G (TOTAL OF 400' WIRE PLUS G) AND 200' 3/4" CONDUIT/RECEPTACLE). BREAKERS. TERMINATION AT PANEL BREAKER END AND AT DEVICE END, ETC. FOR FULLY FUNCTIONAL LIVE DEVICES. EXACT INSTALLATION LOCATION AND PANEL SOURCE TO BE DETERMINED ON SITE BY CLIENT DURING CONSTRUCTION. PROVIDE UPDATED TYPED PANEL SCHEDULES FOR ALL PANELS AT THE COMPLETION OF THE PROJECT.

ROUTE ALL CONDUIT SYSTEMS AROUND BEAMS, DUCT WORK AND PIPING AS REQURIED TO ACCOMMODATE INSTALLATION. REFER TO MECHANICAL DRAWINGS AND ARCHITECT DRAWINGS FOR ADDITIONAL DETAILS.

N-8 ALL SERVICES TO BE PULLED IN EMT CONDUIT.

ALL CABLE TRAY SEGMENTS SHALL BE SUSPENDED FROM CEILING STRUCTURE. SUPPORT AT A MAXIMUM OF 4' INTERVALS. SUPPORT INFRASTRUCTURE SHALL BE SUBMITTED BY ELECTRICAL CONTRACTOR FOR REVIEW AND APPROVAL BY THE STRUCTURAL ENGINEER. AS A MINIMUM PROVIDE 1-5/8" X 3-1/4", 12 GAUGE SOLID UNISTRUT CHANNEL. HANG DIRECTLY FROM CEILING STRUCTURE UTILIZING 5/8" THREADED ROD, CPI 11408-003 SUPPORT BRACKETS AND 5/8" DIAMETER HUS-H HILTI SCREW ANCHORS, SPAN ACROSS BEAMS AS REQUIRED.

ELECTRICAL CONTRACTOR'S BASE BID PRICE SHALL INCLUDE FOUR (4) HOURS OF ON SITE COORDINATION TIME WITH CLIENT AND CONSULTANT PRIOR TO ORDERING OVERHEAD CABLE TRAY COMPONENTS TO FINALIZE ROUTING, LOCATIONS AND HEIGHTS OF OVERHEAD CABLE TRAY SYSTEMS. ALL CHANGES TO BE REVIEWED AND APPROVED BY CONSULTANT ON SITE PRIOR TO EXECUTION.


№—1) PROVIDE CABLE TRAY SYSTEMS, FITTINGS, ACCESSORIES, ETC. AS REQUIRED FOR COMPLETE AND FUNCTIONING SYSTEMS.

 $\sqrt[6]{-12}$ Provide splice hardware to bolt all cable tray sections together.

√13 MOUNT RECEPTACLES INDICATED 6" ABOVE CABINET CO1.

√14) MOUNT RECEPTACLES INDICATED 6" ABOVE CABINET CO2.

AS PART OF THIS SCOPE OF WORK FEED AC-1 THROUGH CONDENSER CU-1. PROVIDE CONDUIT AND POWER AND CONTROL WIRING AS PART OF THIS SCOPE OF WORK. COORDINATE EXACT REQUIREMENTS ON SITE WITH MECHANICAL CONTRACTOR.

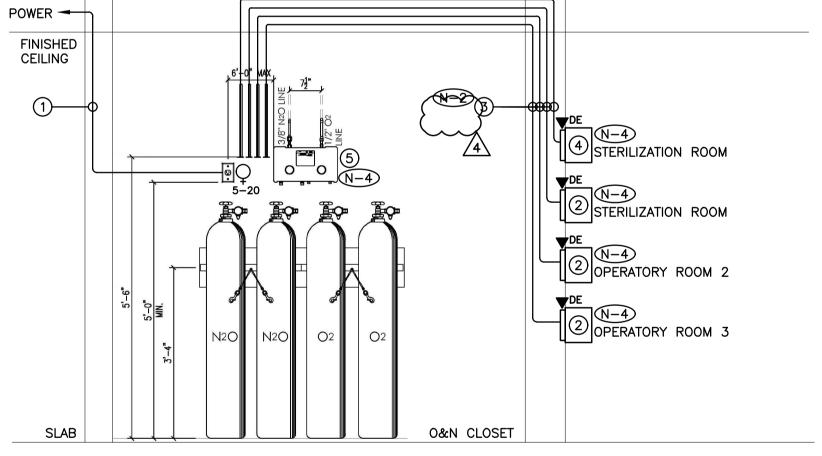

N-1) EXACT LOCATION OF ALL DEVICES AND RESPECTIVE HEIGHTS TO BE COORDINATED ON SITE WITH DENTAL EQUIPMENT CONTRACTOR.

N-2) PROVIDE NYLON INSULATED THROATS FOR ALL BUSHINGS AND CONNECTORS.

N-3) PROVIDE DEDICATED CORE DRILLED WALL AND FLOOR PENETRATIONS ON EVERY FLOOR. EXACT LOCATION OF ALL CORE DRILLS TO BE DETERMINED BY X-RAY RESULTS. ALL X-RAYS MUST BE REVIEWED AND APPROVED BY LANDLORD PRIOR TO CORE DRILLING.

(N-4) COORDINATE CONDUIT TERMINATION REQUIREMENTS ON SITE WITH DENTAL

(1) TYPICAL BRANCH CIRCUIT PROVIDE AS PART OF THIS SCOPE OF WORK

(2) ALARM PANEL PROVIDED BY DENTAL EQUIPMENT CONTRACTOR

(3) 3/4" CONDUIT C/W ONE (1) CAT6 CABLE, BUSHINGS AND RUBBERIZED GROMMETS FOR DENTAL EQUIPMENT CONTRACTOR'S USE PROVIDED AS PART OF THIS SCOPE OF WORK

(4) MEDICAL GASES EMERGENCY SHUT OFF PROVIDED BY DENTAL EQUIPMENT

CONTRACTOR (5) MEDICAL GASES SYSTEM MANIFOLD PROVIDED BY DENTAL EQUIPMENT

CONTRACTOR SCALE: NTS Æ-006\

MEDICAL GASES SYSTEM ELECTRICAL REQUIREMENT DETAIL

IT/ELECTRICAL ROOM DETAIL E-006/ SCALE: 1:50

BY ELECTRICAL CONTRACTOR

PART OF THIS SCOPE OF WORK

(4) NOT USED

TODS

(6) (6) (9) x 4 [□] D-52

(1) EQUIPMENT CABINET PROVIDED BY COMMUNICATIONS CONTRACTOR

(2) 18"W LADDER TYPE CABLE TRAY WITH 12" RUNG SPACING - TYPE UNIVERSAL CABLE

CONTRACTOR'S USE PROVIDED AS PART OF THIS SCOPE OF WORK. PROVIDE CPI

(3) 8'W X 8)H X 3/4"D FIRE RATED PLYWOOD BACKBOARD FOR COMMUNICATIONS AND

(5) SECURITY SYSTEM ACCESS CONTROL PANEL PROVIDED AS PART OF THIS SCOPE OF

(6) FIRE ALARM SYSTEM BOOSTER PANEL PROVIDED AS PART OF THIS SCOPE OF WORK

4 8 STRINGER RADIUS DROP

(1) INTRUSION SYSTEM CONTROL PANEL ZONE EXPANDER C/W ENCLOSURE PROVIDED AS

 $oldsymbol{ol}oldsymbol{ol}ol{oldsymbol{ol}}}}}}}}}}}}}}}}}}}}}}$

(9) TIME CLOCK FOR EXHAUST FANS SUPPLIED BY MECHANICAL CONTRACTOR AND INSTALLED $^{
m l}$

<u>*</u>

(7) ELECTRIC STRIKE POWER SUPPLY PROVIDED AS PART OF THIS SCOPE OF WORK

SECURITY CONTRACTORS' USE. PAINT BACKBOARD WITH FIRE RETARDANT PAINT. MATCH TO COLOUR AS DIRECTED ON SITE BY ARCHITECT. FIRE RATED STAMP MUST BE ON ALL

PIECES PROVIDED AND MUST BE VISIBLE WHEN INSTALLED. DO NOT PAINT OVER STAMP.

RUNWAY AS MANUFACTURED BY CPI, BLACK IN COLOUR FOR COMMUNICATIONS


D-54/56/58/60

 $\sqrt{4}$ PROTECTIVE END CAPS. MOUNT CABLE TRAY AT 8'-0" AFF.

CO1 (8)


- N-1) EXACT LOCATION OF ALL DEVICES AND RESPECTIVE HEIGHTS TO BE COORDINATED ON SITE WITH DENTAL EQUIPMENT CONTRACTOR.
- N-2) PROVIDE NYLON INSULATED THROATS FOR ALL BUSHINGS AND CONNECTORS.
- N-3 PROVIDE DEDICATED CORE DRILLED WALL AND FLOOR PENETRATIONS ON EVERY FLOOR. EXACT LOCATION OF ALL CORE DRILLS TO BE DETERMINED BY X-RAY RESULTS. ALL X-RAYS MUST BE REVIEWED AND APPROVED BY LANDLORD PRIOR TO CORE DRILLING.
- N-4 COORDINATE CONDUIT TERMINATION REQUIREMENTS ON SITE WITH DENTAL EQUIPMENT CONTRACTOR.
- N-5 LOW VOLTAGE CABLES, WIRING AND TERMINATIONS PROVIDED BY DENTAL EQUIPMENT CONTRACTOR.
- (1) TYPICAL BRANCH CIRCUIT PROVIDE AS PART OF THIS SCOPE OF WORK
- 2 NOT USED
- (3) 3/4" CONDUIT C/W BUSHINGS AND RUBBERIZED GROMMETS FOR DENTAL EQUIPMENT CONTRACTOR'S USE PROVIDED AS PART OF THIS SCOPE OF WORK
- (4) X-RAY CONTROL BOX PROVIDED BY OTHERS



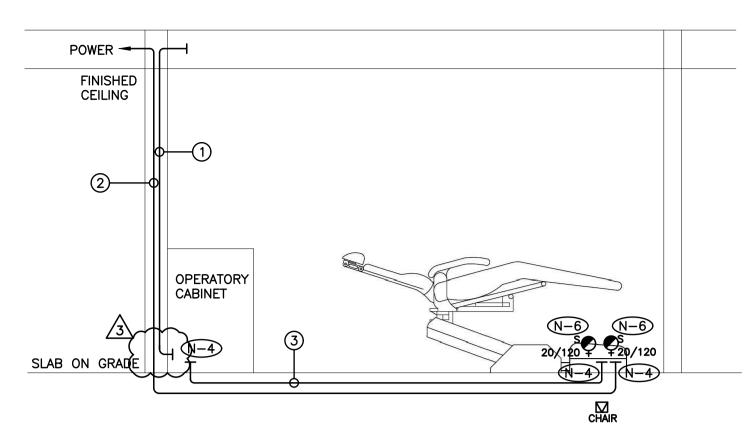

- N-1) EXACT LOCATION OF ALL DEVICES AND RESPECTIVE HEIGHTS TO BE COORDINATED ON SITE WITH DENTAL EQUIPMENT CONTRACTOR.
- N-2 PROVIDE NYLON INSULATED THROATS FOR ALL BUSHINGS AND CONNECTORS.
- N-3) SAW CUTTING OF FLOOR SLAB PROVIDED BY ELECTRICAL CONTRACTOR. EXACT ROUTING TO BE DETERMINED BY SCANNING/X-RAY RESULTS. SUBMIT LAYOUT C/W CONDUIT SIZES TO ELECTRICAL CONSULTANT FOR APPROVAL PRIOR TO CUTTING OF FLOOR SLAB.
- N-4 COORDINATE CONDUIT TERMINATION REQUIREMENTS ON SITE WITH DENTAL EQUIPMENT CONTRACTOR.
- N-5 LOW VOLTAGE CABLES, WIRING AND TERMINATIONS PROVIDED BY DENTAL EQUIPMENT CONTRACTOR.
- N-6 CONFIRM RECEPTACLE MOUNTING STYLE AND LOCATION ON SITE WITH DENTAL EQUIPMENT CONTRACTOR.
- (1) 2" CONDUIT C/W PULL STRING FOR DENTAL EQUIPMENT CONTRACTOR'S USE
- (2) TYPICAL BRANCH CIRCUIT PROVIDE AS PART OF THIS SCOPE OF WORK
- 3 2" DIRECT BURIED CONDUIT C/W PULL STRING FOR DENTAL EQUIPMENT CONTRACTOR'S USE

DENTIST CHAIR ELECTRICAL REQUIREMENT DETAIL SCALE: NTS

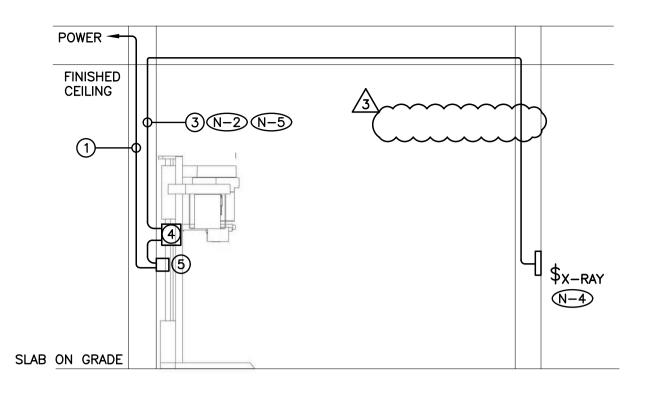

- N-1) EXACT LOCATION OF ALL DEVICES AND RESPECTIVE HEIGHTS TO BE COORDINATED ON SITE WITH DENTAL EQUIPMENT CONTRACTOR.
- N-2 PROVIDE NYLON INSULATED THROATS FOR ALL BUSHINGS AND CONNECTORS.
- N-3 PROVIDE DEDICATED CORE DRILLED WALL AND FLOOR PENETRATIONS ON EVERY FLOOR. EXACT LOCATION OF ALL CORE DRILLS TO BE DETERMINED BY X-RAY RESULTS. ALL X-RAYS MUST BE REVIEWED AND APPROVED BY LANDLORD PRIOR TO CORE DRILLING.
- N-4 COORDINATE CONDUIT TERMINATION REQUIREMENTS ON SITE WITH DENTAL EQUIPMENT CONTRACTOR.
- N-5 LOW VOLTAGE CABLES, WIRING AND TERMINATIONS PROVIDED BY DENTAL EQUIPMENT CONTRACTOR.
- (1) TYPICAL BRANCH CIRCUIT PROVIDE AS PART OF THIS SCOPE OF WORK
- 2 NOT USED

AIN CO-X-RAY

X—RAY


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- (3) 3/4" CONDUIT C/W BUSHINGS AND RUBBERIZED GROMMETS FOR DENTAL EQUIPMENT CONTRACTOR'S USE PROVIDED AS PART OF THIS SCOPE OF WORK
- (4) X-RAY CONTROL BOX PROVIDED BY OTHERS
- 5 BUCK & BOOST TRANSFORMER SUPPLIED BY DENTAL EQUIPMENT CONTRACTOR AND INSTALLED BY ELECTRICAL CONTRACTOR AS PART OF THIS SCOPE OF



ALL MEASUREMENTS ARE TO BE VERIFIED BY THE CONTRACTOR ON SITE AND ANY DISCREPANCIES ARE TO BE REPORTED BEFORE PROCEEDING WITH THE WORK. THE REGION OF DURHAM ASSUMES NO RESPONSIBILITY FOR THE ACCURACY OF THE LOCATION OF EXISTING SERVICES AS INDICATED ON THIS DRAWING. DO NOT SCALE DRAWINGS.





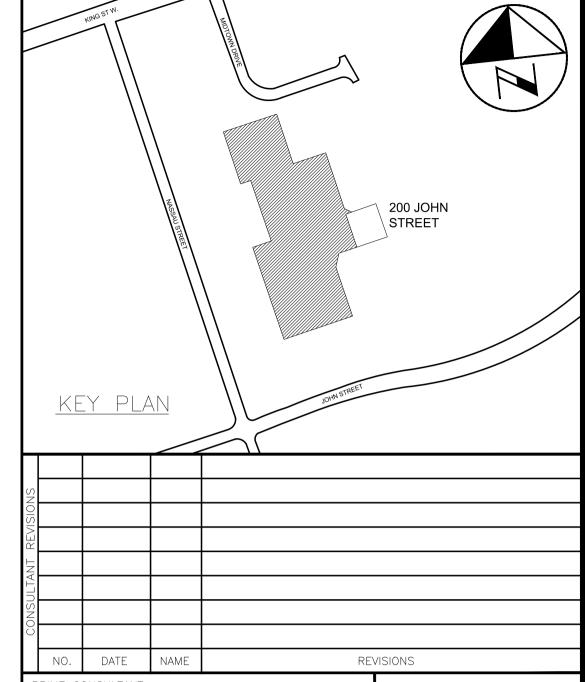


SUB-CONSULTANT

HCC ENGINEERING DESIGN AND TECHNOLOGY SERVICES GROUP HCC ENGINEERING LIMITED 40 EGLINTON AVENUE EAST, SUITE 600

TORONTO, ONTARIO, M4P 3A2

Tel: (416) 932-2423

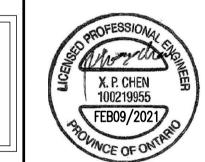

HCC Project No.: 20104

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X-RAY N-4 120V/ B-10 120V/ 20/120

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THE REGIONAL MUNICIPALITY OF DURHAM

WORKS DEPARTMENT

DESIGN, CONSTRUCTION & ASSET MANAGEMENT

RELOCATION OF DENTAL CLINIC TO 200 JOHN ST., OSHAWA

ELECTRICAL DETAILS

roperty no. I/A	facility code LEA-0-07	facilities project no. LEA-0-07-19-0
ONTRACT NO.	DRAWING NO.	SHEET NO.
-1032-2021	E-007	040

(N-1) EXACT LOCATION OF ALL DEVICES AND RESPECTIVE HEIGHTS TO BE COORDINATED ON SITE N-2 NEATLY LABEL ALL FLOOR MOUNTED AND WALL DEVICE BOX COVERS WITH CORRESPONDING PANEL NAMES AND CIRCUIT NUMBERS. UTILIZE SELF ADHESIVE MECHANICALLY PRINTED

N-3 CIRCUIT NUMBERS MAY NOT BE CHANGED WITHOUT PRIOR APPROVAL FROM THE ELECTRICAL

N-4 CONFIRM BREAKER AND RECEPTACLE REQUIREMENTS PRIOR TO ORDERING DISTRIBUTION.

N-5 ROUTE ALL CONDUIT SYSTEMS AROUND BEAMS, DUCT WORK AND PIPING AS REQUIRED TO ACCOMMODATE INSTALLATION. REFER TO MECHANICAL DRAWINGS AND DESIGNER DRAWINGS FOR ADDITIONAL DETAILS.

N-6 MINIMUM WIRE SIZE #10AWG FOR ALL 120 VOLT CIRCUITS EXCEEDING 90 FEET IN LENGTH. N-7 MINIMUM WIRE SIZE #8AWG FOR ALL 120 VOLT CIRCUITS EXCEEDING 200 FEET IN LENGTH. N-8 NOT USED.

N-9 SAW CUTTING OF FLOOR SLAB PROVIDED BY ELECTRICAL CONTRACTOR. EXACT ROUTING TO BE DETERMINED BY SCANNING/X-RAY RESULTS. SUBMIT LAYOUT C/W CONDUIT SIZES TO ELECTRICAL CONSULTANT FOR APPROVAL PRIOR TO CUTTING OF FLOOR SLAB.

(V-10) CONNECT 220 VOLT XRAY MACHINE TO 208V CIRCUIT UTILIZING BUCK & BOOST TRANSFORMER. TRANSFORMER TO BE SUPPLIED BY DENTAL EQUIPMENT CONTRACTOR AND INSTALLED BY ELECTRICAL CONTRACTOR. PROVIDE PRIMARY AND SECONDARY WIRING.

(1) APPROXIMATE LOCATION TO TRANSITION SERVICES FROM FLOOR SLAB TO CEILING SPACE.

ALL WIRING, DEVICES AND EQUIPMENT WITHIN OPERATORY ROOMS MUST COMPLY WITH ONTARIO ELECTRICAL SAFETY CODE SECTION 24.

OPERATORY ROOMS ARE PATIENT CARE AREAS. LEVEL OF CARE IS

PLUG LOAD CONTROL NOT SPECIFIED FOR OPERATORY EQUIPMENT / AV EQUIPMENT / TV'S AS THIS CAN DAMAGE EQUIPMENT.

PROVIDE A DEDICATED GREEN INSULATED COPPER GROUND WIRE FOR EACH RECEPTACLE, DEVICE, LIGHT SWITCH, ETC., IN PATIENT CARE AREAS, OPERATORIES, ETC..


FLOOR SLAB. REFER TO DETAIL NO. 2 ON DRAWING NO. E-007 FOR ADDITIONAL REQUIREMENTS.




OPERATORY ELECTRICAL PLAN

SCALE: 1:50

1.0KW N-4 1.0KW N-4 208V/1PHy B-57/59 B-2 20/120 $\bigcirc 20/120$ E-007

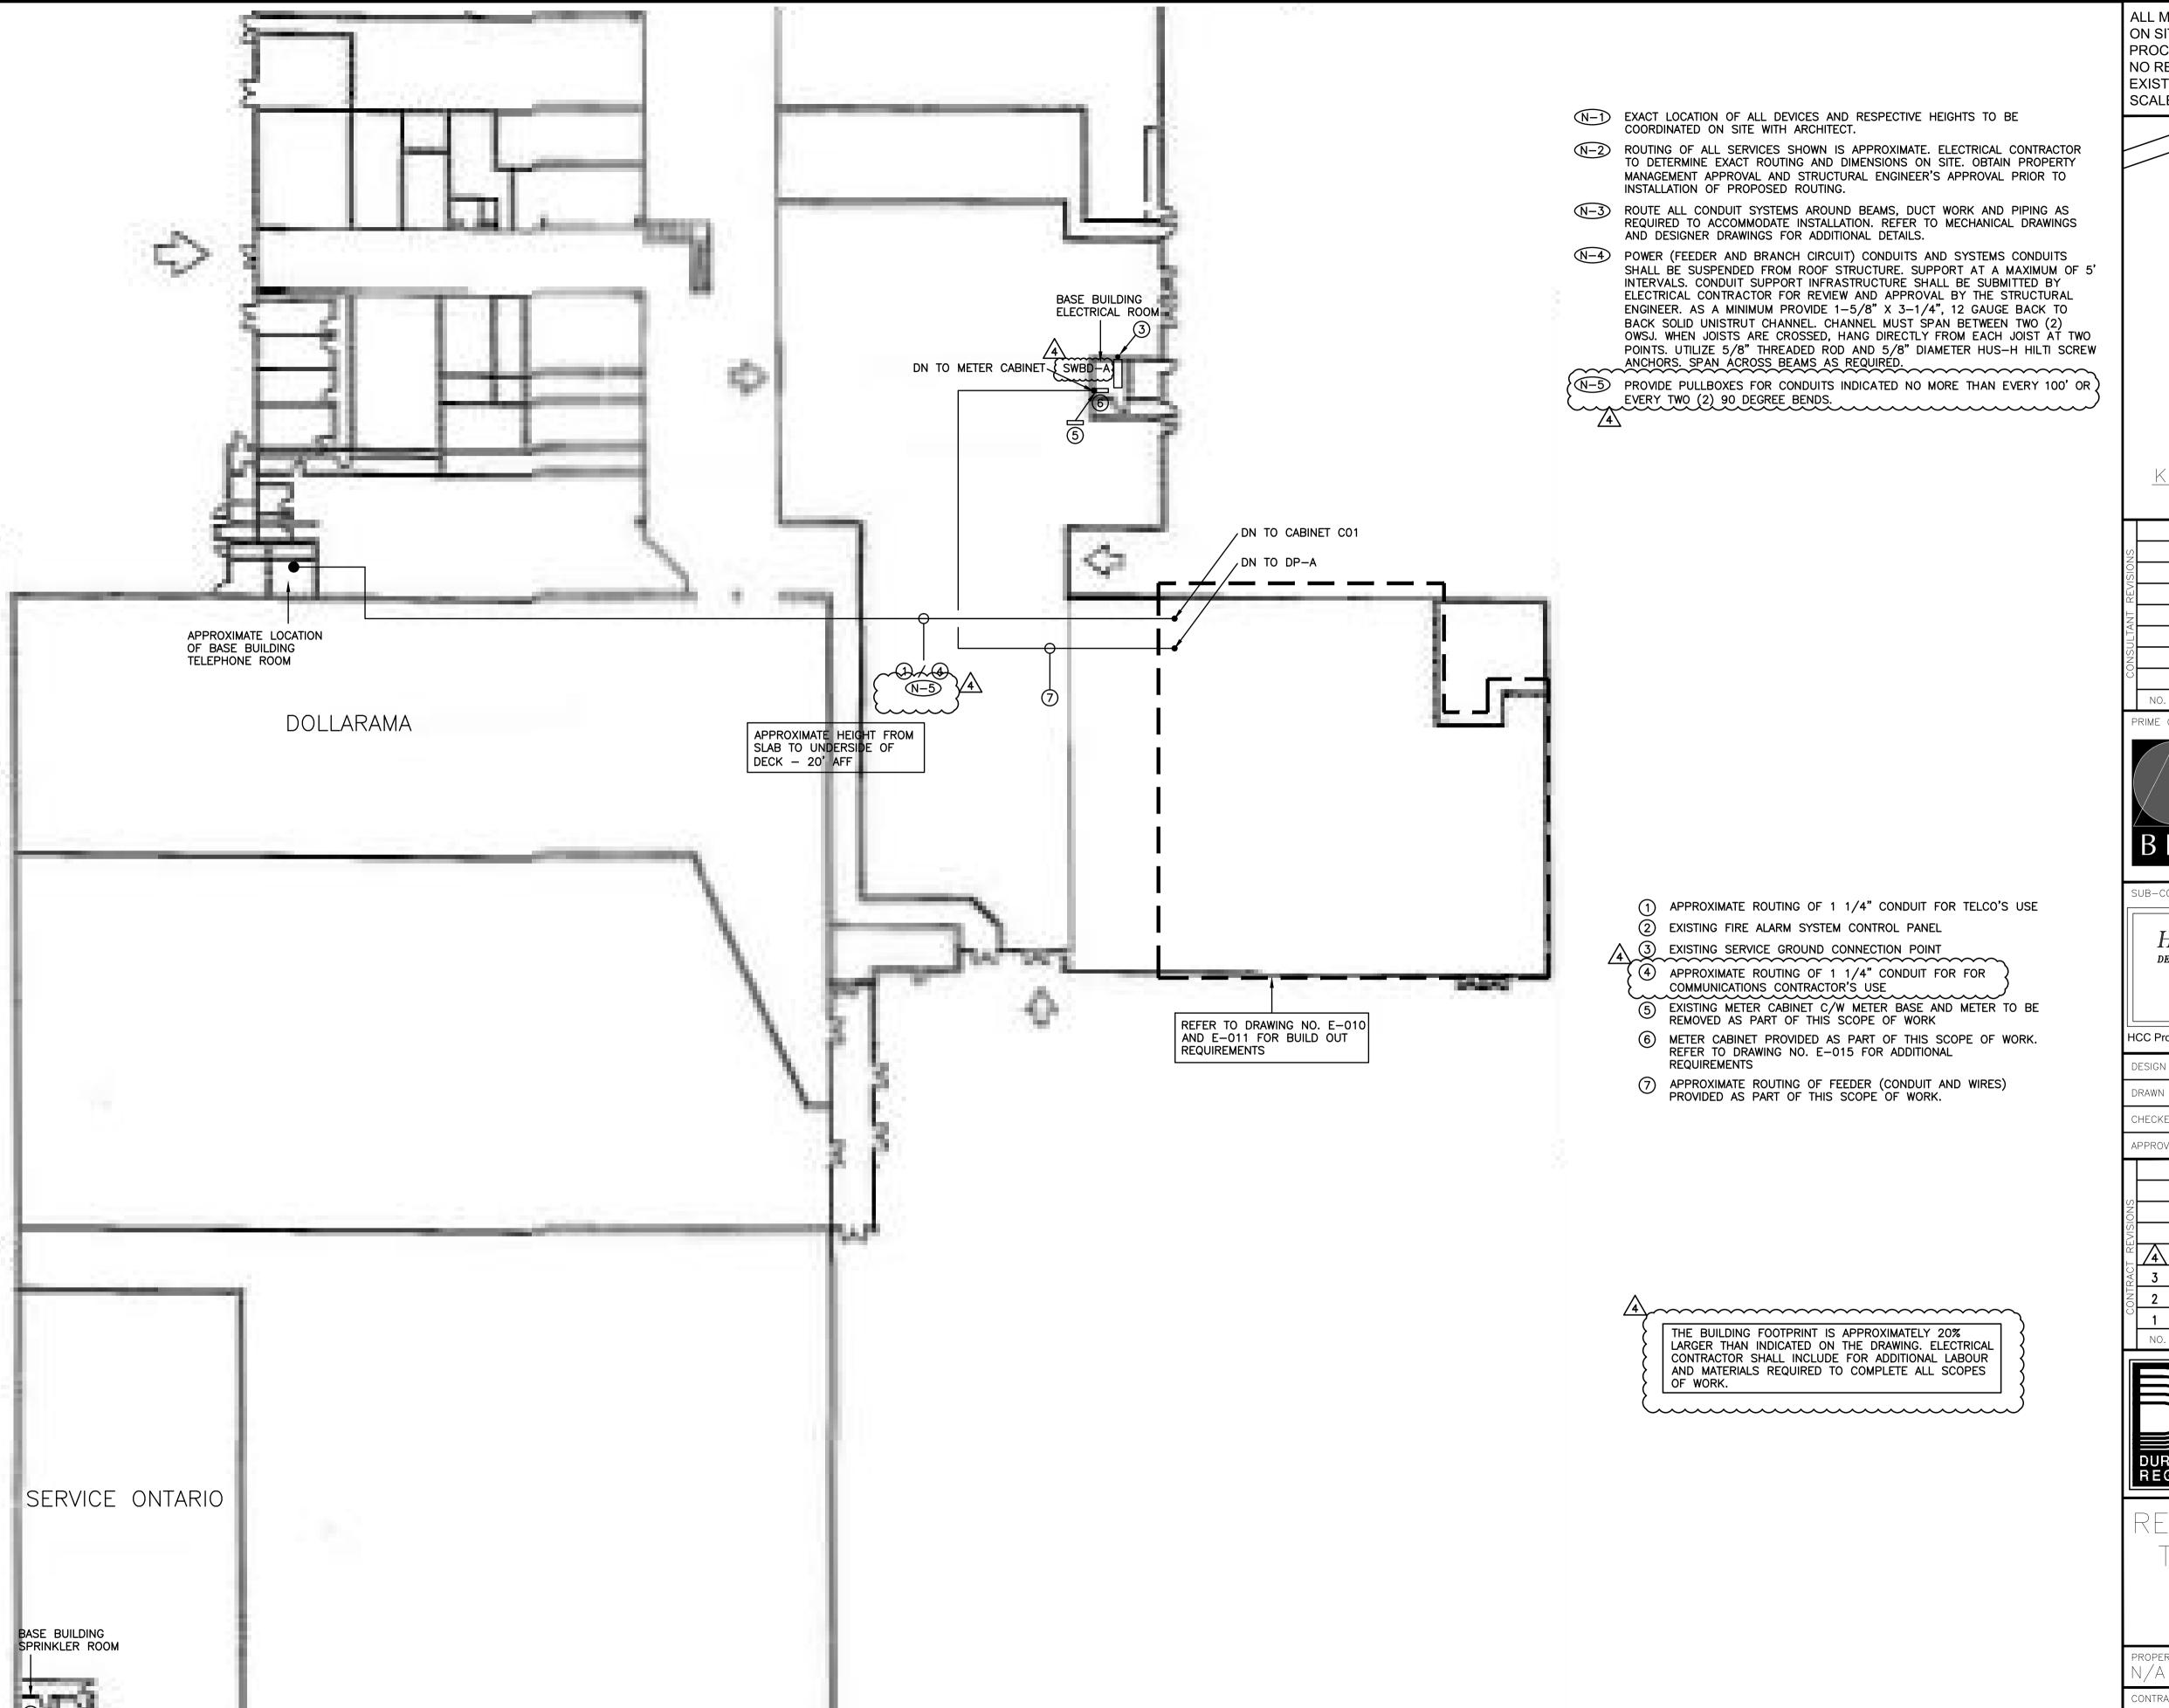

ALL MEASUREMENTS ARE TO BE VERIFIED BY THE CONTRACTOR ON SITE AND ANY DISCREPANCIES ARE TO BE REPORTED BEFORE PROCEEDING WITH THE WORK. THE REGION OF DURHAM ASSUMES NO RESPONSIBILITY FOR THE ACCURACY OF THE LOCATION OF EXISTING SERVICES AS INDICATED ON THIS DRAWING. DO NOT SCALE DRAWINGS.

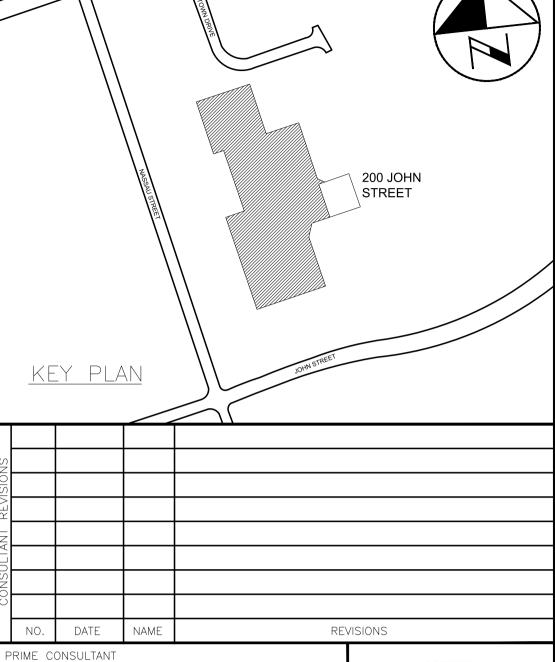

ASSOCIATES Project Managers Suite 201 Whitby, Ontario L1N 0G5 Tel: (905) 666-5252 Fax: (905) 666-5256 e-mail: bba@bba-archeng.com



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HCC ENGINEERING LIMITED 40 EGLINTON AVENUE EAST, SUITE 600 TORONTO, ONTARIO, M4P 3A2 Tel: (416) 932-2423



HCC Project No.: 20104

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	DRAWN BY: TLR			DATE: 2020-05-01	
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THE REGIONAL MUNICIPALITY OF DURHAM


WORKS DEPARTMENT

DESIGN, CONSTRUCTION & ASSET MANAGEMENT


RELOCATION OF DENTAL CLINIC TO 200 JOHN ST., OSHAWA

ELECTRICAL FACILITY PLAN

property no. N/A	facility code LEA-0-07	FACILITIES PROJECT NO. LEA-0-07-19-01
CONTRACT NO.	DRAWING NO.	SHEET NO.
T-1032-2021	E-008	041

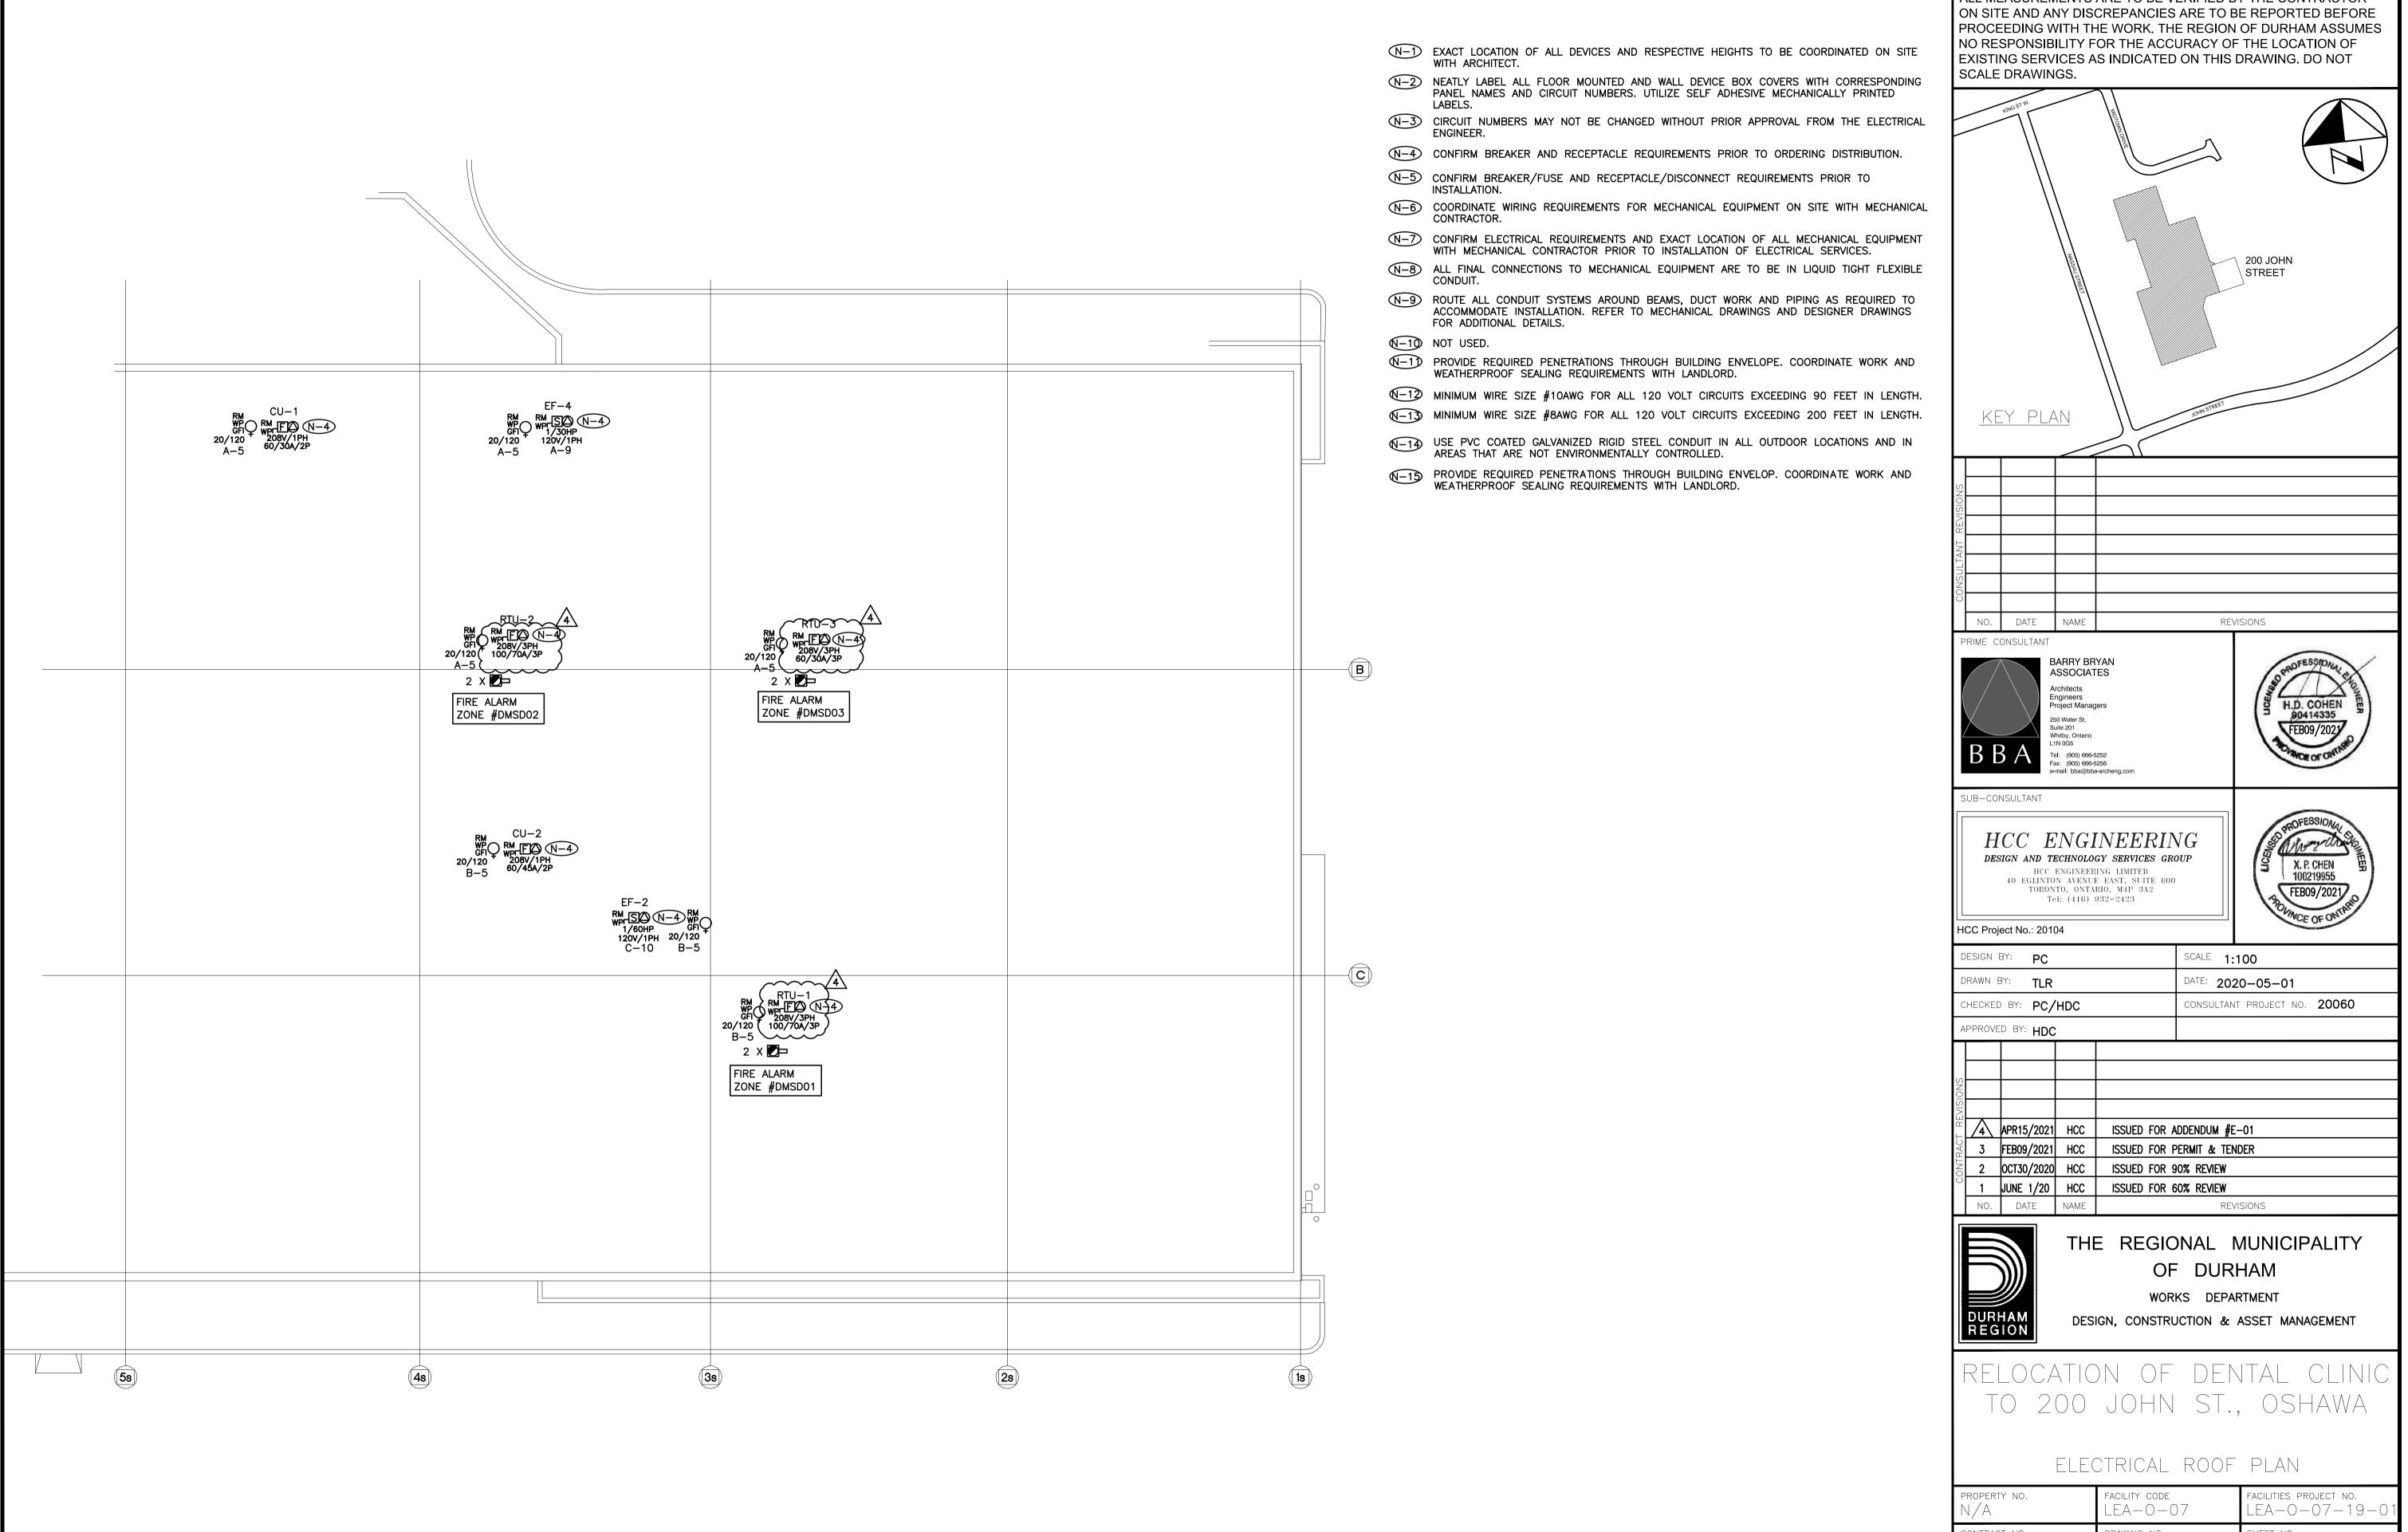

ALL MEASUREMENTS ARE TO BE VERIFIED BY THE CONTRACTOR ON SITE AND ANY DISCREPANCIES ARE TO BE REPORTED BEFORE PROCEEDING WITH THE WORK. THE REGION OF DURHAM ASSUMES NO RESPONSIBILITY FOR THE ACCURACY OF THE LOCATION OF EXISTING SERVICES AS INDICATED ON THIS DRAWING. DO NOT

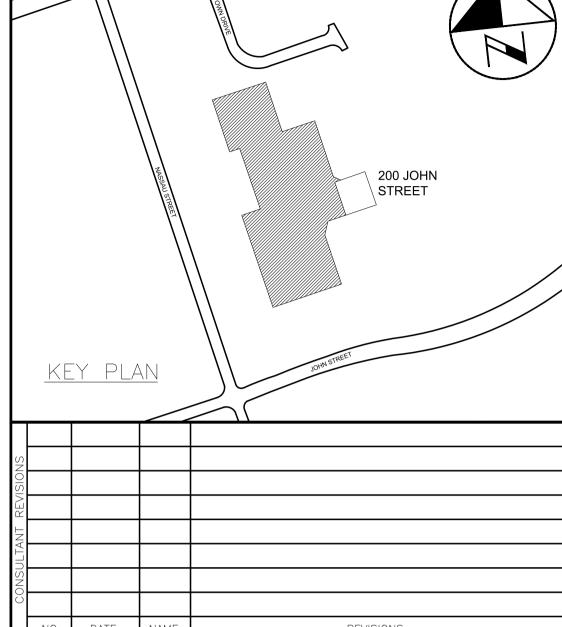



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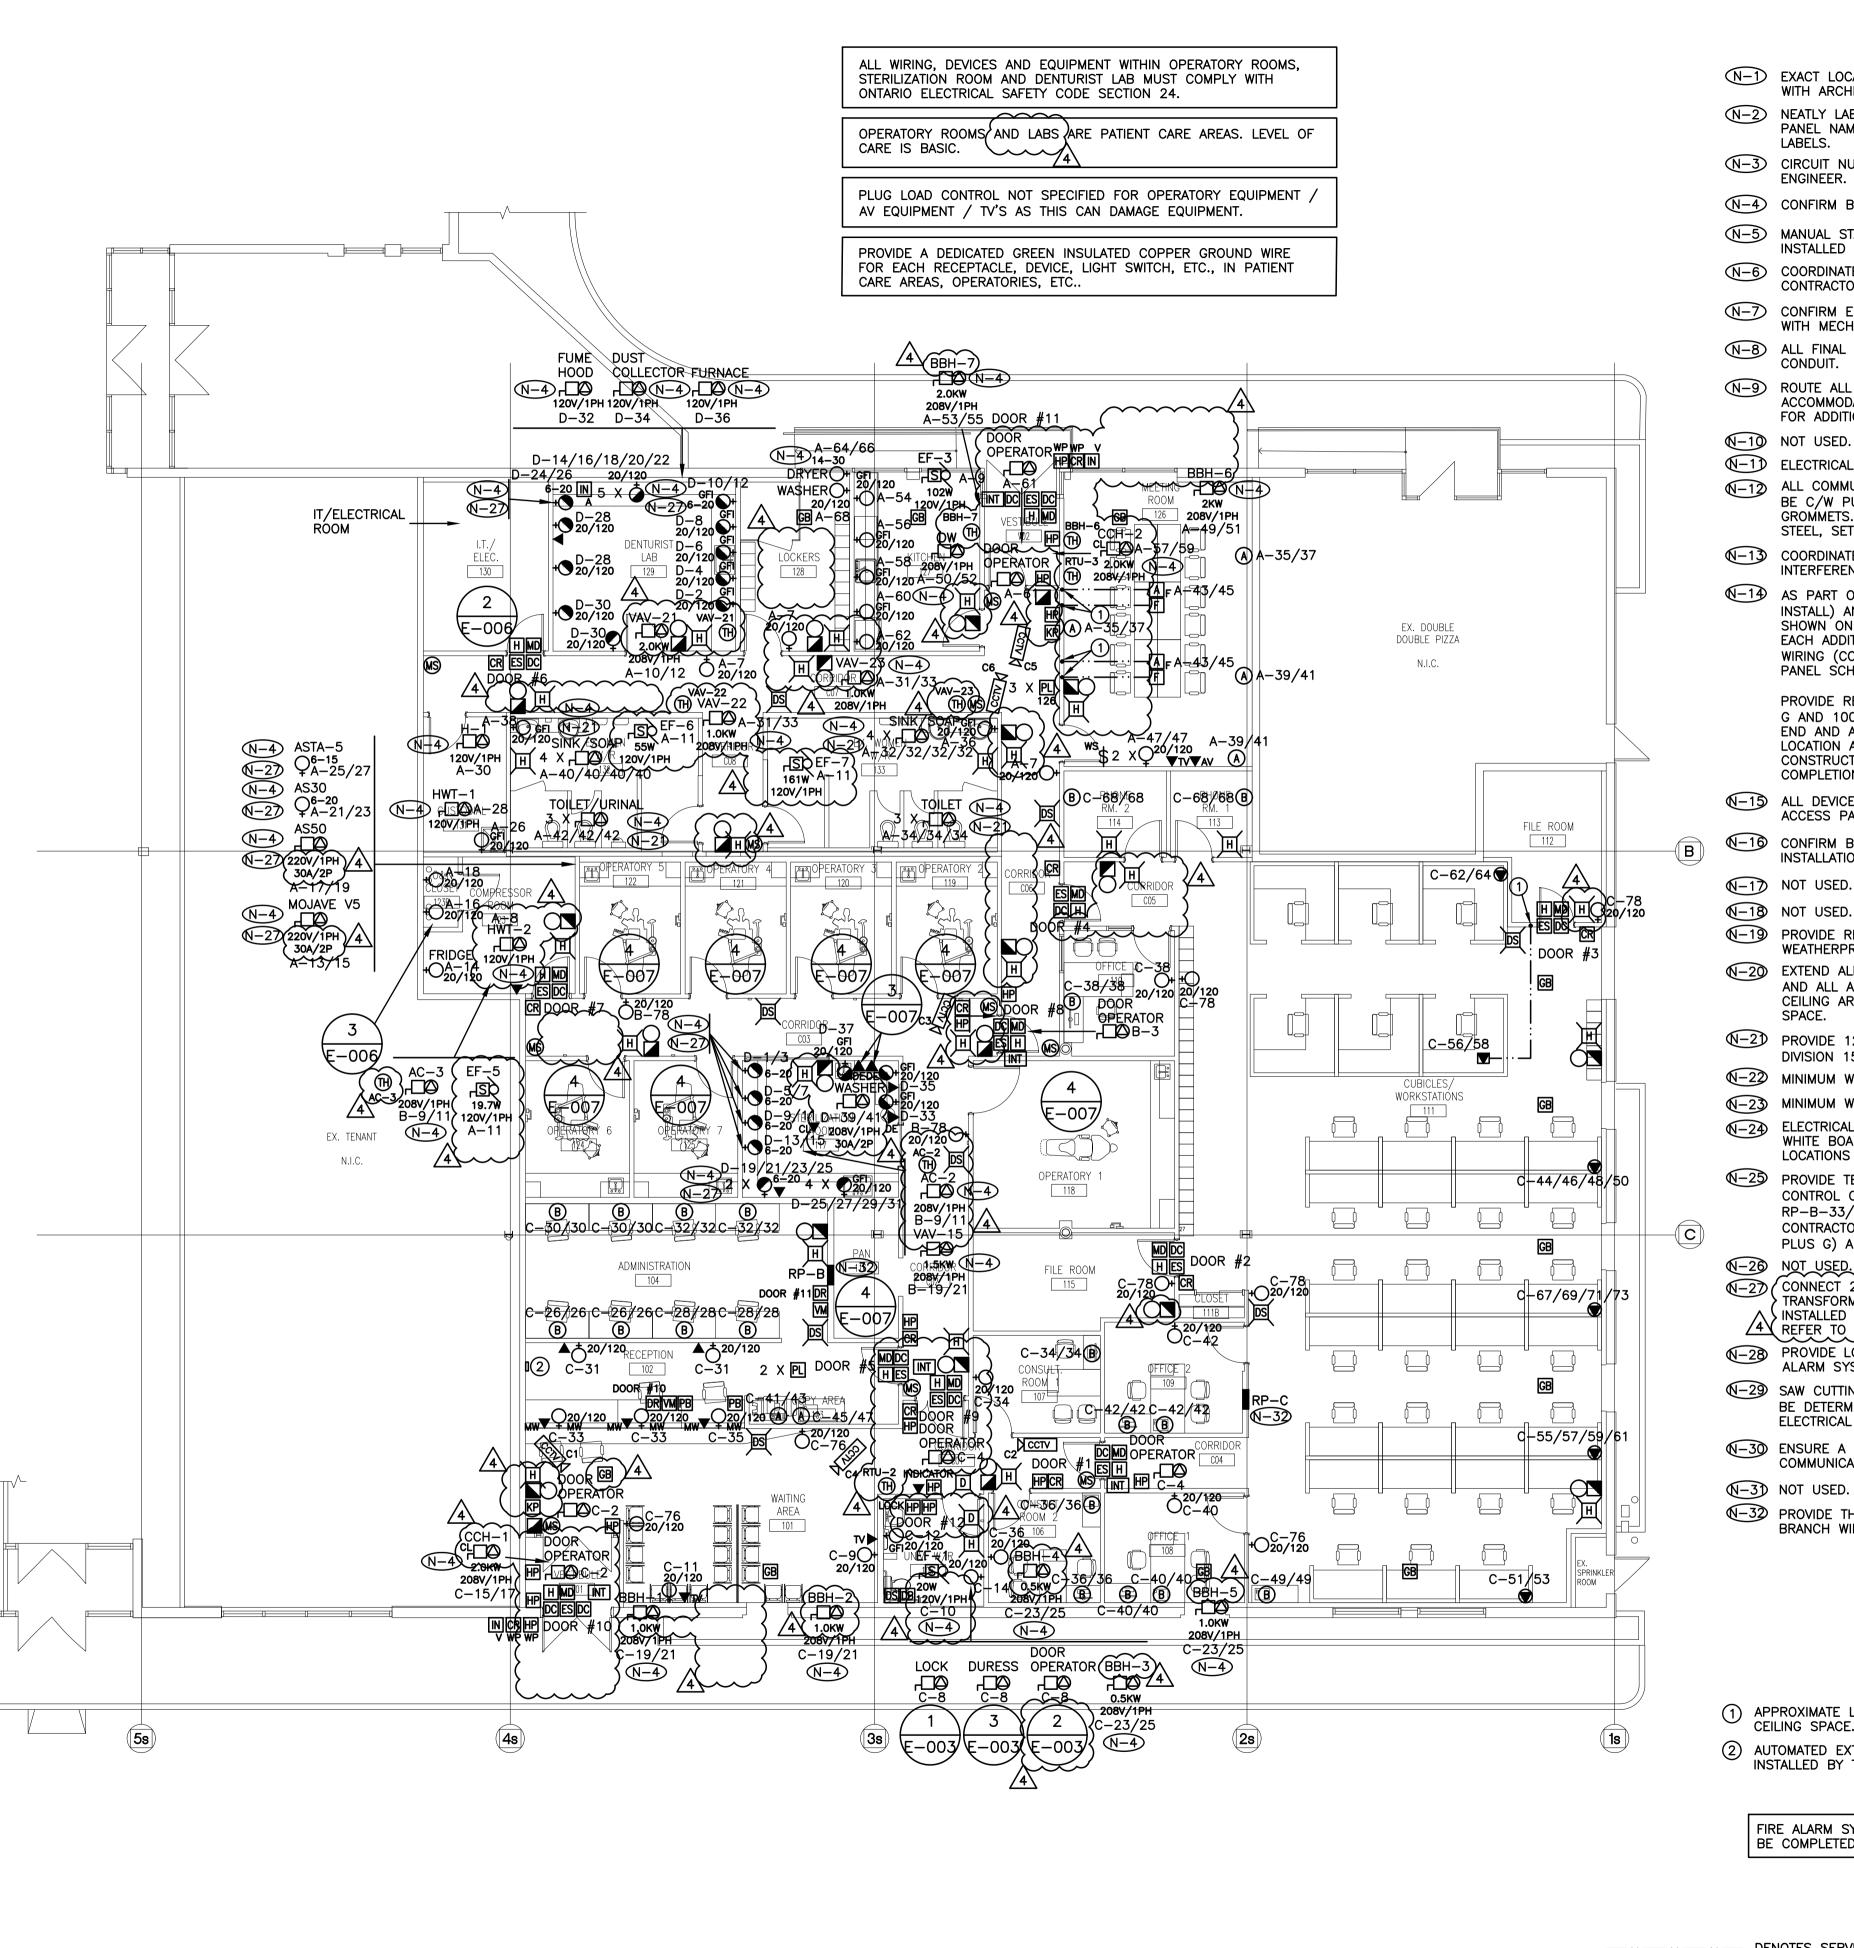
THE REGIONAL MUNICIPALITY

WORKS DEPARTMENT

TO 200 JOHN ST., OSHAWA

ELECTRICAL	ROOF	PLAN
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PROPERTY NO. N/A		FACILITIES PROJECT NO. LEA-0-07-19-01
CONTRACT NO.	DRAWING NO.	SHEET NO.
T-1032-2021	E-009	042



- N-1) EXACT LOCATION OF ALL DEVICES AND RESPECTIVE HEIGHTS TO BE COORDINATED ON SITE
- N-2 NEATLY LABEL ALL FLOOR MOUNTED AND WALL DEVICE BOX COVERS WITH CORRESPONDING PANEL NAMES AND CIRCUIT NUMBERS. UTILIZE SELF ADHESIVE MECHANICALLY PRINTED
- CIRCUIT NUMBERS MAY NOT BE CHANGED WITHOUT PRIOR APPROVAL FROM THE ELECTRICAL ENGINEER.
- N-4) CONFIRM BREAKER AND RECEPTACLE REQUIREMENTS PRIOR TO ORDERING DISTRIBUTION.
- N-5 MANUAL STARTER SWITCH/THERMOSTAT SUPPLIED BY MECHANICAL CONTRACTOR AND INSTALLED BY ELECTRICAL CONTRACTOR. PROVIDE CONDUIT AND WIRE.
- N-6 COORDINATE WIRING REQUIREMENTS FOR MECHANICAL EQUIPMENT ON SITE WITH MECHANICAL
- N-7 CONFIRM ELECTRICAL REQUIREMENTS AND EXACT LOCATION OF ALL MECHANICAL EQUIPMENT WITH MECHANICAL CONTRACTOR PRIOR TO INSTALLATION OF ELECTRICAL SERVICES.
- N-8 ALL FINAL CONNECTIONS TO MECHANICAL EQUIPMENT ARE TO BE IN LIQUID TIGHT FLEXIBLE CONDUIT.
- ROUTE ALL CONDUIT SYSTEMS AROUND BEAMS, DUCT WORK AND PIPING AS REQUIRED TO ACCOMMODATE INSTALLATION. REFER TO MECHANICAL DRAWINGS AND DESIGNER DRAWINGS FOR ADDITIONAL DETAILS.
- $\sqrt{10}$ NOT USED.
- №1) ELECTRICAL CONTRACTOR SHALL NOT USE PULLBOXES AS SUBSTITUTES FOR 90° BENDS.
- $\widehat{\mathbb{N}-12}$ ALL COMMUNICATIONS SYSTEM ZONE CONDUITS PROVIDED BY ELECTRICAL CONTRACTOR SHALL BE C/W PULL STRING. ALL CONDUITS SHALL BE C/W BUSHINGS AND RUBBERIZED GROMMETS. ALL CONDUITS TO BE EMT. EMT COUPLING AND CONNECTORS SHALL BE T&B STEEL, SET SCREW TYPE.
- √13 COORDINATE CONDUIT TERMINATION WITH LIGHTING INSTALLATION AND MECHANICAL INTERFERENCES TO ENSURE ACCESS FOR COMMUNICATIONS CONTRACTOR.
- № AS PART OF THE BASE BID PRICE ELECTRICAL CONTRACTOR SHALL PROVIDE (SUPPLY AND INSTALL) AN ADDITIONAL SIX (6) CSA 5-20R DUPLEX RECEPTACLES OVER AND ABOVE THOSE SHOWN ON DRAWING NO. E-010 ON AN AD HOC BASIS UP TO SUBSTANTIAL COMPLETION. EACH ADDITIONAL RECEPTACLE SHALL BE ON A DEDICATED CIRCUIT COMPLETE WITH BRANCH WIRING (CONDUIT AND WIRE) AND BREAKER. BREAKER REQUIREMENTS NOT INDICATED ON PANEL SCHEDULES.

PROVIDE RECEPTACLES, CONDUIT, WIRE (100' OF 2#10AWG + G (TOTAL OF 200' WIRE PLUS G AND 100' 3/4" CONDUIT) PER RECEPTACLE), BREAKERS, TERMINATION AT PANEL BREAKER END AND AT DEVICE END, ETC. FOR FULLY FUNCTIONAL LIVE DEVICES. EXACT INSTALLATION LOCATION AND PANEL SOURCE TO BE DETERMINED ON SITE BY CLIENT DURING CONSTRUCTION. PROVIDE UPDATED TYPED PANEL SCHEDULES FOR ALL PANELS AT THE COMPLETION OF THE PROJECT.


- N−15 ALL DEVICES, FIXTURES, FIRE ALARM DEVICES, SYSTEMS, ETC. MUST BE WIRED SUCH THAT ACCESS PANELS ARE NOT REQUIRED IN DRYWALL CEILING AREAS.
- €-16 CONFIRM BREAKER/FUSE AND RECEPTACLE/DISCONNECT REQUIREMENTS PRIOR TO INSTALLATION.
- $(\sqrt{-1})$ NOT USED.
- №-19 PROVIDE REQUIRED PENETRATIONS THROUGH BUILDING ENVELOPE. COORDINATE WORK AND WEATHERPROOF SEALING REQUIREMENTS WITH LANDLORD.
- €-20 EXTEND ALL COMMUNICATIONS ZONE CONDUITS PROVIDED AS PART OF THIS SCOPE OF WORK AND ALL A/V ZONE CONDUITS PROVIDED AS PART OF THIS SCOPE OF WORK IN EXPOSED CEILING AREAS AND DRYWALL CEILING AREAS TO T-BAR CEILING AREAS WITHIN TENANT
- N-2) PROVIDE 120/24V TRANSFORMER FOR EACH APPLIANCE SENSOR (SENSOR PROVIDED BY
- € MINIMUM WIRE SIZE #10AWG FOR ALL 120 VOLT CIRCUITS EXCEEDING 90 FEET IN LENGTH.
- № MINIMUM WIRE SIZE #8AWG FOR ALL 120 VOLT CIRCUITS EXCEEDING 200 FEET IN LENGTH.
- ELECTRICAL CONTRACTOR TO ENSURE THAT DEVICES ARE NOT INSTALLED ON WALLS WITH WHITE BOARDS OR ON FEATURE WALLS. CONFIRM ALL WHITE BOARD AND FEATURE WALL LOCATIONS PRIOR TO INSTALLATION.
- №-25 PROVIDE TEN (10) DUPLEX RECEPTACLES IN CEILING SPACE ON AN AD HOC BASIS FOR CONTROL CONTRACTOR'S USE. UTILIZE CCTS #RP-A-76/78/80/82/84 AND RP-B-33/35/37/39/41. COORDINATE LOCATION OF RECEPTACLES ON SITE WITH CONTROLS CONTRACTOR. BID PRICE SHALL INCLUDE FOR 100' OF 2#10AWG + G (TOTAL OF 200' WIRE PLUS G) AND 100' 3/4" CONDUIT PER CONTROL CIRCUIT.
- NOT USED.

 CONNECT 220 VOLT DEVICES TO 120/208V CIRCUITS UTILIZING BUCK & BOOST

 TRANSFORMERS. TRANSFORMERS TO BE SUPPLIED BY DENTAL EQUIPMENT CONTRACTOR AND INSTALLED BY ELECTRICAL CONTRACTOR. PROVIDE ALL PRIMARY AND SECONDARY WIRING.
- REFER TO DRAWING NO. E-007 FOR ADDITIONAL REQUIREMENTS. N-28 PROVIDE LOCKONS FOR BREAKERS PROTECTING EMERGENCY LIGHTING CIRCUITS AND FIRE ALARM SYSTEM CIRCUITS.
- №-29 SAW CUTTING OF FLOOR SLAB PROVIDED BY ELECTRICAL CONTRACTOR. EXACT ROUTING TO BE DETERMINED BY SCANNING/X-RAY RESULTS. SUBMIT LAYOUT C/W CONDUIT SIZES TO ELECTRICAL CONSULTANT FOR APPROVAL PRIOR TO CUTTING OF FLOOR SLAB.
- √0-30 ENSURE A MINIMUM DISTANCE OF SEPARATION OF 5' BETWEEN POWER FEEDERS AND COMMUNICATIONS CONDUIT SYSTEMS.
- € PROVIDE THREE (3) SPARE 1 1/4"C TO CEILING SPACE C/W PULLSTRING FOR FUTURE BRANCH WIRING.
- 1 APPROXIMATE LOCATION TO TRANSITION SERVICES FROM FLOOR SLAB TO
- 2 AUTOMATED EXTERNAL DEFIBRILLATOR (AED) SUPPLIED BY THE CLIENT AND INSTALLED BY THE ELECTRICAL CONTRACTOR.

FIRE ALARM SYSTEM AUDIBILITY TESTING TO BE COMPLETED WITH ALL DOORS OPEN

ALL MEASUREMENTS ARE TO BE VERIFIED BY THE CONTRACTOR ON SITE AND ANY DISCREPANCIES ARE TO BE REPORTED BEFORE PROCEEDING WITH THE WORK. THE REGION OF DURHAM ASSUMES NO RESPONSIBILITY FOR THE ACCURACY OF THE LOCATION OF EXISTING SERVICES AS INDICATED ON THIS DRAWING. DO NOT SCALE DRAWINGS.

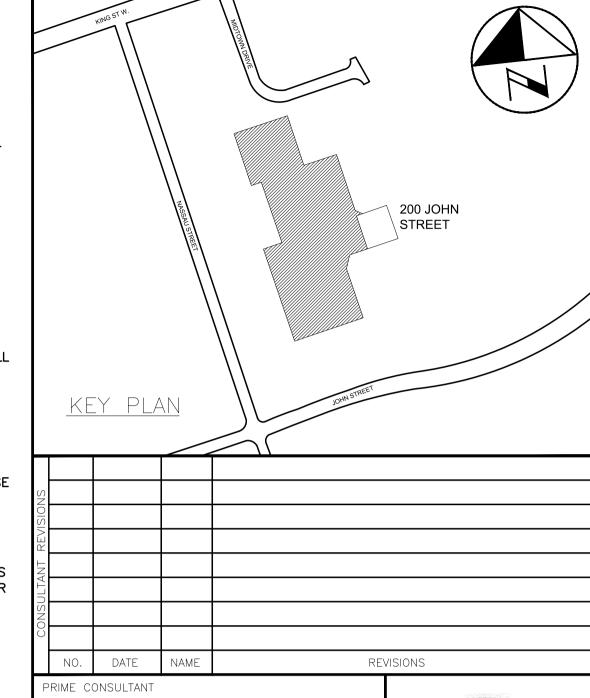

BARRY BRYAN ASSOCIATES Project Managers Whitby, Ontario L1N 0G5 Tel: (905) 666-5252



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HCC Project No.: 20104

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THE REGIONAL MUNICIPALITY OF DURHAM

WORKS DEPARTMENT DESIGN, CONSTRUCTION & ASSET MANAGEMENT

RELOCATION OF DENTAL CLINIC TO 200 JOHN ST., OSHAWA

ELECTRICAL PLAN

PROPERTY NO. V/A	LEA-0-07	LEA-0-07-19-01
CONTRACT NO.	DRAWING NO.	SHEET NO.
T-1032-2021	E-010	043

FLOOR SLAB. REFER TO DETAIL NO. 3 ON DRAWING NO. E-004 FOR ADDITIONAL REQUIREMENTS.

- N-1) REFER TO ARCHITECTS DRAWINGS FOR EXACT LOCATION AND HEIGHTS FOR MOUNTING OF FIXTURES, OCCUPANCY SENSORS, PHOTOCELL SENSORS, LIGHT SWITCHES, FIRE ALARM DEVICES, ETC.
- N-2) PROVIDE NEW LIGHTING FIXTURES, EXIT SIGNS, SWITCHES, OCCUPANCY SENSORS, PHOTOCELL SENSORS, FIRE ALARM DEVICES, ETC. TO SUIT NEW REFLECTED CEILING PLAN.
- N-3 COORDINATE INSTALLATION OF FIXTURES WITH MECHANICAL EQUIPMENT, ELECTRICAL EQUIPMENT, SPRINKLERS AND DUCT WORK.
- N-4 CHAIN HANG ALL FIXTURES PROVIDED AS PART OF THIS SCOPE OF WORK IN FINISHED CEILING AREAS ABOVE FROM SLAB (RETROFIT FIXTURES ACCORDINGLY).

 N-5 ELECTRICAL CONTRACTOR TO ENSURE THAT DEVICES ARE NOT INSTALLED ON WALLS WITH WHITE BOARDS, MONITORS OR ON FEATURE WALLS. CONFIRM WHITE BOARD, MONITOR AND
- FEATURE WALL LOCATIONS PRIOR TO INSTALLATION.

 N=6 PROVIDE LOCK ON FOR BREAKERS PROTECTING EMERGENCY LIGHTING SYSTEMS / CIRCUITS.
- MOUNTING STYLE (CEILING/WALL), HEIGHT AND LOCATION OF EXIT SIGNS TO BE DETERMINED BY ARCHITECT ON SITE. COORDINATE AND REVIEW ALL EXIT SIGN LOCATIONS WITH DESIGNER PRIOR TO ORDERING EXIT SIGNS.
- N-8 LOCATE AND POSITION EXIT SIGNS SUCH THAT THEY DO NOT INTERFERE WITH ADJACENT EXIT SIGNS AND EMERGENCY LIGHTING COVERAGE.
- N=9 AS PART OF THE BASE BID PRICE ELECTRICAL CONTRACTOR SHALL PROVIDE (SUPPLY AND INSTALL) AN ADDITIONAL FOUR (4) TYPE E1 EXIT SIGNS EACH COMPLETE WITH 75'-0" OF CONDUIT AND WIRING OVER AND ABOVE THOSE SHOWN ON DRAWING NO. E-011 POST CITY FIRE / BUILDING DEPARTMENT INSPECTIONS.
- ALL DEVICES, FIXTURES, FIRE ALARM DEVICES, SYSTEMS, ETC. MUST BE WIRED SUCH THAT ACCESS PANELS ARE NOT REQUIRED IN DRYWALL CEILING AREAS.
- (N-1) NOT USED.
- √12 ALL EXIT SIGNS TYPE 'E1' UNLESS INDICATED OTHERWISE.
- N-13 ALL SWITCHES PROVIDED AS PART OF THIS SCOPE OF WORK TO BE ALIGNED WITH
- AS-BUILT DRAWINGS MUST DETAIL THE ZONING AND CIRCUIT NUMBERS OF ALL FIXTURES THROUGHOUT ENTIRE FLOOR.
- SWITCH/DIMMING LEGS SHALL BE WIRED SUCH THAT LEG IS CONTROLLED BY OCCUPANCY SENSORS IN RESPECTIVE SPACE ENCLOSED BY CEILING HEIGHT PARTITIONS. OPERATION OF SAME LIGHT BRANCH CIRCUIT IN ADJACENT AREAS/ROOMS SHALL NOT AFFECT OPERATION OF LIGHTING IN RESPECTIVE AREA.
- PROVIDE A LOCAL 120V DISCONNECT FOR EACH BALLAST/DRIVER IN EACH FIXTURE PROVIDED AS PART OF THIS SCOPE OF WORK.
- UTILIZE CCT #RP-B-18 AND RP-C-18 (DC SOURCES M1 AND M2 RESPECTIVELY) TO POWER EXIT SIGN AC BULBS AND NON-SWITCHED NIGHT LIGHTING.
- N-18 NOT USED.
- (N-19) CEILING MOUNTED OCCUPANCY SENSORS PROVIDED AS PART OF THIS SCOPE OF WORK MUST BE INSTALLED AT LEAST 6' AWAY FROM ALL SUPPLY AIR DIFFUSERS AND RETURN AIR GRILLS. COORDINATE EXACT INSTALLATION LOCATION WITH LIGHTING CONTROL SERVICE CONSULTANT AND MECHANICAL CONTRACTOR PRIOR TO COMMENCING WORK.
- CEILING MOUNTED OCCUPANCY SENSORS IN ROOMS WITH DLM CONTROL TO BE PROGRAMMED SUCH THAT THE FUNCTION OF AUTO-ON IS DISABLED. ALL LIGHT FIXTURES WITHIN RESPECTIVE ENCLOSED SPACES SHALL BE TURNED ON MANUALLY THROUGH LOW VOLTAGE OVERRIDE SWITCHES PROVIDED AS PART OF THIS SCOPE OF WORK UNLESS INDICATED OTHERWISE.
- M-2D AS PART OF THIS SCOPE OF WORK ELECTRICAL CONTRACTOR TO HAVE LIGHTING CONTROL SYSTEM SERVICE CONSULTANT ONSITE AFTER LIGHTING AND HVAC INSTALLATION IS COMPLETE AND PRIOR TO INSTALLATION OF SENSORS PROVIDED AS PART OF THIS SCOPE OF WORK TO CONFIRM PLACEMENT OF SENSORS.
- EACH AND EVERY SPACE ENCLOSED BY CEILING HEIGHT PARTITIONS (IE. OFFICES, MEETING ROOMS, ENCLAVES, ETC.) WITH DLM CONTROL TO BE WIRED WITH TWO CONTROLLABLE SWITCH—LEGS SUCH THAT THERE IS ONE CONTROL STEP OF NOT MORE THAN 50% LIGHTING POWER IN ADDITION TO AN AUTO OFF IN THE RESPECTIVE SPACE. REFER TO ASHRAE 90.1 2013 FOR ADDITIONAL REQUIREMENTS.
- AS PART OF THE BASE BID PRICE ELECTRICAL CONTRACTOR SHALL PROVIDE (SUPPLY AND INSTALL) AN ADDITIONAL FOUR (4) DIGITAL DIMMING ROOM CONTROLLERS OVER AND ABOVE THOSE SHOWN ON DRAWING NO. E-011 ON AN AD HOC BASIS UP TO SUBSTANTIAL COMPLETION.
 - PROVIDE WATTSTOPPER LMRC-212 OR APPROVED EQUAL C/W 25' DLM CAT6 NETWORK CABLE, CONDUIT, WIRE (50' OF 2#12AWG + G (TOTAL OF 100' WIRE PLUS G, 50' CONDUIT) PER ROOM CONTROLLER), TERMINATIONS, ETC. FOR FULLY FUNCTIONAL LIVE DEVICES. EXACT INSTALLATION LOCATION AND SWITCH LEGS TO BE DETERMINED ON SITE DURING CONSTRUCTION.
- M-25 AS PART OF THE BASE BID PRICE ELECTRICAL CONTRACTOR SHALL PROVIDE (SUPPLY AND INSTALL) AN ADDITIONAL FOUR (4) TYPE 'A' CEILING MOUNTED OCCUPANCY SENSORS EACH COMPLETE WITH 75'-0" OF CONDUIT AND WIRING AND A LMSW-102 DIGITAL LIGHT SWITCH OR APPROVED EQUAL OVER AND ABOVE THOSE SHOWN ON DRAWING NO. E-011 POST SUBSTANTIAL COMPLETION.
- AS PART OF THIS SCOPE OF WORK EMPLOY AND PAY FOR THE SERVICES OF A CERTIFIED LIGHTING CONTROL SYSTEM SERVICE CONSULTANT TO COMMISSION ALL CEILING MOUNTED OCCUPANCY SENSORS PROVIDED AS PART OF THIS SCOPE OF WORK. COMMISSIONING AND DOCUMENTATION SHALL BE COMPLETED; DETAILED AS REQUIRED TO DEMONSTRATE LEED
- AS PART OF THIS SCOPE OF WORK ELECTRICAL CONTRACTOR TO HAVE LIGHTING CONTROL SYSTEM SERVICE CONSULTANT ONSITE AFTER LIGHTING AND HVAC INSTALLATION IS COMPLETE AND PRIOR TO INSTALLATION OF SENSORS PROVIDED AS PART OF THIS SCOPE OF WORK TO CONFIRM PLACEMENT OF SENSORS.


DIMMER SCHEDULE

DIMMER ZONE	DIMMER TYPE
DIM A	DLM
DIM B	DLM
DIM C	DLM

0 TO 10VDC DLM DIMMER — WATTSTOPPER DLM LMDM—101 OR APPROVED EQUAL 0 TO 10VDC DIMMER — GREENGATE SF10P—W OR APPROVED EQUAL 120 VOLT REVERSE PHASE DIMMER — LUTRON DIVA SERIES OR APPROVED EQUAL

> REFER TO DETAIL NO. 3 ON DRAWING NO. E-005 FOR FIXTURE SCHEDULE

ALL MEASUREMENTS ARE TO BE VERIFIED BY THE CONTRACTOR ON SITE AND ANY DISCREPANCIES ARE TO BE REPORTED BEFORE PROCEEDING WITH THE WORK. THE REGION OF DURHAM ASSUMES NO RESPONSIBILITY FOR THE ACCURACY OF THE LOCATION OF EXISTING SERVICES AS INDICATED ON THIS DRAWING. DO NOT SCALE DRAWINGS.

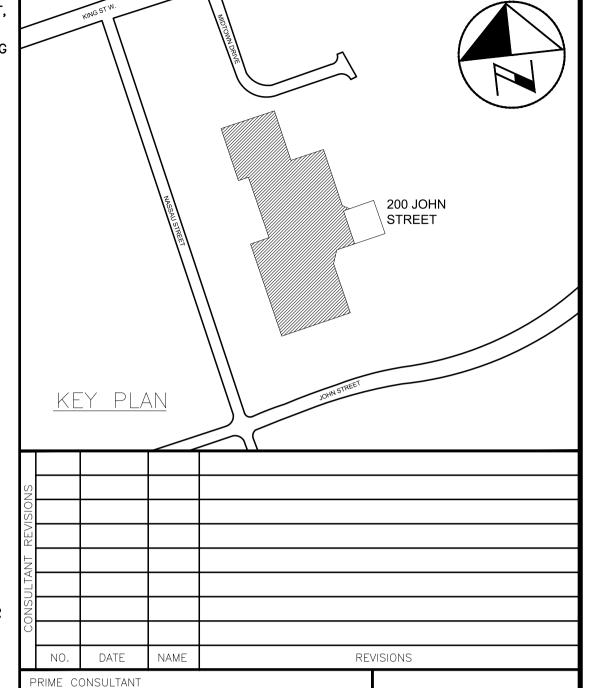





SUB-CONSULTANT

HCC ENGINEERING

DESIGN AND TECHNOLOGY SERVICES GROUP

HCC ENGINEERING LIMITED

40 EGLINTON AVENUE EAST, SUITE 600
TORONTO, ONTARIO, M4P 3A2
Tel: (416) 932-2423



HCC Project No.: 20104

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	RAC	3	FEB09/2021	HCC	ISSUED FOR F	PERMIT & TENDER	
	CONTRACT	2	OCT30/2020	HCC	ISSUED FOR 9	0% REVIEW	
	\circ	1	JUNE 1/20	HCC	ISSUED FOR 6	60% REVIEW	
		NO	DATE	NAME		REVISIONS	



THE REGIONAL MUNICIPALITY
OF DURHAM

WORKS DEPARTMENT


DESIGN, CONSTRUCTION & ASSET MANAGEMENT

RELOCATION OF DENTAL CLINIC TO 200 JOHN ST., OSHAWA

REFLECTED CEILING PLAN

property no. N/A	facility code LEA-0-07	FACILITIES PROJECT NO. LEA-0-07-19-01
CONTRACT NO.	DRAWING NO.	SHEET NO.
T-1032-2021	E-011	044

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045

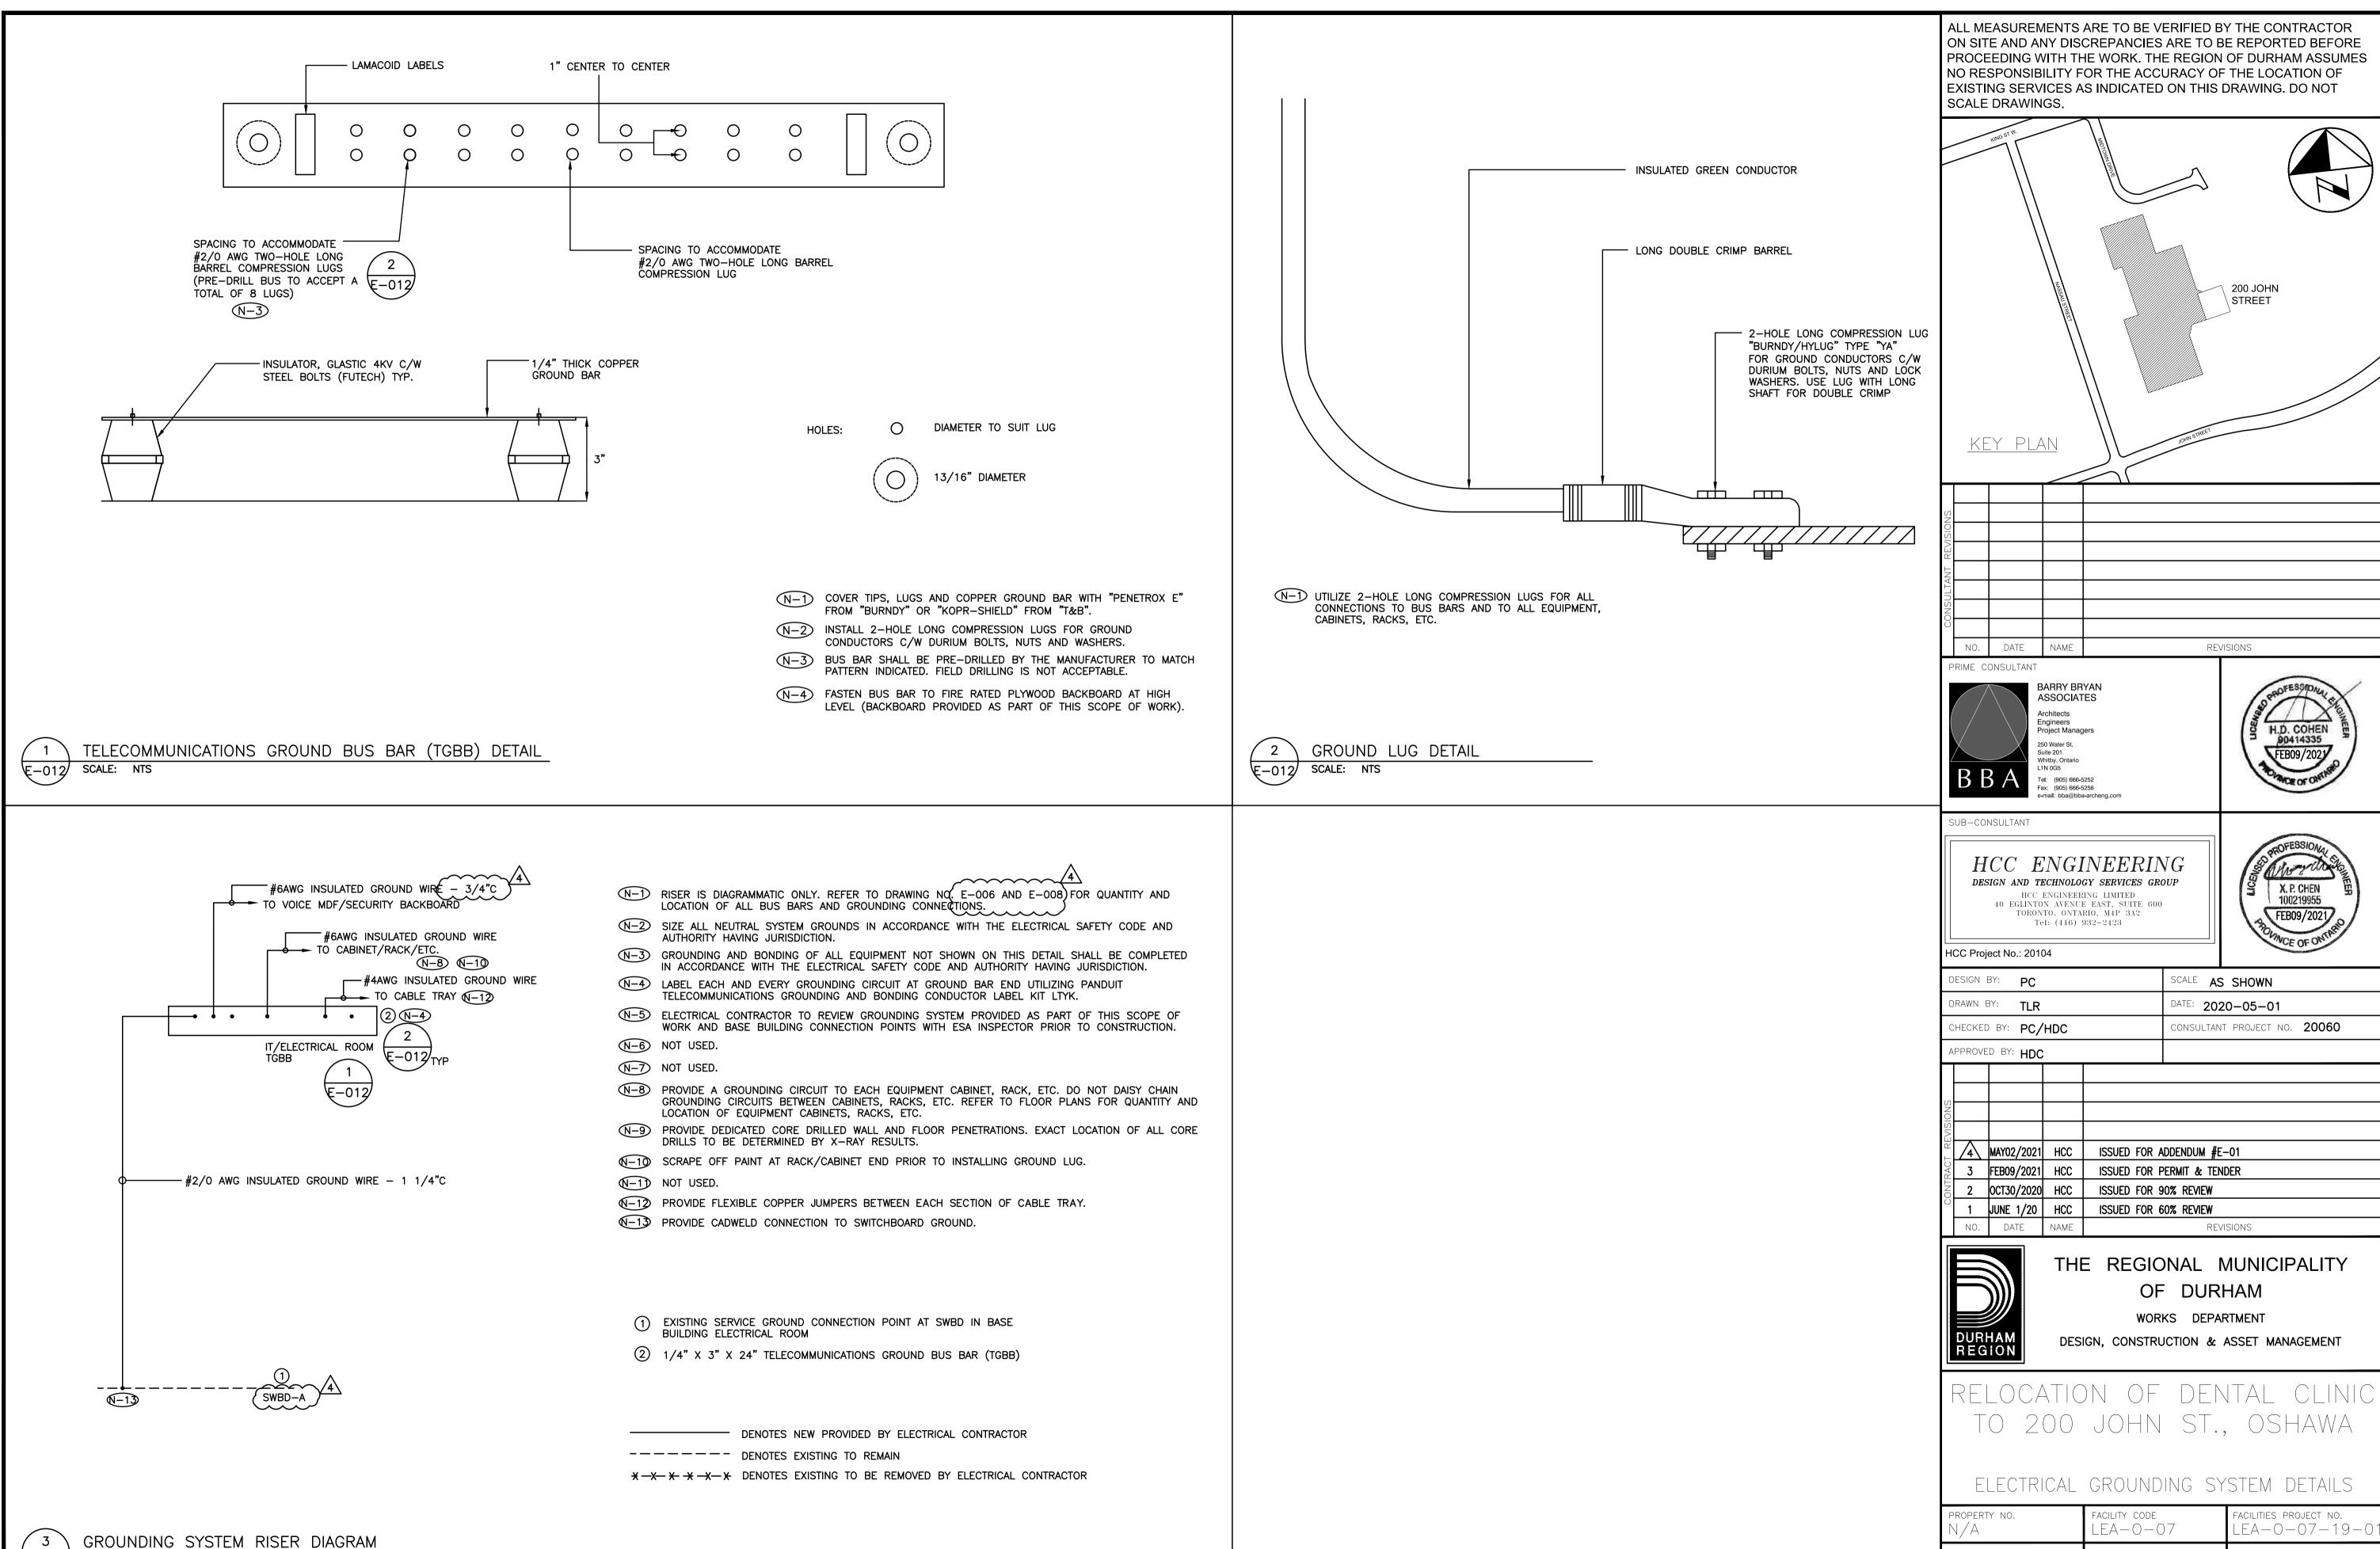DRAWING NO.

SHEET NO.

CONTRACT NO.

T-1032-202

SWBD-A MANUFACTURER HIGH LEVEL SCOPE OF WORK

PROCURE THE SERVICE OF A SWITCHBOARD MANUFACTURER TO COMPLETE THE FOLLOWING SCOPES OF WORK:

PROVIDE ONSITE INSTALLATION OF ONE (1) 600A/3P/65KA RMS/100% RATED BREAKER IN EXISTING GE SWITCHGEAR, 120/208V, 1600A, 3P/4W.

^^^^^

SCOPE OF WORK:

- ADD LUG PADS TO MAIN THRU BUS FOR CONNECTION CABLES TO THE NEW BREAKER. • PROVIDE NEW BREAKER, 120/208V, 600A, 3P, 100% RATED, 60HZ, 65KA @ 240VAC.
- PROVIDE CABLES FEEDING THE NEW BREAKER
- PROVIDE NEW DOOR RE—CERTIFY SWITCHBOARD

ELECTRICAL CONTRACTOR TO PREPARE A PRELIMINARY ZERO FEEDER LENGTH COORDINATION STUDY PRIOR TO ORDERING DISTRIBUTION. SUBMIT TO CONSULTANT FOR REVIEW AND APPROVAL.

- (N-1) RISER IS DIAGRAMMATIC ONLY. REFER TO FLOOR PLANS FOR DEVICE QUANTITY AND LOCATIONS.
- N-2) PROVIDE FIRE RATED PLYWOOD BACKBOARDS FOR ALL ELECTRICAL DISTRIBUTION EQUIPMENT PROVIDED AS PART OF THIS CONTRACT AND FOR ALL PREPURCHASED/PREQUALIFIED DISTRIBUTION. PAINT BACKBOARDS WITH FIRE RETARDANT PAINT (COLOUR AS DIRECTED ON SITE BY ARCHITECT). FIRE RATED STAMP MUST BE ON ALL PIECES PROVIDED AND MUST BE VISIBLE WHEN INSTALLED. DO NOT PAINT OVER STAMP.
- N-3) PROVIDE DEDICATED CORE DRILLED WALL AND FLOOR PENETRATIONS ON EVERY FLOOR. EXACT LOCATION OF ALL CORE DRILLS TO BE DETERMINED BY X-RAY RESULTS. ALL X-RAYS MUST BE REVIEWED AND APPROVED BY LANDLORD PRIOR TO CORE DRILLING.
- (N-4) PROVIDE TEMPORARY POWER AND LIGHTING THROUGHOUT PROJECT TO ACCOMMODATE REQUIREMENTS OF ALL TRADES, INCLUDING ELEVATOR CONTRACTOR. REQUIREMENTS INCLUDE PROVIDING EXTENSION CORDS, EXTENSION LIGHTING AND EQUIPMENT REQUIRED FOR THE WORK OF ALL TRADES. PROVIDE TEMPORARY GENERATOR AND CABLES AS REQUIRED WHEN UTILITY SERVICE IS NOT AVAILABLE. ALL COSTS RELATED TO THIS WORK SHALL BE INCLUDED IN THE BASE BID PRICE.
- N-5) ROUTE ALL CONDUIT SYSTEMS AROUND DUCT WORK, FIRE SUPPRESSION PIPING, ETC AS REQUIRED TO ACCOMMODATE INSTALLATION. REFER TO MECHANICAL DRAWINGS FOR ADDITIONAL DETAILS.
- N-6 ALL INDOOR DISTRIBUTION (INCLUDING TRANSFORMERS) PROVIDED AS PART OF THIS SCOPE OF WORK MUST BE NEMA 2 ENCLOSURE. PROVIDE ALL FITTINGS. ACCESSÓRIES. ETC REQUIRED FOR A COMPLETE INSTALLATION. SUITABLE FOR RESPECTIVE ENVIRONMENTS. PROVIDE COMPRESSION FITTINGS FOR SERVICES ENTERING
- N-7 PROVIDE REQUIRED PENETRATIONS THROUGH ROOF AND BUILDING ENVELOP. COORDINATE WORK AND WEATHERPROOF SEALING REQUIREMENTS WITH LANDLORD.
- N-8 CONFIRM BREAKER/FUSE AND RECEPTACLE/DISCONNECT REQUIREMENTS PRIOR TO INSTALLATION.
- N=9) AS PART OF THIS SCOPE OF WORK PROCURE THE SERVICES OF THE SWITCHBOARD MANUFACTURER TO SUPPLY AND INSTALL BREAKER INDICATED. REFER TO SWBD-A HIGH LEVEL SCOPE OF WORK ON THIS DRAWING FOR ADDITIONAL REQUIREMENTS. ADDITIONAL REQUIREMENTS.
- $\sqrt{10}$ NOT USED.
- √1) ALL BREAKERS REQUIRED TO COMPLETE ALL SCOPES OF WORK TO BE NEW. DO NOT REUSE EXISTING BREAKERS.
- €-12 ELECTRICAL CONTRACTOR SHALL REMOVE EXISTING METER (INCLUDING PT'S AND CT'S) AND PACKAGE FOR PICK UP BY LOCAL UTILITY. COORDINATE AND PAY FOR ALL LOCAL UTILITY COSTS TO PICK UP METER.
- √13 AS PART OF THIS SCOPE OF WORK ELECTRICAL CONTRACTOR SHALL COORDINATE AND PAY FOR THE SERVICES OF THE LOCAL UTILITY TO PROVIDE ACCESS TO THE EXISTING METER CABINET AS REQUIRED TO FACILITATE ALL SCOPES OF WORK PROVIDED AS PART OF THIS SCOPE OF WORK.
- № PROVIDE UTILITY APPROVED METER SOCKET AS PART OF THIS SCOPE OF WORK.
- €-15 PROVIDE NEW UTILITY METER. AS PART OF THIS SCOPE OF WORK ELECTRICAL CONTRACTOR SHALL INCLUDE FOR ALL UTILITY COSTS AND CONNECTION CHARGES FOR ALL NEW SERVICES.


- 1 EXISTING SWITCHBOARD 120/208V/3PH/4W/1600A BUS/GE SWITCHGEAR/65KA RMS
- 2 EXISTING SPLITTER 120/208V/3PH/4W/400A
- 3 EXISTING RECEPTACLE PANEL 120/208V/3PH/4W/225A MAINS/42CCT/CUTLER-HAMMER PRL1A
- (4) EXISTING METER CABINET C/W METER BASE AND METER TO BE REMOVED AS PART OF THIS SCOPE OF WORK
- DISTRIBUTION PANEL = 120/208V/3PH/4W/600A MCB/SQ D I LINE HCP/42"W X 9.5"D X 86"H C/W HINGED DOOR/COPPER BUS/42KA RMS /4
- (6) RECEPTACLE PANEL 120/208V/3PH/4W/225A MAINS/COPPER BUS/84CCT 20"W/SQ D (NQ/42KA RMS
- (7) RECEPTACLE PANEL 120/208V/3PH/4W/150A MCB/COPPER BUS/84CCT 20"W/SQ D NQ/22KA RMS/RECESSED TRIM FACTORY PAINTED CUSTOM COLOUR (MATCH TO PAINT CHIP TO BE PROVIDED BY INTERIOR DESIGNER DURING CONSTRUCTION)
- (8) 4' X 4' X 1' OSHAWA PUC NETWORKS APPROVED METER CABINET C/W BACK PLATE AND VIEWING WINDOW (CONFIRM SIZE WITH UTILITY PRIOR TO ORDERING)
- 9 RECEPTACLE PANEL 120/208V/3PH/4W/200A MCB/COPPER BUS/84CCT 20"W/SQ D NQ 22KA RMS RECESSED TRIM FACTORY PAINTED CUSTOM COLOUR (MATCH TO PAINT CHIP TO BE PROVIDED BY INTERIOR DESIGNER DURING

DENOTES NEW PROVIDED BY ELECTRICAL CONTRACTOR

---- DENOTES EXISTING TO REMAIN

-x-x-x-x-x-x- DENOTES EXISTING TO BE REMOVED BY ELECTRICAL CONTRACTOR

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HCC Project No.: 20104 DESIGN BY: PC SCALE N.T.S. DATE: **2020-05-01** DRAWN BY: TLR

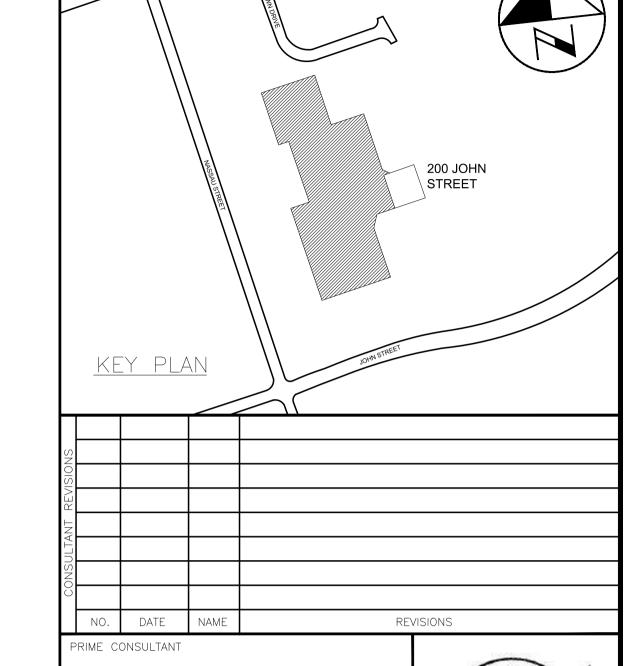CONSULTANT PROJECT NO. 20060 CHECKED BY: PC/HDC APPROVED BY: HDC

| /4\ | APR15/2021| HCC | ISSUED FOR ADDENDUM #E-01 3 | FEB09/2021 | HCC | ISSUED FOR PERMIT & TENDER 2 OCT30/2020 HCC ISSUED FOR 90% REVIEW 1 JUNE 1/20 HCC ISSUED FOR 60% REVIEW DATE REVISIONS



THE REGIONAL MUNICIPALITY OF DURHAM

WORKS DEPARTMENT

DESIGN, CONSTRUCTION & ASSET MANAGEMENT

RELOCATION OF DENTAL CLINIC TO 200 JOHN ST., OSHAWA

ELECTRICAL SINGLE LINE DIAGRAM

PROPERTY NO. FACILITY CODE FACILITIES PROJECT NO. _EA-0-07 _EA-0-07-19-01 CONTRACT NO. DRAWING NO. SHEET NO. T - 1032 - 202E - 01

- (1) EQUIPMENT CABINET PROVIDED BY COMMUNICATIONS CONTRACTOR.
- 2 PLENUM RATED 4 PAIR CATEGORY 6 UTP DATA CABLE PROVIDED BY COMMUNICATIONS CONTRACTOR. RED IN COLOUR.
- 3 CCTV SYSTEM CLIENT (NETWORK VIDEO MANAGEMENT) WORKSTATION C/W SENSTAR THIN CLIENT 10D PROVIDED AS PART OF THIS SCOPE OF WORK. REFER TO SPECIFICATIONS FOR ADDITIONAL REQUIREMENTS.
- (4) CCTV SYSTEM NETWORK STORAGE SERVERS PROVIDED AS PART OF THIS SCOPE OF WORK VIVOTEK NVR ND9322P—V2 C/W DIGITAL WATCHDOG SPECTRUM VIDEO MANAGEMENT—SYSTEM
- (5) MULTICONDUCTOR CABLE PER VIVOTEK'S RECOMMENDATIONS.
- 6 1RMU 24 PORT POE ACTIVE SWITCH VIVOTEK AW-GEV-264A-370.

 7 2RMU 1500VA UPS XTREME POWER P80 1500VA C/W NETWORK MANAGEMENT PROTOCOL (SNMP) NOTIFICATION CARD PROVIDED AS PART OF THIS SCOPE OF WORK..
- (8) RACK MOUNTED CONSOLE KVM SWITCH C/W 19" LCD, CABINET MOUNTED BRACKETS AND EIGHT (8) USB SERVER INTERFACE UNITS PROVIDED AS PART OF THIS SCOPE OF WORK EIGHT (8) SERVER INPUTS, ONE (1) MONITOR AND ONE (1) KEYBOARD TRIPP LITE B070-008-19-IP
- 9 2RMU UPS BATTERY XTREME POWER P90-BP48 PROVIDED AS PART OF THIS SCOPE OF WORK.

	······
CCTV CAMERA	MAKE/MODEL NUMBER
C1 }	VIVOTEK FD9167-HT C/W AM-105 MOUNTING BRACKET
C2 {	VIVOTEK FD9167-HT C/W AM-105 MOUNTING BRACKET
C3 {	VIVOTEK CC8370-HV C/W MOUNTING BRACKET
C4 }	VIVOTEK FD9167-HT C/W AM-105 MOUNTING BRACKET
C5 }	VIVOTEK CC8370-HV C/W MOUNTING BRACKET
C6 }	VIVOTEK FD9167-HT C/W AM-105 MOUNTING BRACKET

DENOTES NEW PROVIDED BY ELECTRICAL CONTRACTOR

---- DENOTES EXISTING TO REMAIN

-x-x-x-x-x-x- DENOTES EXISTING TO BE REMOVED BY ELECTRICAL CONTRACTOR

N-1) RISER IS DIAGRAMMATIC ONLY. PROVIDE QUANTITY OF HARDWARE, MODULES, ACCESSORIES, DEVICES, SOFTWARE, LICENSES, TESTING, PROGRAMMING, COMMISSIONING, ETC., TO ENSURE A FULLY OPERATIONAL CCTV SYSTEM.


- PROVIDE QUANTITY OF HARDWARE, CAMERAS, SERVERS AND POWER SUPPLIES REQUIRED FOR A FULLY OPERATIONAL CCTV SYSTEM. REFER TO FLOOR PLANS FOR ADDITIONAL REQUIREMENTS. NOTE NETWORK SWITCH PROVIDED BY OWNER.
- N-3 COORDINATE INSTALLATION AND MOUNTING REQUIREMENTS OF CCTV EQUIPMENT PROVIDED AS PART OF THIS SCOPE OF WORK WITH SECURITY VENDOR PRIOR TO COMMENCING WORK.
- AS PART OF THIS SCOPE OF WORK CONFIGURE ALL CAMERAS PROVIDED AS PART OF THIS SCOPE OF WORK WITH FOLLOWING SETTINGS:

FRAME RATE: 10 IMAGE/S
DUTY CYCLE: 100% (INTERIOR)

- N-5) AS PART OF THIS SCOPE OF WORK, INCLUDE ALL SYSTEM SET UP, PROGRAMMING, LICENSES, LICENSES REQUIRED FOR EACH CAMERA, COMMISSIONING, ETC TO ENSURE A FULLY OPERATIONAL MONITORING SYSTEM. PROVIDE TRAINING FOR ALL FACILITIES STAFF POST COMMISSIONING.
- AS PART OF THIS SCOPE OF WORK AND PRIOR TO CONSTRUCTION, ELECTRICAL CONTRACTOR SHALL CONFIRM CAMERA INSTALLATION LOCATIONS AND REQUIREMENTS ON SITE WITH CCTV MANUFACTURER, ARCHITECT AND CLIENT PRIOR TO SUBMITTING SHOP DRAWINGS. MOUNTING STYLE AND FIELD OF VIEW FOR ALL CAMERAS SHALL BE CONFIRMED BY BOTH MANUFACTURER AND CLIENT PRIOR TO INSTALLATION.
- N-7 PROVIDE DEDICATED FLOOR AND WALL PENETRATIONS. EXACT LOCATION OF ALL CORE DRILLS TO BE DETERMINED BY X-RAY RESULTS. X-RAYS MUST BE REVIEWED AND APPROVED BY LANDLORD AND STRUCTURAL ENGINEER PRIOR TO CORE DRILLING.
- N-8

 AS PART OF THIS SCOPE OF WORK PROVIDE AN INTERFACE
 BETWEEN CARD ACCESS CONTROL SYSTEM PROVIDED AS PART OF
 THIS SCOPE OF WORK AND CCTV SYSTEM PROVIDED AS PART OF
 THIS SCOPE OF WORK SUCH THAT THE CCTV SYSTEM IS
 INTERFACED WITH THE CARD ACCESS CONTROL SYSTEM PROVIDED
 AS PART OF THIS SCOPE OF WORK. PROVIDE ALL CARD ACCESS
 CONTROL SYSTEM AND CCTV SYSTEM LICENSES AND
 PROGRAMMING. PROVIDE ALL REQUIRED CCTV SYSTEM
 COMPONENTS, ACCESSORIES, WIRING, OUTPUT CONTACTS, INPUT
 CONTACTS, ETC. FOR A FULLY OPERATIONAL SYSTEM.
- N-9 ALL FIELD DEVICE WIRING TO BE PULLED AS HOMERUNS TO RESPECTIVE RACK MOUNTED PATCH PANELS PROVIDED BY COMMUNICATIONS CONTRACTOR.
- AS PART OF THIS SCOPE OF WORK FOR EACH AND EVERY CLIENT WORKSTATION PROVIDE ONE (1) 24" COLOUR LED MONITOR, KEYBOARD, MOUSE AND CCTV SYSTEM MONITORING PROGRAM AND SOFTWARE LICENSE. HARDWARE AND SOFTWARE PROVIDED AS PART OF THIS SCOPE OF WORK SHALL BE INTEGRATED INTO CCTV SYSTEM VIDEO CONSOLE DISPLAY STATION. CCTV SYSTEM VIDEO CONSOLE DISPLAY STATION PROVIDED AS PART OF THIS SCOPE
- AS PART OF THIS SCOPE OF WORK INCLUDE FOR TWO (2) THREE (3) HOUR MEETING SESSIONS WITH CLIENT AND ARCHITECT TO REVIEW CCTV SYSTEM VIEWING DISPLAY ARRANGEMENT REQUIREMENTS PRIOR TO CONSTRUCTION. AS PART OF THIS SCOPE OF WORK ALLOW FOR AN ADDITIONAL TWO (2) TWO (2) HOUR PROGRAMMING SESSIONS TO FINE TUNE CCTV SYSTEM VIEWING DISPLAY ARRANGEMENTS TO CLIENT'S SATISFACTION OVER AND ABOVE THE TIME REQUIRED TO PROGRAM AND SET UP THE CCTV SYSTEM PROVIDED AS PART OF THIS SCOPE OF WORK.
- AS PART OF THIS SCOPE OF WORK PROVIDE QUANTITY OF SERVER STORAGE HARD DRIVES SIZED TO ALLOW FOR AT LEAST THIRTY (30) DAYS RECORDING TIME FOR ALL CAMERAS PROVIDED AS PART OF THIS SCOPE OF WORK. STORAGE SPACE MUST ALSO BE SIZED TO INCLUDE/ACCOMMODATE THREE (3) ADDITIONAL FUTURE CAMERAS BASED ON 2 MEGAPIXEL RESOLUTION AND FRAME RATE AND DUTY CYCLE SPECIFIED FOR INTERIOR APPLICATION. REFER TO NOTE N-4 IN THIS DETAIL FOR ADDITIONAL REQUIREMENTS.
- REFER TO REGIONAL MUNICIPALITY OF DURHAM CORPORATE POLICY AND PROCEDURES MANUAL - SECURITY SERVICES INSTALLATION AND SECURITY SYSTEM STANDARDS, GUIDELINE FOR ADDITIONAL REQUIREMENTS INCLUDING BUT NOT LIMITED TO APPROVED EQUIPMENT SELECTIONS, LABELING REQUIREMENTS, ETC OVER AND ABOVE THOSE DETAILED IN THIS DRAWING PACKAGE AND IN THE ELECTRICAL SPECIFICATIONS BOOK. CONTRACTOR SHALL BE RESPONSIBLE FOR AND MUST INCLUDE IN BASE BID PRICE FOR ALL SCOPES OF WORK DETAILED IN THE REGIONAL MUNICIPALITY OF DURHAM CORPORATE POLICY AND PROCEDURES MANUAL - SECURITY SERVICES INSTALLATION AND SECURITY SYSTEM STANDARDS, ELECTRICAL DRAWINGS AND ELECTRICAL SPECIFICATIONS BOOK. CONTACT REGIONAL MUNICIPALITY OF DURHAM PROJECT MANAGER FOR QUESTIONS REGARDING REGIONAL MUNICIPALITY OF DURHAM CORPORATE POLICY AND PROCEDURES MANUAL - SECURITY SERVICES INSTALLATION AND SECURITY SYSTEM STANDARDS DOCUMENT.

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Project Managers
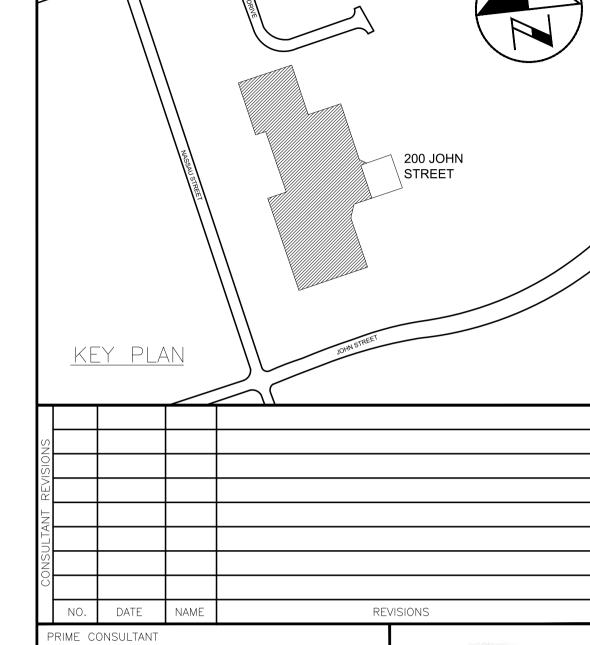
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DESIGN AND TECHNOLOGY SERVICES GROUNDED HCC ENGINEERING LIMITED 40 EGLINTON AVENUE EAST, SUITE 600 TORONTO, ONTARIO, M4P 3A2 Tel: (416) 932-2423



DESIGN BY: PC

DRAWN BY: TLR

DATE: 2020-05-01

CHECKED BY: PC/HDC

APPROVED BY: HDC

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THE REGIONAL MUNICIPALITY
OF DURHAM

REVISIONS

WORKS DEPARTMENT

DESIGN, CONSTRUCTION & ASSET MANAGEMENT

RELOCATION OF DENTAL CLINIC TO 200 JOHN ST., OSHAWA

CCTV SYSTEM RISER DIAGRAM

property no. N/A	facility code LEA-0-07	FACILITIES PROJECT NO. LEA-0-07-19-01
CONTRACT NO.	DRAWING NO.	SHEET NO.
T-1032-2021	E-016	049

- N-1 RISER IS DIAGRAMMATIC ONLY. PROVIDE QUANTITY OF POWER CIRCUITS, CONTROL PANELS, MODULES, FIELD DEVICES, ACCESSORIES, WIRE, SECURITY CABLES, SOFTWARE, TESTING, LICENSES, PROGRAMMING, COMMISSIONING, ETC, TO ENSURE A FULLY OPERATIONAL ACCESS CONTROL SYSTEM. REFER TO DRAWING NO. E-017 AND TO FLOOR PLANS FOR ADDITIONAL REQUIREMENTS.
- N-2 REFER TO FLOOR PLAN DRAWINGS FOR DEVICE QUANTITY AND LOCATIONS.
- N-3 PROVIDE CONDUITS AND WIRES IN ACCORDANCE WITH THE MANUFACTURER'S RECOMMENDATIONS. MINIMUM CONDUIT SIZE AS DETAILED ON RISER.
- $\overline{-4}$ ALL CONDUITS SHALL BE C/W BUSHINGS AND RUBBERIZED GROMMETS.
- ALL CONDUITS TO BE EMT. EMT COUPLING AND CONNECTORS SHALL BE T&B STEEL, SET SCREW TYPE. PROVIDE SPARE PULLSTRING IN ALL CONDUITS FOR FUTURE USE.
- N-6 ELECTRICAL CONTRACTOR SHALL NOT USE PULLBOXES AS SUBSTITUTES FOR 90° BENDS. 12" X 12" X 6" PULLBOXES C/W TYPE SNAKE EYE SECURITY SCREWS SHALL BE PROVIDED ON THE BASIS OF NOT MORE THAN TWO (2) RIGHT ANGLE BENDS OR NOT MORE THAN 100' IN STRAIGHT RUNS BETWEEN BOXES.
- N-7 CONTACT SECURITY MANUFACTURER FOR ADDITIONAL WIRE, CONDUIT, PULLBOX AND POWER REQUIREMENTS OVER AND ABOVE THOSE SHOWN ON DRAWING.
- N-8 PROVIDE DEDICATED FLOOR AND WALL PENETRATIONS. EXACT LOCATION OF ALL CORE DRILLS TO BE DETERMINED BY X-RAY RESULTS. X-RAYS MUST BE REVIEWED AND APPROVED BY LANDLORD PRIOR TO CORE DRILLING.
- N-9 PROVIDE FIRE RATED PLYWOOD BACKBOARDS FOR ALL CABINETS, ACCESS CONTROL PANELS, POWER SUPPLIES, ETC PROVIDED AS PART OF THIS CONTRACT. PAINT BACKBOARDS WITH WHITE FIRE RETARDANT PAINT. FIRE RATED STAMP MUST BE ON ALL PIECES PROVIDED AND MUST BE VISIBLE WHEN INSTALLED. DO NOT PAINT OVER STAMP.
- √10 NOT USED
- ALL CONDUITS PROVIDED BY THE ELECTRICAL CONTRACTOR ARE TO BE ROUTED IN THE CEILING SPACE.
- AS PART OF THIS SCOPE OF WORK, COORDINATE TERMINATION OF SECURITY CABLES PROVIDED AS PART OF THIS SCOPE OF WORK ON SITE WITH SECURITY CONTRATOR PRIOR TO COMMENCING WORK.

1 SECURITY SYSTEM ACCESS CONTROL PANEL PROVIDED AS PART OF THIS SCOPE OF WORK


- ② NOT USED.
- 3 NOT USED.
- 4 NOT USED.
- 5 3/4" ZONE CONDUIT C/W BUSHINGS AND RUBBERIZED GROMMETS
- 6 1 1/4" ZONE CONDUIT C/W BUSHINGS AND RUBBERIZED GROMMETS
- 7 NOT USED.
- 8 ACCESS CONTROL SYSTEM SERVER PROVIDE AS PART OF
- THIS SCOPE OF WORK
- EQUIPMENT CABINET PROVIDED BY COMMUNICATIONS
 CONTRACTOR
- O VOICE MDF / SECURITY BACKBOARD PROVIDED AS PART OF THIS SCOPE OF WORK

DENOTES NEW PROVIDED BY ELECTRICAL CONTRACTOR

---- DENOTES EXISTING TO REMAIN

-x-x-x-x-x-x- DENOTES EXISTING TO BE REMOVED BY ELECTRICAL CONTRACTOR

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BARRY BE ASSOCIAT Architects Engineers Project Manag 250 Water St. Suite 201 Whitby, Ontario L1N 0G5
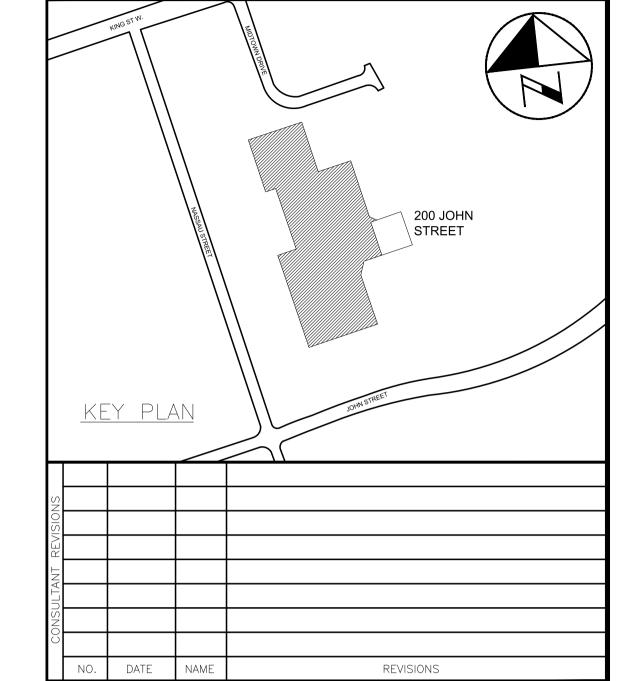
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HCC Project No.: 20104

DESIGN	BY: PC			SCALE N.T.S.
DRAWN	BY: TLR			DATE: 2020-05-01
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THE REGIONAL MUNICIPALITY
OF DURHAM


WORKS DEPARTMENT

DESIGN, CONSTRUCTION & ASSET MANAGEMENT

RELOCATION OF DENTAL CLINIC TO 200 JOHN ST., OSHAWA

ACCESS CONTROL SYSTEM CONDUIT RISER DIAGRAM

property no. N/A	facility code LEA-0-07	facilities project no. LEA-0-07-19-01
CONTRACT NO.	DRAWING NO.	SHEET NO.
T-1032-2021	E-017	050

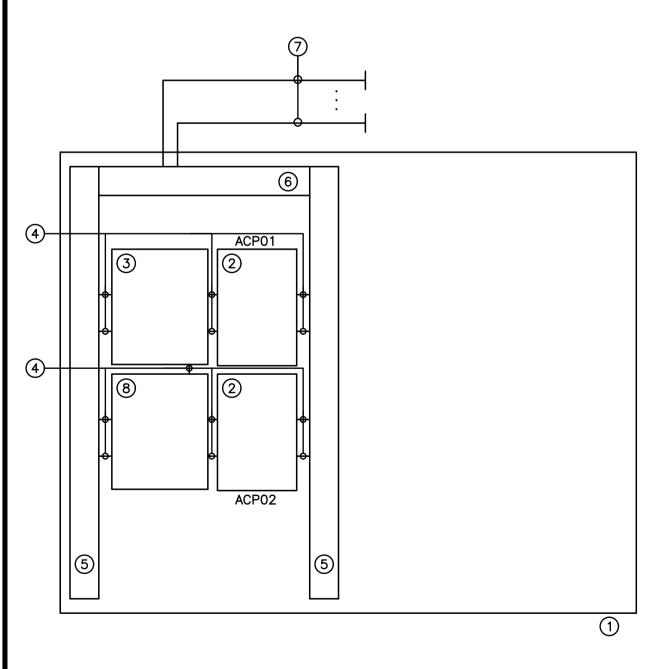

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- N-2 ALL CONDUITS SHALL BE C/W BUSHINGS AND RUBBERIZED GROMMETS.
- N-3 ALL CONDUITS TO BE EMT. EMT COUPLING AND CONNECTORS SHALL BE T&B STEEL, SET SCREW TYPE. PROVIDE SPARE PULLSTRING IN ALL CONDUITS FOR FUTURE USE.
- N-4 PROVIDE DEDICATED FLOOR AND WALL PENETRATIONS. EXACT LOCATION OF ALL CORE DRILLS TO BE DETERMINED BY X-RAY RESULTS. X-RAYS MUST BE REVIEWED AND APPROVED BY LANDLORD PRIOR TO CORE DRILLING.
- 1) VOICE MDF / SECURITY BACKBOARD PROVIDED AS PART OF THIS SCOPE OF WORK
- 2 ACCESS CONTROL PANEL PROVIDED AS PART OF THIS SCOPE OF WORK
- (3) ACCESS CONTROL SYSTEM AND ELECTRIC STRIKE POWER SUPPLY PROVIDED AS PART OF THIS SCOPE OF WORK
- 4 2" CONDUIT NIPPLE C/W BUSHINGS AND RUBBERIZED
- 5 7'-6" LENGTH OF 6" X 6" WIREWAY, MOUNTED VERTICALLY PROVIDED AS PART OF THIS SCOPE OF WORK FOR SECURITY CONTRACTOR'S USE. COORDINATE EXACT REQUIREMENTS ON SITE WITH SECURITY CONTRACTOR.
- 6 4' LENGTH OF 4" X 4" WIREWAY, MOUNTED HORIZONTALLY PROVIDED AS PART OF THIS SCOPE OF WORK FOR SECURITY CONTRACTOR'S USE. COORDINATE EXACT REQUIREMENTS ON SITE WITH SECURITY CONTRACTOR.
- ZONE CONDUITS C/W WIRING. REFER TO DETAIL NO. 1 ON DRAWING NO. E−004 AND E−017 FOR ADDITIONAL REQUIREMENTS.

 REQUIREMENTS.

 ZONE CONDUITS C/W WIRING. REFER TO DETAIL NO. 1 ON DRAWING NO. 1 ON DETAIL NO. 1 ON DETA
- 8 BATTERY CABINET C/W 12V BATTERY PACKS PROVIDED AS PART OF THIS SCOPE OF WORK
- 1 VOICE MDF/SECURITY BACKBOARD BUILD OUT DETAIL SCALE: NTS

~~~~~~~<del>\</del> 1 SECURITY SYSTEM ACCESS CONTROL PANEL C/W 8 READER ACCESS CONTROL MODULES PROVIDED AS PART OF THIS SCOPE OF WORK NOT USED.

(3) ACCESS CONTROL SYSTEM WIRING PROVIDED AS PART OF THIS SCOPE OF WORK. REFER TO FLOOR PLANS FOR QUANTITY AND LOCATION OF ACCESS CONTROL DEVICES.

BELDEN 658GFS BANANA PEEL NO OVERALL JACKET COMPOSITE - LOCK POWER, CARD READER, DOOR CONTACT, REX APPLICATIONS

TYPICAL ACCESS CONTROL SYSTEM DEVICE WIRING DOOR CONTACT - 2 PAIR #22AWG MOTION DETECTOR - 1 X 3 PAIR #22AWG SHIELDED ELECTRIC STRIKE - 2 PAIR #16AWG AUDIBLE ALARM - 1 PAIR #22AWG CARD / PROXIMITY READER - 3 PAIR SHIELDED #22AWG (OVERALL CRASH BAR - 1 PAIR #22AWG UNIVERSAL WASHROOM DURESS - 2 PAIR #22AWG DOOR OPERATOR INTERFACE DEVICE - 3 PAIR SHIELDED #22AWG (OVERALL SHIELD)

- (4) NOT USED
- 5 4 PAIR CAT 6 UTP DATA CABLE PROVIDED BY COMMUNICATIONS
- CONTRACTOR -3/4"C
- (6) NOT USED (4) 7 ACCESS CONTROL SYSTEM SERVER PROVIDED AS PART OF THIS SCOPE OF (8) NOT USED .....
- (9) EQUIPMENT CABINET PROVIDED BY COMMUNICATIONS CONTRACTOR

DENOTES NEW PROVIDED BY ELECTRICAL CONTRACTOR

---- DENOTES EXISTING TO REMAIN

-x-x-x-x-x-x-x- DENOTES EXISTING TO BE REMOVED BY ELECTRICAL CONTRACTOR


| DEVICE TYPE PROVIDED AS<br>PART OF THIS SCOPE OF WORK      | MANUFACTURER | SERIES / PART # | DRAWING SYMBOL / REFERENCE |
|------------------------------------------------------------|--------------|-----------------|----------------------------|
| 8 READERS C/W ENCLOSURE AND DUAL 10/100/1GB ETHERNET PORTS |              | € 15°           |                            |
| POWER SUPPLY                                               |              | <b>N</b> −15    |                            |
| BATTERY CABINET C/W 12V BATTERIES                          |              | <b>N</b> −15    |                            |
| READER                                                     |              | <b>N</b> −15    | CR                         |
| REQUEST TO EXIT DETECTOR                                   |              | N-15            | MD                         |
| AUDIBLE ALARM / 2 TONE / INDOOR                            |              | N-15            | H                          |
| ELECTRIC STRIKE, 12/24V - BLACK                            |              | N-15            | ES                         |
| DOOR RELEASE                                               | ~~~~~~       | N-15            |                            |
|                                                            |              |                 |                            |

^^^^^

- RISER IS DIAGRAMMATIC ONLY. PROVIDE QUANTITY OF POWER CIRCUITS, HARDWARE MODULES, FIELD DEVICES, ACCESSORIES, WIRE, SECURITY CABLES, SOFTWARE, TESTING, LICENSES, PROGRAMMING, COMMISSIONS ETC, TO ENSURE A FULLY OPERATIONAL SECURITY SYSTEM. REFER TO DRAWING NO. E-017 AND TO FLOOR PLANS FOR ADDITIONAL
- (N-2) REFER TO FLOOR PLAN DRAWINGS FOR DEVICE QUANTITY AND LOCATIONS.
- N-3 PROVIDE WIRES IN ACCORDANCE WITH THE MANUFACTURER'S RECOMMENDATIONS. MINIMUM WIRE REQUIREMENTS AS DETAILED ON RISER.
- N-4 ALL FIELD DEVICE WIRING TO BE PULLED AS HOMERUNS TO RESPECTIVE ACCESS CONTROL PANELS.
- N-5 NOT USED.
- N-6 CONTACT SECURITY MANUFACTURER FOR ADDITIONAL WIRE, CONDUIT, PULLBOX AND POWER REQUIREMENTS OVER AND ABOVE THOSE SHOWN ON DRAWING.
- N-7 PROVIDE DEDICATED FLOOR AND WALL PENETRATIONS. EXACT LOCATION OF ALL CORE DRILLS TO BE DETERMINED BY X-RAY RESULTS. X-RAYS MUST BE REVIEWED AND APPROVED BY LANDLORD AND STRUCTURAL ENGINEER PRIOR TO CORE DRILLING.
- PROVIDE QUANTITY OF CONTROL PANELS AND POWER SUPPLIES REQUIRED FOR A FULLY OPERATIONAL SECURITY SYSTEM. MINIMUM QUANTITY SHOWN.
- N-10 ALL CONTROL PANEL COVERS TO BE EQUIPPED WITH TAMPER SWITCHES.
- N-1) ALL CONDUITS ARE TO BE ROUTED IN THE CEILING SPACE.
- № AS PART OF THIS SCOPE OF WORK SUPPLY FIFTY (50) ACCESS CONTROL SYSTEM KEY CARDS (PROXIMITY FUNCTIONALITY ON EACH AND EVERY KEY CARD). AS PART OF THE BASE BID PRICE TAKE PHOTOS, SET UP AND PROGRAM NEW DATABASE PROVIDED AS PART OF THIS SCOPE OF WORK, PRINT AND SET UP THIRTY-FIVE (35) ACCESS CONTROL SYSTEM KEY CARDS. OBTAIN RESPECTIVE SECURITY LEVEL AND ACCESS PRIVILEGE OF EACH CARD PROGRAMMED AS PART OF THIS SCOPE OF WORK FROM CLIENT. COORDINATE SCHEDULE ON SITE WITH CLIENT PRIOR TO COMMENCING WORK.
- № AS PART OF THIS SCOPE OF WORK PROVIDE SOFTWARE BADGE PHOTO ID CAMERA, CARD PRINTER, REPORT PRINTER, LCD MONITOR, KEYBOARD, MOUSE, SOFTWARE PROGRAM, ETC. REFER TO SPECIFICATIONS FOR ADDITIONAL REQUIREMENTS.
- AS PART OF THIS SCOPE OF WORK PROVIDE AN INTERFACE BETWEEN CARD ACCESS CONTROL SYSTEM PROVIDED AS PART OF THIS SCOPE OF WORK AND CCTV SYSTEM PROVIDED AS PART OF THIS SCOPE OF WORK SUCH THAT THE CCTV SYSTEM IS INTERFACED WITH THE CARD ACCESS CONTROL SYSTEM PROVIDED AS PART OF THIS SCOPE OF WORK. PROVIDE ALL CARD ACCESS CONTROL SYSTEM AND CCTV SYSTEM LICENSES AND PROGRAMMING. PROVIDE ALL REQUIRED CARD ACCESS CONTROL SYSTEM COMPONENTS, ACCESSORIES, WIRING, OUTPUT CONTACTS, INPUT CONTACTS, ETC. FOR A FULLY OPERATIONAL SYSTEM.
- PROVIDE ACCESS CONTROL SYSTEM DEVICE INDICATED AS PART OF THIS SCOPE OF WORK. MODEL NUMBERS TO BE DETERMINED DURING CONSTRUCTION. NOT USED.
- (N-1) NOT USED.
- № EACH AND EVERY CONTROL PANEL PROVIDED AS PART OF THIS SCOPE OF WORK MUST BE FULLY CONFIGURED WITH ALL MODULES, ACCESSORIES, ETC. FOR EIGHT (8) CARD READERS.
- N-19 REFER TO REGIONAL MUNICIPALITY OF DURHAM CORPORATE POLICY AND PROCEDURES MANUAL - SECURITY SERVICES INSTALLATION AND SECURITY SYSTEM STANDARDS, GUIDELINE FOR ADDITIONAL REQUIREMENTS INCLUDING BUT NOT LIMITED TO APPROVED EQUIPMENT RACK/CABINET SELECTIONS, LABELING REQUIREMENTS, ETC OVER AND ABOVE THOSE DETAILED IN THIS DRAWING PACKAGE AND IN THE ELECTRICAL SPECIFICATIONS BOOK. CONTRACTOR SHALL BE RESPONSIBLE FOR AND MUST INCLUDE IN BASE BID PRICE FOR ALL SCOPES OF WORK DETAILED IN THE REGIONAL MUNICIPALITY OF DURHAM CORPORATE POLICY AND PROCEDURES MANUAL - SECURITY SERVICES INSTALLATION AND SECURITY SYSTEM STANDARDS, GUIDELINE, ELECTRICAL DRAWINGS AND ELECTRICAL SPECIFICATIONS BOOK. CONTACT REGIONAL MUNICIPALITY OF DURHAM SECURITY SERVICES SUPERVISOR @ SECURITY@DURHAM.CA FOR QUESTIONS REGARDING REGIONAL MUNICIPALITY OF DURHAM CORPORATE POLICY AND PROCEDURES MANUAL - SECURITY SERVICES INSTALLATION AND SECURITY SYSTEM STANDARDS, GUIDELINE DOCUMENT.

AS PART OF THIS SCOPE OF WORK SET UP ACCESS CONTROL SYSTEM KEY CARDS PROVIDED AS PART OF THIS SCOPE OF WORK, INCLUDING TAKING EMPLOYEE PHOTOS AND SETTING UP AND PROGRAMING NEW DATABASE PROVIDED AS PART OF THIS SCOPE OF WORK. ELECTRICAL CONTRACTOR SHALL COORDINATE, ORGANIZE AND SCHEDULE TIME TO TAKE PHOTOS OF ALL STAFF AT THE SITE. PROVIDE A BLUE CURTAIN BACKDROP, ALL REQUIRED LIGHTING AND ALL OTHER EQUIPMENT REQUIRED FOR PHOTO TAKING.

ALL MEASUREMENTS ARE TO BE VERIFIED BY THE CONTRACTOR ON SITE AND ANY DISCREPANCIES ARE TO BE REPORTED BEFORE PROCEEDING WITH THE WORK. THE REGION OF DURHAM ASSUMES NO RESPONSIBILITY FOR THE ACCURACY OF THE LOCATION OF EXISTING SERVICES AS INDICATED ON THIS DRAWING. DO NOT SCALE DRAWINGS.

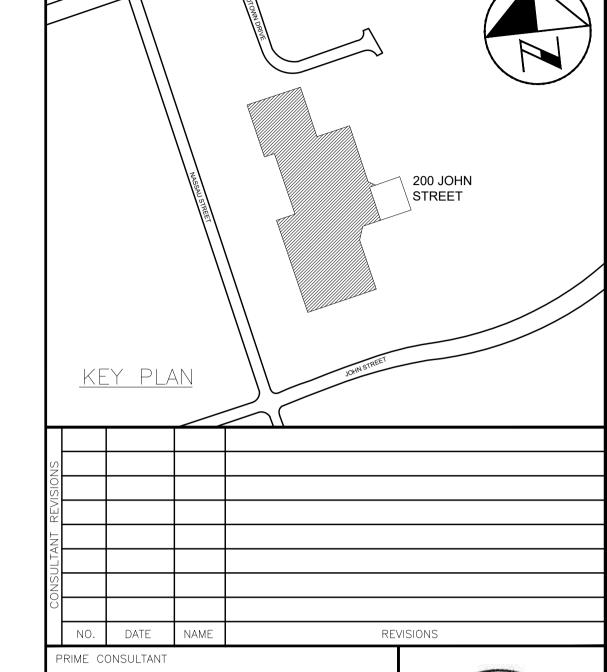

**ASSOCIATES** Project Managers Whitby, Ontario L1N 0G5 Tel: (905) 666-5252 Fax: (905) 666-5256 e-mail: bba@bba-archeng.com



SUB-CONSULTANT

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HCC ENGINEERING LIMITED 40 EGLINTON AVENUE EAST, SUITE 600 TORONTO, ONTARIO, M4P 3A2 Tel: (416) 932-2423



HCC Project No.: 20104

|          | DESIGN BY: PC      |            |      |              | SCALE N.T.S.                 |
|----------|--------------------|------------|------|--------------|------------------------------|
|          | DRAWN BY: TLR      |            |      |              | DATE: 2020-05-01             |
| С        | CHECKED BY: PC/HDC |            |      |              | consultant project no. 20060 |
| А        | PPROVE             | D BY: HDC  | ;    |              |                              |
| Г        |                    |            |      |              |                              |
|          |                    |            |      |              |                              |
| VISIONS  |                    |            |      |              |                              |
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| $\vdash$ | 4                  | MAY02/2021 | HCC  | ISSUED FOR A | DDENDUM #E-01                |
| RAC      | 3                  | FEB09/2021 | HCC  | ISSUED FOR F | PERMIT & TENDER              |
| ONT      | 2                  | OCT30/2020 | HCC  | ISSUED FOR 9 | 00% REVIEW                   |
| Ö        | 1                  | JUNE 1/20  | HCC  | ISSUED FOR 6 | 50% REVIEW                   |
|          | NO.                | DATE       | NAME |              | REVISIONS                    |



THE REGIONAL MUNICIPALITY OF DURHAM

WORKS DEPARTMENT

DESIGN, CONSTRUCTION & ASSET MANAGEMENT

RELOCATION OF DENTAL CLINIC ! TO 200 JOHN ST., OSHAWA

ACCESS CONTROL SYSTEM RISER DIAGRAM

| property no.<br>N/A | facility code<br>LEA-0-07 | FACILITIES PROJECT NO.<br>LEA-0-07-19-01 |
|---------------------|---------------------------|------------------------------------------|
| CONTRACT NO.        | DRAWING NO.               | SHEET NO.                                |
| T-1032-2021         | E-018                     | 051                                      |

- N-1) RISER IS DIAGRAMMATIC ONLY. PROVIDE QUANTITY OF CONTROL PANELS, HARDWARE, DEVICES, POWER CIRCUITS, CONDUIT, WIRE, SECURITY CABLES, ETC, TO ENSURE A FULLY OPERATIONAL SECURITY SYSTEM INTRUSION AND CARD ACCESS CONTROL SYSTEM. MINIMUM REQUIREMENTS DETAILED ON DRAWING.
- N-2) REFER TO FLOOR PLAN DRAWINGS FOR DEVICE QUANTITY AND LOCATIONS.
- (N-3) PROVIDE CONDUITS AND WIRES IN ACCORDANCE WITH THE MANUFACTURER'S RECOMMENDATIONS. MINIMUM CONDUIT SIZE AND WIRING REQUIREMENTS AS DETAILED ON RISER DIAGRAM.
- N-4 ALL INTRUSION SYSTEM DEVICES TO BE PULLED AS HOMERUNS TO ZONE EXPANDER. DO NOT DAISY CHAIN SECURITY SYSTEM INTRUSION BUS (COMBUS) BETWEEN DEVICES. TERMINATE ALL WIRING ONTO TERMINAL STRIPS AND LOOP WIRING AS REQUIRED AT JUNCTION BOX.
- N-5 ALL CONDUITS TO BE EMT. EMT COUPLING AND CONNECTORS SHALL BE T&B STEEL, SET SCREW TYPE. PROVIDE SPARE PULLSTRING IN ALL CONDUITS FOR FUTURE USE.
- N-6 ELECTRICAL CONTRACTOR SHALL NOT USE PULLBOXES AS SUBSTITUTES FOR 90° BENDS. 12" X 12" X 6" PULLBOXES C/W TYPE SNAKE EYE SECURITY SCREWS SHALL BE PROVIDED ON THE BASIS OF NOT MORE THAN TWO (2) RIGHT ANGLE BENDS OR NOT MORE THAN 100' IN STRAIGHT RUNS BETWEEN BOXES.
- N-7) CONTACT SECURITY MANUFACTURER FOR ADDITIONAL WIRE, CONDUIT, PULLBOX AND POWER REQUIREMENTS.
- N-8 ALL CONTROL PANEL COVERS TO BE EQUIPPED WITH TAMPER SWITCHES.
- EACH FIELD DEVICE SHALL BE PROGRAMMED AS AN INDIVIDUAL HARDWIRED ZONE. REFER TO SPECIFICATIONS FOR ADDITIONAL REQUIREMENTS.

  PROVIDE INTRUSION SYSTEM DEVICE INDICATED AS PART OF THIS SCOPE OF WORK. MODEL NUMBERS TO BE DETERMINED DURING CONSTRUCTION.
  - (N-1) PROVIDE END OF LINE RESISTOR FOR EACH STROBE CIRCUIT.
  - N-12 PROVIDE ALL HARDWARE AND SOFTWARE REQUIRED TO FULLY INTEGRATE THE ACCESS CONTROL SYSTEM PROVIDED AS PART OF THIS SCOPE OF WORK WITH THE INTRUSION SYSTEM PROVIDED AS PART OF THIS SCOPE OF WORK.
  - (13) ACTIVATION OF PANIC BUTTON SHALL INITIATE THE CALL TO MONITORING STATION AND
- POLICE STATION. PROVIDE PROGRAMMING, SOFTWARE, HARDWARE, ETC. AS REQUIRED. № UPON DETECTION OF AUTOMATED EXTERNAL DEFIBRILLATOR (AED) USE, THE INTRUSION SYSTEM SHALL INITIATE THE CALL TO MONITORING STATION AND POLICE
- /2\\_\_\_\_STATION\_PROVIDE\_PROGRAMMING\_SOFTWARE\_HARDWARE\_ETG\_AS\_REQUIRED\_\_\_\_\_ PROVIDE OUTPUT, WIRE AND CONDUIT TO ULC SECURE LINE FOR OFFSITE MONITORING. COORDINATE EXACT TERMINATION REQUIREMENTS ON SITE. WIRE IN ACCORDANCE WITH MANUFACTURER'S RECOMMENDATIONS.

| $\sqrt{2}$ | <u>~~</u> | ~~~       | ~~~    | ~~~     | ~~~   | <b>~~~</b> | ~  | <b>~</b> | <b>~</b> | ~~   | ~~    | ~  | ~~~~~ |
|------------|-----------|-----------|--------|---------|-------|------------|----|----------|----------|------|-------|----|-------|
|            | ①         | INTRUSION | SYSTEM | CONTROL | PANEL | PROVIDED   | AS | PART     | OF       | THIS | SCOPE | OF | WORK  |

O NOT USED. 2 3 SECURITY SYSTEM COMMUNICATION BUS (WIRING PER MANUFACTURER'S RECOMMENDATION) - 3/4"C

- (4) 2 PAIR #18AWG, PLENUM RATED, -3/4°C
- (5) INTRUSION CONTROL PANEL ZONE EXPANDER C/W ENCLOSURE
- 24VDC POWER SUPPLY FOR STROBE LIGHTS
- AUTOMATED EXTERNAL DEFIBRILLATOR (AED) 4

  GSM CELLULAR COMMUNICATIONS MODULE PROVIDED AS PART OF THIS SCOPE DE WORK


DENOTES NEW PROVIDED BY ELECTRICAL CONTRACTOR

---- DENOTES EXISTING TO REMAIN

-x-x-x-x-x-x-x- DENOTES EXISTING TO BE REMOVED BY ELECTRICAL CONTRACTOR

| DEVICE TYPE PROVIDED AS PART OF THIS SCOPE OF WORK | MANUFACTURER | SERIES / PART # | DRAWING SYMBOL / REFERENCE                    |
|----------------------------------------------------|--------------|-----------------|-----------------------------------------------|
| INTRUSION SYSTEM CONTROL PANEL                     |              | <b>№</b> -10    |                                               |
| POWER SUPPLY FOR STROBE LIGHTS                     | ALTRONIX     | AL125UL         |                                               |
| INTRUSION SYSTEM MOTION SENSOR                     |              | <b>€</b> -10    | (MS)                                          |
| INTRUSION SYSTEM GLASS BREAK<br>DETECTOR           |              | <b>€</b> -10    | GB                                            |
| INTRUSION SYSTEM PANIC BUTTON                      | POTTER       | HUB-M           | PB                                            |
| INTRUSION SYSTEM STROBE LIGHT                      | POTTER       | CS-24           | <u>                                      </u> |
| INTRUSION SYSTEM DOOR CONTACT                      |              | € <u></u> -10   | KP                                            |
| INTRUSION SYSTEM KEYPAD                            |              | <u>(1-10)</u>   | DC                                            |

ALL MEASUREMENTS ARE TO BE VERIFIED BY THE CONTRACTOR ON SITE AND ANY DISCREPANCIES ARE TO BE REPORTED BEFORE PROCEEDING WITH THE WORK. THE REGION OF DURHAM ASSUMES NO RESPONSIBILITY FOR THE ACCURACY OF THE LOCATION OF EXISTING SERVICES AS INDICATED ON THIS DRAWING. DO NOT SCALE DRAWINGS.

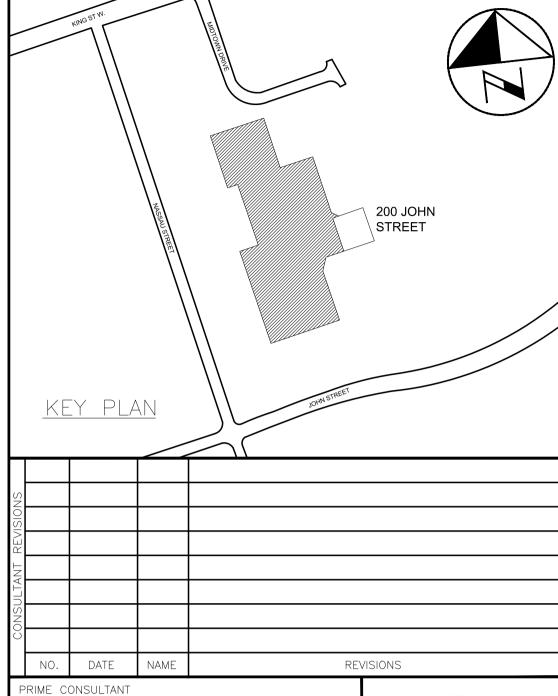




ASSOCIATES Project Managers L1N 0G5 Fax: (905) 666-5256



SUB-CONSULTANT

# HCC ENGINEERING DESIGN AND TECHNOLOGY SERVICES GROUP

HCC ENGINEERING LIMITED 40 EGLINTON AVENUE EAST, SUITE 600 TORONTO, ONTARIO, M4P 3A2

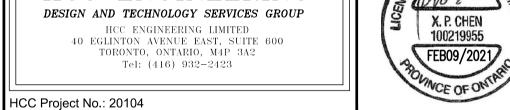

| •                  |                              |
|--------------------|------------------------------|
| DESIGN BY: PC      | SCALE N.T.S.                 |
| DRAWN BY: TLR      | DATE: <b>2020-05-01</b>      |
| CHECKED BY: PC/HDC | consultant project no. 20060 |
| APPROVED BY: LIDO  |                              |

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|----------|---------------|-------------------|------|----------------------------|
|          | approve       | ED BY: <b>HDC</b> | ;    |                            |
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| FIACO    | $\frac{1}{2}$ | MAY02/2021        | HCC  | ISSUED FOR ADDENDUM #E-01  |
| (        | 1             | FEB09/2021        | HCC  | ISSUED FOR PERMIT & TENDER |
| 1        | NO            | DATE              | NAME | REVISIONS                  |




THE REGIONAL MUNICIPALITY OF DURHAM

WORKS DEPARTMENT DESIGN, CONSTRUCTION & ASSET MANAGEMENT

RELOCATION OF DENTAL CLINIC TO 200 JOHN ST., OSHAWA

INTRUSION SYSTEM RISER DIAGRAM

| PROPERTY NO. N/A | facility code<br>LEA-0-07 | FACILITIES PROJECT NO. LEA-0-07-19-01 |
|------------------|---------------------------|---------------------------------------|
| CONTRACT NO.     | DRAWING NO.               | SHEET NO.                             |
| T-1032-2021      | E-019                     | 052                                   |

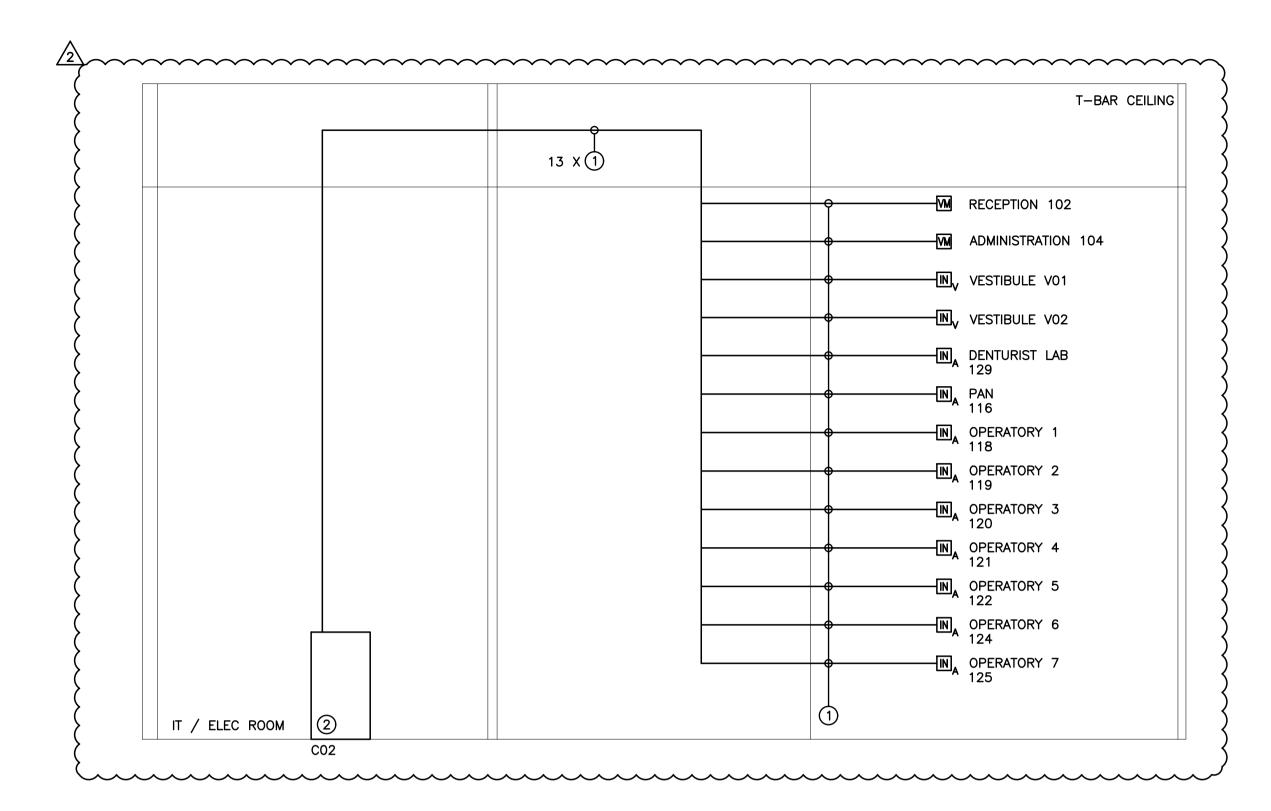

N-1) DETAIL IS DIAGRAMMATIC ONLY. REFER TO DRAWING NO. E-010 FOR ADDITIONAL REQUIREMENTS, DEVICE QUANTITY AND LOCATIONS.

N-2) NOT USED.

N-3) MINIMUM WIRING REQUIREMENTS SHOWN. PROVIDE ADDITIONAL WIRING AS PER

MANUFACTURER'S RECOMMENDATIONS.

(N-4) CONTACT MANUFACTURER FOR SPECIFIC REQUIREMENTS TO TIE IN ALL COMPONENTS. PROVIDE APPROPRIATE ACCESSORIES AS REQUIRED FOR FULLY FUNCTIONAL INTERCOM SYSTEM

N-5) CONFIRM INTERFACE DEVICE REQUIREMENTS PRIOR TO ORDERING.

CONTACT MANUFACTURER FOR SPECIFIC PROGRAMMING REQUIREMENTS REQUIREMENTS TO TIE IN ALL COMPONENTS. PROGRAM COMPONENTS AS REQUIRED FOR FULLY FUNCTIONAL INTERCOM SYSTEM.

AS PART OF THIS SCOPE OF WORK, PROVIDE PROGRAMMING, OUTPUT, HARDWARE, SOFTWARE, ETC., AS REQUIRED TO ENSURE THAT THE VIDEO INTERCOM SYSTEM PROVIDED AS PART OF THIS SCOPE OF WORK COMPLIES WITH THE FOLLOWING SEQUENCE OF OPERATION:

PRESSING ON "VESTIBULE VO1" DOOR STATION ONLY INITIATES COMMUNICATION REQUEST TO VIDEO INTERCOM MASTER STATION IN RECEPTION 102.

PRESSING ON "VESTIBULE VO2" DOOR STATION ONLY INITIATES COMMUNICATION REQUEST TO VIDEO INTERCOM SUB-MASTER STATION IN ADMINISTRATION 104.

PRESS ON "DENTURIST LAB 129", "PAN 116", "OPERATORY 1 118", "OPERATORY 2 119", "OPERATORY 3 120", "OPERATORY 4 121", "OPERATORY 5 122", "OPERATORY 6 124", "OPERATORY 7 125" DOOR STATIONS ONLY INITIATES COMMUNICATION REQUEST TO VIDEO INTERCOM MASTER STATION IN RECEPTION 102 PROVIDE DEDICATED FLOOR AND WALL PENETRATIONS. EXACT LOCATION OF ALL CORE DRILLS TO BE DETERMINED BY X-RAY RESULTS. X-RAYS MUST BE REVIEWED AND APPROVED BY THE LANDLORD AND STRUCTURAL ENGINEER PRIOR TO CORE DRILLING.

PLENUM RATED 4 PAIR CATEGORY 6 UTP DATA CABLE PROVIDED BY COMMUNICATIONS CONTRACTOR. RED IN COLOUR.

2 EQUIPMENT CABINET PROVIDED BY COMMUNICATIONS CONTRACTOR


| DEVICE TYPE PROVIDED AS PART OF THIS SCOPE OF WORK | MANUFACTURER | SERIES / PART # | DRAWING SYMBOL / REFERENCE |  |  |
|----------------------------------------------------|--------------|-----------------|----------------------------|--|--|
| INTERCOM SYSTEM MASTER STATION                     | AIPHONE      | IX-MV7-HB       | VM                         |  |  |
| INTERCOM SYSTEM VIDEO DOOR STATION                 | AIPHONE      | IX-EA           | IN <sub>V</sub>            |  |  |
| INTERCOM SYSTEM AUDIO DOOR STATION                 | AIPHONE      | IX-SS-2G        | VM <sub>A</sub>            |  |  |

DENOTES NEW PROVIDED BY ELECTRICAL CONTRACTOR

---- DENOTES EXISTING TO REMAIN

-x-x-x-x-x-x- DENOTES EXISTING TO BE REMOVED BY ELECTRICAL CONTRACTOR

ALL MEASUREMENTS ARE TO BE VERIFIED BY THE CONTRACTOR ON SITE AND ANY DISCREPANCIES ARE TO BE REPORTED BEFORE PROCEEDING WITH THE WORK. THE REGION OF DURHAM ASSUMES NO RESPONSIBILITY FOR THE ACCURACY OF THE LOCATION OF EXISTING SERVICES AS INDICATED ON THIS DRAWING. DO NOT SCALE DRAWINGS.

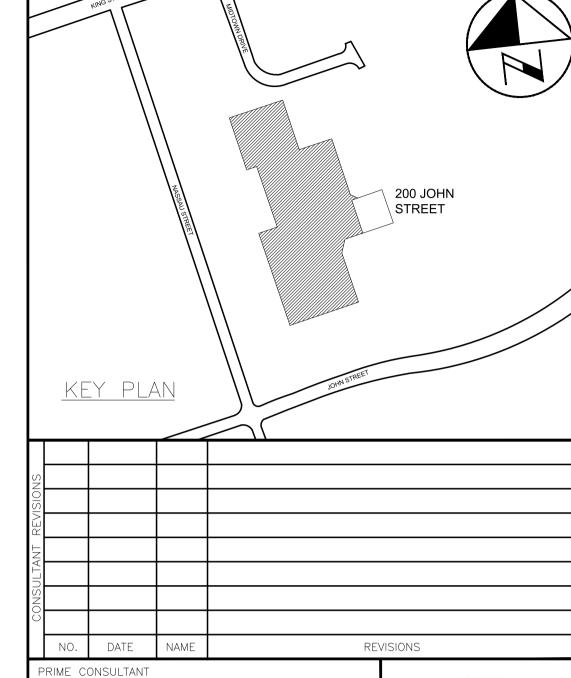



BARRY BRYAN
ASSOCIATES

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Engineers
Project Managers

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SUB-CONSULTANT

# HCC ENGINEERING DESIGN AND TECHNOLOGY SERVICES GROUP

SIGN AND TECHNOLOGY SERVICES GROU HCC ENGINEERING LIMITED 40 EGLINTON AVENUE EAST, SUITE 600 TORONTO, ONTARIO, M4P 3A2 Tel: (416) 932-2423



HCC Project No.: 20104

| DE:           | SIGN  | BY: <b>PC</b> |      |              | SCALE    | N.T.S.            |       |
|---------------|-------|---------------|------|--------------|----------|-------------------|-------|
| DR            | AWN ( | BY: TLR       |      |              | DATE:    | 2020-05-01        |       |
| СН            | ECKE  | BY: PC/       | HDC  |              | CONSU    | LTANT PROJECT NO. | 20060 |
| API           | PROVE | D BY: HDC     |      |              |          |                   |       |
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|               |       | MAY02/2021    | HCC  | ISSUED FOR A | DDENDU   | / #E-01           |       |
| $^{\prime}$ L | 1     | FEB09/2021    | HCC  | ISSUED FOR F | PERMIT & | TENDER            |       |
|               | NO.   | DATE          | NAME |              |          | REVISIONS         |       |



THE REGIONAL MUNICIPALITY
OF DURHAM


WORKS DEPARTMENT

DESIGN, CONSTRUCTION & ASSET MANAGEMENT


RELOCATION OF DENTAL CLINIC TO 200 JOHN ST., OSHAWA

INTERCOM SYSTEM RISER DIAGRAM

| property no.<br>N/A | facility code<br>LEA-0-07 | FACILITIES PROJECT NO. LEA-0-07-19-01 |
|---------------------|---------------------------|---------------------------------------|
| CONTRACT NO.        | DRAWING NO.               | SHEET NO.                             |
| T-1032-2021         | E-020                     | 053                                   |

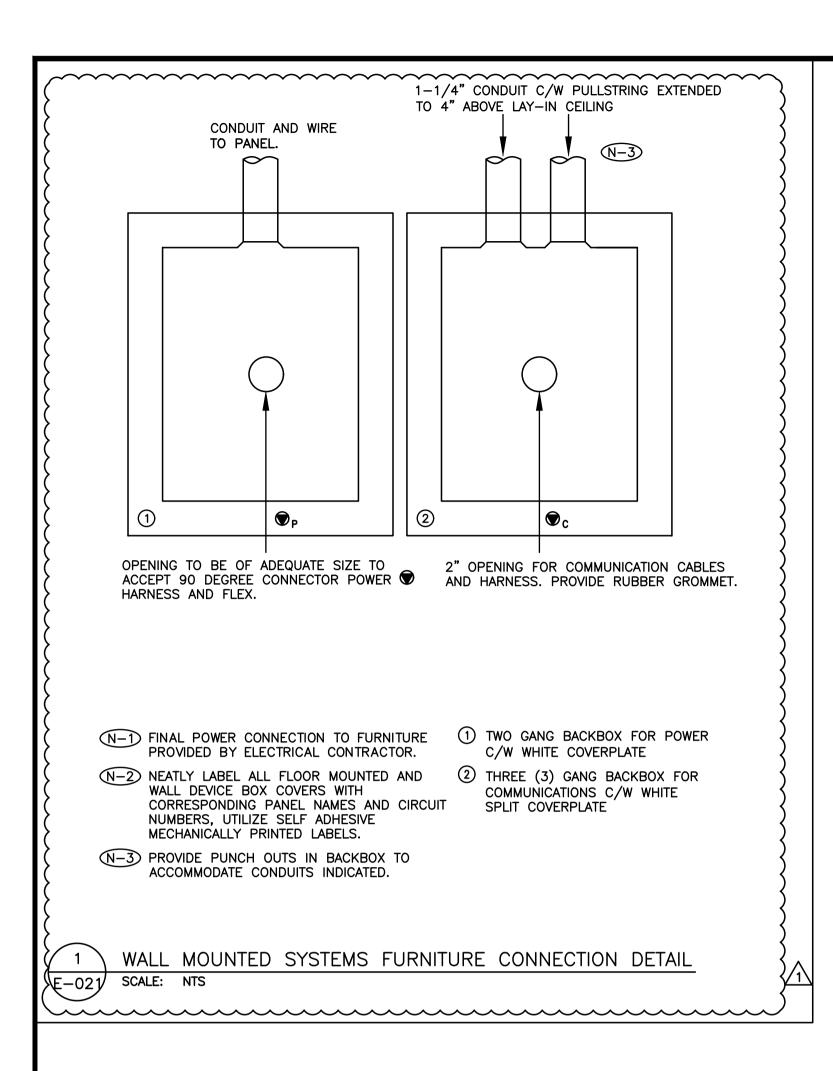

ALL MEASUREMENTS ARE TO BE VERIFIED BY THE CONTRACTOR ON SITE AND ANY DISCREPANCIES ARE TO BE REPORTED BEFORE PROCEEDING WITH THE WORK. THE REGION OF DURHAM ASSUMES NO RESPONSIBILITY FOR THE ACCURACY OF THE LOCATION OF EXISTING SERVICES AS INDICATED ON THIS DRAWING. DO NOT SCALE DRAWINGS.

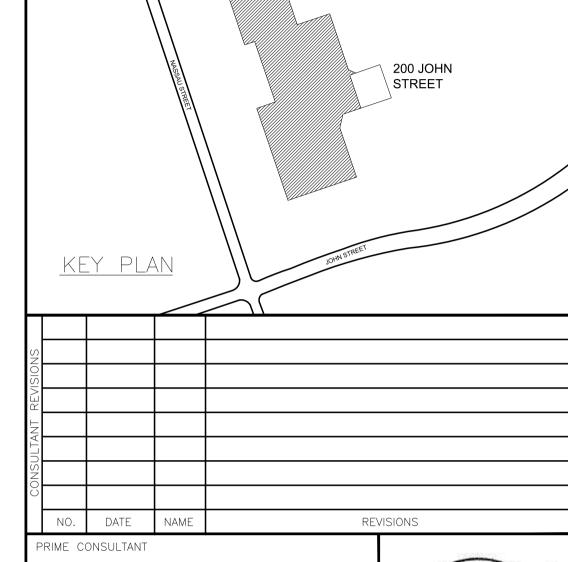



ASSOCIATES Architects Engineers Project Managers Suite 201 Whitby, Ontario L1N 0G5



SUB-CONSULTANT

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TORONTO, ONTARIO, M4P 3A2
Tel: (416) 932–2423



HCC Project No.: 20104

|          | ESIGN              | BY: <b>PC</b>     |      |              | SCALE AS SHOWN        |       |
|----------|--------------------|-------------------|------|--------------|-----------------------|-------|
|          | RAWN I             | BY: TLR           |      |              | DATE: 2020-05-01      |       |
|          | CHECKED BY: PC/HDC |                   |      |              | CONSULTANT PROJECT NO | 20060 |
| Δ        | PPROVE             | ED BY: <b>HDC</b> | ;    |              |                       |       |
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| (0       |                    |                   |      |              |                       |       |
| SNOI     |                    |                   |      |              |                       |       |
| EVISI    |                    |                   |      |              |                       |       |
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| RACT     |                    |                   |      |              |                       |       |
| LNO:     |                    |                   |      |              |                       |       |
| O        | 1                  | MAY02/2021        | HCC  | ISSUED FOR A | DDENDUM #E-01         |       |
|          | NO.                | DATE              | NAME |              | REVISIONS             |       |



THE REGIONAL MUNICIPALITY OF DURHAM

WORKS DEPARTMENT DESIGN, CONSTRUCTION & ASSET MANAGEMENT

RELOCATION OF DENTAL CLINIC TO 200 JOHN ST., OSHAWA

ELECTRICAL DETAILS

| property no.<br>N/A | facility code<br>LEA-0-07 | facilities project no. LEA-0-07-19-01 |
|---------------------|---------------------------|---------------------------------------|
| CONTRACT NO.        | DRAWING NO.               | SHEET NO.                             |
| T-1032-2021         | E-021                     | OXX                                   |

Panelboard: RP-A

Voltage (V): Phase/Wire:

Bus and Lugs Rating (A):

| CCT | Load                            | Break | er   | CCT | Load                           | Break | er            |
|-----|---------------------------------|-------|------|-----|--------------------------------|-------|---------------|
| NO  |                                 | Amp   | Pole | NO  |                                | Amp   | Pole          |
| 1   | LIGHTING                        | 20    | 1    | 2   |                                |       |               |
| 3   | LIGHTING                        | 20    | 1    | 4   |                                |       |               |
| 5   | MAINTENANCE GFI RECEPTACLE (RM) | 20    | 1    | 6   |                                |       |               |
| 7   | HOUSEKEEPING                    | 20    | 1    |     | HWT-2                          | 20    | 1             |
| 9   | EF-3/4                          | 15    | 1    | 10  | VAV-21                         | 15    | $\overline{}$ |
| 11  | EF-5/6/7                        | 15    | 1    | 12  | VAV-21                         | 2     |               |
| 13  | MOJAVE V5                       | 30    |      | 14  | COMPRESSOR ROOM FRIDGE         | 20    | 1             |
| 15  | NOJAVE VS                       |       | 2    | 16  | O&N CLOSET RECEPTACLE          | 20    | 1             |
| 17  | AS50                            | 30    |      | 18  | O&N CLOSET RECEPTACLE          | 20    | 1             |
| 19  | 4350                            |       | 2    | 20  |                                |       |               |
| 21  | AS30                            | 20    |      | 22  |                                |       |               |
| 23  | A530                            |       | 2    | 24  |                                |       |               |
| 25  | ASTA-5                          | 15    |      | 26  | CUSTODIAL GFI RECEPTACLE       | 20    | 1             |
| 27  | A31A-3<br>                      |       | 2    | 28  | HWT-1                          | 15    | 1             |
| 29  |                                 |       |      | 30  | HUMIDIFIER H-1                 | 15    | 1             |
| 31  | VAV-22/23                       | 15    |      | 32  | WOMEN'S W/R SINK SENSOR        | 15    | 1             |
| 33  | VAV-22/23                       |       | 2    | 34  | WOMEN'S W/R TOILET SENSOR      | 15    | 1             |
| 35  | MEETING ROOM OFFICE GROUP       | 20    | 1    | 36  | WOMEN'S W/R GFI RECEPTACLE     | 20    | 1             |
| 37  | MEETING ROOM OFFICE GROUP (PL)  | 20    | 1    | 38  | MEN'S W/R GFI RECEPTACLE       | 20    | 1             |
| 39  | MEETING ROOM OFFICE GROUP       | 20    | 1    | 40  | MEN'S W/R SINK SENSOR          | 15    | 1             |
| 41  | MEETING ROOM OFFICE GROUP (PL)  | 20    | 1    | 42  | MEN'S W/R TOILET/URINAL SENSOR | 15    | 1             |

Panelboard: RP-A

Voltage (V): Phase/Wire:

Bus and Lugs Rating (A):

| CCT | Load                          | Break | er   | CCT | Load                   | Break | er   |
|-----|-------------------------------|-------|------|-----|------------------------|-------|------|
| NO  |                               | Amp   | Pole | NO  |                        | Amp   | Pole |
| 43  | MEETING ROOM FLOOR GROUP      | 20    | 1    | 44  |                        |       |      |
| 45  | MEETING ROOM FLOOR GROUP (PL) | 20    | 1    | 46  |                        |       |      |
| 47  | MEETING ROOM TV               | 20    | 1    | 48  |                        |       |      |
| 49  | BBH-7                         | 15    |      | 50  | DISHWASHER             | 40    |      |
| 51  | 1001 I-7                      |       | 2    | 52  | DISHWASHER             |       | 2    |
| 53  |                               |       |      | 54  | KITCHEN GFI RECEPTACLE | 20    | 1    |
| 55  |                               |       |      | 56  | KITCHEN GFI RECEPTACLE | 20    | 1    |
| 57  | CCH-2                         | 15    |      | 58  | KITCHEN GFI RECEPTACLE | 20    | 1    |
| 59  | GGI 1-2                       |       | 2    | 60  | KITCHEN GFI RECEPTACLE | 20    | 1    |
| 61  | VESTIBULE V02 DOOR OPERATOR   | 15    | 1    |     | KITCHEN GFI RECEPTACLE | 20    | 1    |
| 63  |                               |       |      | 64  | DRYER                  | 30    |      |
| 65  |                               |       |      | 66  | DRIER                  |       | 2    |
| 67  |                               |       |      | 68  | WASHER                 | 20    | 1    |
| 69  |                               |       |      | 70  |                        |       |      |
| 71  |                               |       |      | 72  |                        |       |      |
| 73  | SPARE                         | 15    | 1    | 74  |                        |       |      |
| 75  | SPARE                         | 15    | 1    | 76  | CONTROLS               | 15    | 1    |
| 77  | SPARE                         | 15    | 1    | 78  | CONTROLS               | 15    | 1    |
| 79  | SPARE                         | 20    | 1    | 80  | CONTROLS               | 15    | 1    |
| 81  | SPARE                         | 20    | 1    | 82  | CONTROLS               | 15    | 1    |
| 83  | SPARE                         | 20    | 1    | 84  | CONTROLS               | 15    | 1    |

Panelboard: RP-B

Voltage (V): Phase/Wire:

Bus and Lugs Rating (A):

| CCT | Load                            | Break | Breaker |  | Breaker |                                   | CCT | Load          | Break | er |
|-----|---------------------------------|-------|---------|--|---------|-----------------------------------|-----|---------------|-------|----|
| NO  |                                 | Amp   | Pole    |  | NO      |                                   | Amp | Pole          |       |    |
| 1   |                                 |       |         |  | 2       | OPERATORY 1 AIR PURIFIER          | 20  | 1             |       |    |
| 3   | DOOR OPERATOR                   | 15    | 1       |  | 4       | OPERATORY 1 MISC.                 | 20  | 1             |       |    |
| 5   | MAINTENANCE GFI RECEPTACLE (RM) | 20    | 1       |  | 6       | OPERATORY 1 CHAIR                 | 20  | 1             |       |    |
| 7   |                                 |       |         |  | 8       | OPERATORY 1 X-RAY MACHINE         | 20  | 1             |       |    |
| 9   | AC-2/AC-3                       | 15    |         |  | 10      | OPERATORY 1 COUNTER RECEPTACLES   | 20  | 1             |       |    |
| 11  | AC-2/AC-3                       |       | 2       |  | 12      | OPERATORY 1 CHAIR LIFT            | 15  | 1             |       |    |
| 13  | VAV-3/5                         | 15    |         |  | 14      | VAV-1                             | 20  | $\overline{}$ |       |    |
| 15  | VAV-3/3                         |       | 2       |  | 16      | VAV-1                             |     | 2             |       |    |
| 17  |                                 |       |         |  | 18      | DC BATTERY UNIT M1/NIGHT LIGHTING | 15  | 1             |       |    |
| 19  |                                 |       |         |  | 20      | OPERATORY 2 / 3 MISC.             | 20  | 1             |       |    |
| 21  |                                 |       |         |  | 22      | OPERATORY 2 CHAIR                 | 20  | 1             |       |    |
| 23  |                                 |       |         |  | 24      | OPERATORY 2 X-RAY MACHINE         | 20  | 1             |       |    |
| 25  |                                 |       |         |  | 26      | OPERATORY 2 COUNTER RECEPTACLES   | 20  | 1             |       |    |
| 27  |                                 |       |         |  | 28      | OPERATORY 2 AIR PURIFIER          | 20  | 1             |       |    |
| 29  |                                 |       |         |  | 30      |                                   |     |               |       |    |
| 31  |                                 |       |         |  | 32      |                                   |     |               |       |    |
| 33  | CONTROL CCT                     | 15    | 1       |  | 34      |                                   |     |               |       |    |
| 35  | CONTROL CCT                     | 15    | 1       |  | 36      | OPERATORY 3 AIR PURIFIER          | 20  | 1             |       |    |
| 37  | CONTROL CCT                     | 15    | 1       |  | 38      | OPERATORY 3 CHAIR                 | 20  | 1             |       |    |
| 39  | CONTROL CCT                     | 15    | 1       |  | 40      | OPERATORY 3 X-RAY MACHINE         | 20  | 1             |       |    |
| 41  | CONTROL CCT                     | 15    | 1       |  | 42      | OPERATORY 3 COUNTER RECEPTACLES   | 20  | 1             |       |    |

Panelboard: RP-C

Voltage (V): Phase/Wire:

Bus and Lugs Rating (A):

| CCT | Load                    | Break | Breaker |  | Breaker |                                         | CCT | Load | Break | er |
|-----|-------------------------|-------|---------|--|---------|-----------------------------------------|-----|------|-------|----|
| NO  |                         | Amp   | Pole    |  | NO      |                                         | Amp | Pole |       |    |
| 1   |                         |       |         |  | 2       | DOOR OPERATOR                           | 15  | 1    |       |    |
| 3   |                         |       |         |  | 4       | DOOR OPERATOR                           | 15  | 1    |       |    |
| 5   |                         |       |         |  | 6       |                                         |     |      |       |    |
| 7   |                         |       |         |  | 8       | UNIVERSAL W/R DURESS/LOCK/DOOR OPERATOR | 15  | 1    |       |    |
| 9   | WAITING AREA TV         | 20    | 1       |  | 10      | UNIVERSAL W/R EF-1 / EF-2               | 15  | 1    |       |    |
| 11  | WAITING AREA TV         | 20    | 1       |  | 12      | UNIVERSAL W/R GFI RECEPTACLE            | 20  | 1    |       |    |
| 13  |                         |       |         |  | 14      | UNIVERSAL W/R CHANGE TABLE              | 20  | 1    |       |    |
| 15  | CCH-1                   | 15    | _       |  | 16      |                                         |     |      |       |    |
| 17  | 0011-1                  |       | 2       |  | 18      | DC BATTERY UNIT M2/NIGHT LIGHTING       | 15  | 1    |       |    |
| 19  | BBH-1/BBH-2             | 15    |         |  | 20      |                                         |     |      |       |    |
| 21  | DDI 1- 1/DDI 1-2        |       | 2       |  | 22      |                                         |     |      |       |    |
| 23  | BBH-3/BBH-4/BBH-5       | 15    | /       |  | 24      |                                         |     |      |       |    |
| 25  | 1-3/66  1-4/66  1-3<br> |       | 2       |  | 26      | ADMINISTRATION 104 OFFICE GROUP         | 20  | 1    |       |    |
| 27  |                         |       |         |  | 28      | ADMINISTRATION 104 OFFICE GROUP         | 20  | 1    |       |    |
| 29  |                         |       |         |  | 30      | ADMINISTRATION 104 OFFICE GROUP         | 20  | 1    |       |    |
| 31  | RECEPTION BACK WALL     | 20    | 1       |  | 32      | ADMINISTRATION 104 OFFICE GROUP         | 20  | 1    |       |    |
| 33  | RECEPTION DESK          | 20    | 1       |  | 34      | CONSULT ROOM 1                          | 20  | 1    |       |    |
| 35  | RECEPTION DESK          | 20    | 1       |  | 36      | CONSULT ROOM 2                          | 20  | 1    |       |    |
| 37  |                         |       |         |  | 38      | OFFICE 3                                | 20  | 1    |       |    |
| 39  |                         |       |         |  | 40      | OFFICE 1                                | 20  | 1    |       |    |
| 41  | COPY AREA RECEPTACLE    | 20    | 1       |  | 42      | OFFICE 2                                | 20  | 1    |       |    |

Panelboard: RP-C

Voltage (V): Phase/Wire:

Bus and Lugs Rating (A):

| CCT | Load                      | Breaker |      | CCT | Load                        | Break | er   |
|-----|---------------------------|---------|------|-----|-----------------------------|-------|------|
| NO  |                           | Amp     | Pole | NO  |                             | Amp   | Pole |
| 43  | COPY AREA RECEPTACLE (PL) | 20      | 1    | 44  | AREA 111 WORKSTATIONS       | 15    | 1    |
| 45  | COPY AREA RECEPTACLE (PL) | 20      | 1    | 46  | AREA 111 WORKSTATIONS       | 15    | 1    |
| 47  | COPY AREA RECEPTACLE      | 20      | 1    | 48  | AREA 111 WORKSTATIONS       | 15    | 1    |
| 49  | AREA 111 PRINTER          | 20      | 1    | 50  | AREA 111 WORKSTATIONS       | 15    | 1    |
| 51  | AREA 111 WORKSTATIONS     | 15      | 1    | 52  |                             |       |      |
| 53  | AREA 111 WORKSTATIONS     | 15      | 1    | 54  |                             |       |      |
| 55  | AREA 111 WORKSTATIONS     | 15      | 1    | 56  | AREA 111 WORKSTATIONS       | 15    | 1    |
| 57  | AREA 111 WORKSTATIONS     | 15      | 1    | 58  | AREA 111 WORKSTATIONS       | 15    | 1    |
| 59  | AREA 111 WORKSTATIONS     | 15      | 1    | 60  |                             |       |      |
| 61  | AREA 111 WORKSTATIONS     | 15      | 1    | 62  | AREA 111 WORKSTATIONS       | 15    | 1    |
| 63  |                           |         |      | 64  | AREA 111 WORKSTATIONS       | 15    | 1    |
| 65  |                           |         |      | 66  |                             |       |      |
| 67  | AREA 111 WORKSTATIONS     | 15      | 1    | 68  | PHONE RM 1 & 2 OFFICE GROUP | 20    | 1    |
| 69  | AREA 111 WORKSTATIONS     | 15      | 1    | 70  |                             |       |      |
| 71  | AREA 111 WORKSTATIONS     | 15      | 1    | 72  |                             |       |      |
| 73  | AREA 111 WORKSTATIONS     | 15      | 1    | 74  |                             |       |      |
| 75  |                           |         |      | 76  | HOUSEKEEPING                | 20    | 1    |
| 77  |                           |         |      | 78  | HOUSEKEEPING                | 20    | 1    |
| 79  | SPARE                     | 15      | 1    | 80  | SPARE                       | 20    | 1    |
| 81  | SPARE                     | 15      | 1    | 82  | SPARE                       | 20    | 1    |
| 83  | SPARE                     | 15      | 1    | 84  | SPARE                       | 20    | 1    |

Panelboard: RP-B

Voltage (V): Phase/Wire:

Bus and Lugs Rating (A):

| CCT | Load                            | Break | Breaker |  | Breaker |                                 | CCT | Load | Break | er |
|-----|---------------------------------|-------|---------|--|---------|---------------------------------|-----|------|-------|----|
| NO  |                                 | Amp   | Pole    |  | NO      |                                 | Amp | Pole |       |    |
| 43  | OPERATORY 4 COUNTER RECEPTACLES | 20    | 1       |  | 44      | OPERATORY 7 COUNTER RECEPTACLES | 20  | 1    |       |    |
| 45  | OPERATORY 4 / 5 MISC.           | 20    | 1       |  | 46      | OPERATORY 7 X-RAY MACHINE       | 20  | 1    |       |    |
| 47  | OPERATORY 4 X-RAY MACHINE       | 20    | 1       |  | 48      | OPERATORY 7 CHAIR               | 20  | 1    |       |    |
| 49  | OPERATORY 4 CHAIR               | 20    | 1       |  | 50      | OPERATORY 7 AIR PURIFIER        | 20  | 1    |       |    |
| 51  | OPERATORY 4 AIR PURIFIER        | 20    | 1       |  | 52      |                                 |     |      |       |    |
| 53  | VAV-7/9                         | 15    | /       |  | 54      |                                 |     |      |       |    |
| 55  | VAV-1/9                         |       | 2       |  | 56      |                                 |     |      |       |    |
| 57  | VAV-11/13                       | 15    | /       |  | 58      |                                 |     |      |       |    |
| 59  | VAV 11/10                       |       | 2       |  | 60      |                                 | 20  |      |       |    |
| 61  | OPERATORY 5 X-RAY MACHINE       | 20    | 1       |  | 62      | PAN. 116 X-RAY MACHINE          | /   |      |       |    |
| 63  | OPERATORY 5 COUNTER RECEPTACLES | 20    | 1       |  | 64      |                                 |     | 3    |       |    |
| 65  | OPERATORY 5 CHAIR               | 20    | 1       |  | 66      | PAN. 116 OFFICE GROUP           | 20  | 1    |       |    |
| 67  | OPERATORY 5 AIR PURIFIER        | 20    | 1       |  | 68      | PAN. 116 OFFICE GROUP           | 20  | 1    |       |    |
| 69  |                                 |       |         |  | 70      |                                 |     |      |       |    |
| 71  |                                 |       |         |  | 72      |                                 |     |      |       |    |
| 73  | OPERATORY 6 / 7 MISC.           | 20    | 1       |  | 74      |                                 |     |      |       |    |
| 75  | OPERATORY 6 X-RAY MACHINE       | 20    | 1       |  | 76      |                                 |     |      |       |    |
| 77  | OPERATORY 6 COUNTER RECEPTACLES | 20    | 1       |  | 78      | HOUSEKEEPING                    | 20  | 1    |       |    |
| 79  |                                 |       |         |  | 80      | SPARE                           | 20  | 1    |       |    |
| 81  | OPERATORY 6 CHAIR               | 20    | 1       |  | 82      | SPARE                           | 20  | 1    |       |    |
| 83  | OPERATORY 6 AIR PURIFIER        | 20    | 1       |  | 84      | SPARE                           | 20  | 1    |       |    |

Panelboard: RP-D

Voltage (V): Phase/Wire:

Bus and Lugs Rating (A):

| CCT | Load                           | Breaker  | ССТ | Load                            | Breaker  |
|-----|--------------------------------|----------|-----|---------------------------------|----------|
| NO  |                                | Amp Pole | NO  |                                 | Amp Pole |
| 1   | STERILIZATION ROOM RECEPTACLE  | 20       |     | 2 DENTURIST COUNTER RECEPTACLE  | 20 1     |
| 3   | 3 TERILIZATION ROOM RECEPTABLE | 2        |     | 4 DENTURIST COUNTER RECEPTACLE  | 20 1     |
| 5   | STERILIZATION ROOM RECEPTACLE  | 20       |     | 6 DENTURIST COUNTER RECEPTACLE  | 20 1     |
| 7   | STERIEIZATION ROOM RECEPTACEE  | 2        |     | 8 DENTURIST COUNTER RECEPTACLE  | 20 1     |
| 9   | STERILIZATION ROOM RECEPTACLE  | 20       | ,   | DENTURIST COUNTER RECEPTACLE    | 20       |
| 11  | STERIEIZATION ROOM RECEPTAGE   | 2        | ,   | 2 DENTORIST COONTER RECEPTABLE  | 2        |
| 13  | STERILIZATION ROOM RECEPTACLE  | 20       | ,   | 4 DENTURIST COUNTER RECEPTACLE  | 20 1     |
| 15  | STERILIZATION ROOM RECEPTAGLE  | 2        | ,   | 6 DENTURIST COUNTER RECEPTACLE  | 20 1     |
| 17  |                                | 20       | ,   | 8 DENTURIST COUNTER RECEPTACLE  | 20 1     |
| 19  |                                | 2        | 2   | DENTURIST COUNTER RECEPTACLE    | 20 1     |
| 21  | STERILIZATION ROOM RECEPTACLE  | 20       | 2   | 2 DENTURIST COUNTER RECEPTACLE  | 20 1     |
| 23  | STERILIZATION ROOM RECEPTAGLE  | 2        | 2   | DENTURIST COUNTER RECEPTACLE    | 20       |
| 25  | STERILIZATION ROOM RECEPTACLE  | 20 1     | 2   | 26 DENTORIST COUNTER RECEPTABLE | 2        |
| 27  | STERILIZATION ROOM RECEPTACLE  | 20 1     | 2   | 8 DENTURIST MISC.               | 20 1     |
| 29  | STERILIZATION ROOM RECEPTACLE  | 20 1     | 3   | DENTURIST MISC.                 | 20 1     |
| 31  | STERILIZATION ROOM RECEPTACLE  | 20 1     | 3   | 52 FUME HOOD                    | 30 1     |
| 33  | STERILIZATION ROOM RECEPTACLE  | 20 1     | 3   | 4 DUST COLLECTOR                | 30 1     |
| 35  | STERILIZATION ROOM RECEPTACLE  | 20 1     | 3   | 6 FURNACE                       | 30 1     |
| 37  | STERILIZATION ROOM RECEPTACLE  | 20 1     | 3   | 88                              |          |
| 39  | STERILIZATION ROOM WASHER      | 30       | 4   | 10                              |          |
| 41  | STERILIZATION ROOM WASHER      | 2        | 4   | .2                              |          |

Panelboard: RP-D

Voltage (V): Phase/Wire:

Bus and Lugs Rating (A):

| CCT | Load                     | Breaker |      | CCT | Load                           | Break | er   |
|-----|--------------------------|---------|------|-----|--------------------------------|-------|------|
| NO  |                          | Amp     | Pole | NO  |                                | Amp   | Pole |
| 43  | TIME CLOCK - EF          | 15      | 1    | 44  | C01 RECEPTACLE                 | 20    | 1    |
| 45  | FIRE ALARM BOOSTER PANEL | 15      | 1    | 46  | C01 RECEPTACLE                 | 20    | 1    |
| 47  | FIRE ALARM BOOSTER PANEL | 15      | 1    | 48  | C02 RECEPTACLE                 | 20    | 1    |
| 49  |                          |         |      | 50  | C02 RECEPTACLE                 | 20    | 1    |
| 51  |                          |         |      | 52  | ELEC/IT ROOM MISC              | 20    | 1    |
| 53  |                          |         |      | 54  | ELEC/IT ROOM SECURITY          | 20    | 1    |
| 55  |                          |         |      | 56  | ELEC/IT ROOM SECURITY          | 20    | 1    |
| 57  |                          |         |      | 58  | ELEC/IT ROOM SECURITY          | 20    | 1    |
| 59  |                          |         |      | 60  | ELEC/IT ROOM SECURITY          | 20    | 1    |
| 61  |                          |         |      | 62  | INTRUSION SYSTEM CONTROL PANEL | 15    | 1    |
| 63  |                          |         |      | 64  | INTRUSION SYSTEM ZONE EXPANDER | 15    | 1    |
| 65  |                          |         |      | 66  | INTRUSION SYSTEM ZONE EXPANDER | 15    | 1    |
| 67  |                          |         |      | 68  |                                |       |      |
| 69  |                          |         |      | 70  |                                |       |      |
| 71  |                          |         |      | 72  |                                |       |      |
| 73  |                          |         |      | 74  |                                |       |      |
| 75  |                          |         |      | 76  |                                |       |      |
| 77  |                          |         |      | 78  |                                |       |      |
| 79  |                          |         |      | 80  |                                |       |      |
| 81  |                          |         |      | 82  |                                |       |      |
| 83  |                          |         |      | 84  |                                |       |      |

#### 1 General

#### 1.1 Section includes

.1 Cash allowances.

#### 1.2 Cash allowances

- .1 Consultant Responsibilities:
  - .1 Consult with Contractor for consideration and selection of Products, suppliers, and installers.
  - .2 Owner and Consultant to select Products.
  - .3 Prepare Change Order.
- .2 Contractor Responsibilities:
  - .1 Assist Consultant in selection of Products, suppliers and installers.
  - .2 Obtain proposals from suppliers and installers and offer recommendations.
  - On notification of selection by Consultant or Owner, execute purchase agreement with designated supplier and installer.
  - .4 Arrange for and process shop drawings, product data, and samples. Arrange for delivery.
  - .5 Promptly inspect Products upon delivery for completeness,damage, and defects. Submit claims for transportation damage.
- .3 Supply-only cash allowances shall include:
  - .1 Net cost of products
  - .2 Delivery to Site
  - .3 Applicable taxes and duties, excluding HST
  - .4 Supply and install cash allowances shall include:
  - .5 Net cost of Products
  - .6 Delivery to Site
  - .7 Unloading, storing, handling or Products on Site
  - .8 Installation, finishing and commissioning of Products
  - .9 Applicable taxes and duties, excluding HST
  - .10 Inspection and testing allowances shall include:

- .11 Net cost of inspection and testing services
- .12 Applicable taxes and duties, excluding HST
- .4 Include cash allowances in the Contract Price. Differences in costs will be adjusted by Change Order.
- .5 Allowances Schedule:
  - .1 Include a cash allowance of \$180,000.00 for purchase, delivery, and installation of Office Furniture.
  - .2 Include a cash allowance of \$67,000.00 for purchase, delivery, and installation of Security Systems and Services.
  - .3 Include a cash allowance of \$5,000.00 for testing agencies not specified in the contract bid price.

#### 1.3 Use of cash allowances

- .1 Expenditures against cash allowance will be made only upon receipt of written authority from the Owner.
- .2 No expenditure against a cash allowance shall be made or incurred except as instructed by the Owner in writing.
- .3 Submit copies of all invoices for labour, materials and equipment to the Owner to substantiate charges against the allowances.
- .4 Any unused portion of cash allowances will be credited to the Region upon completion of the Work.
- .5 The cash allowances do not include Harmonized Sales Tax (HST)

#### 2 Products – not used

#### 3 Execution – not used

#### **End of section**